

Appendix G

Construction Engineering Drawings

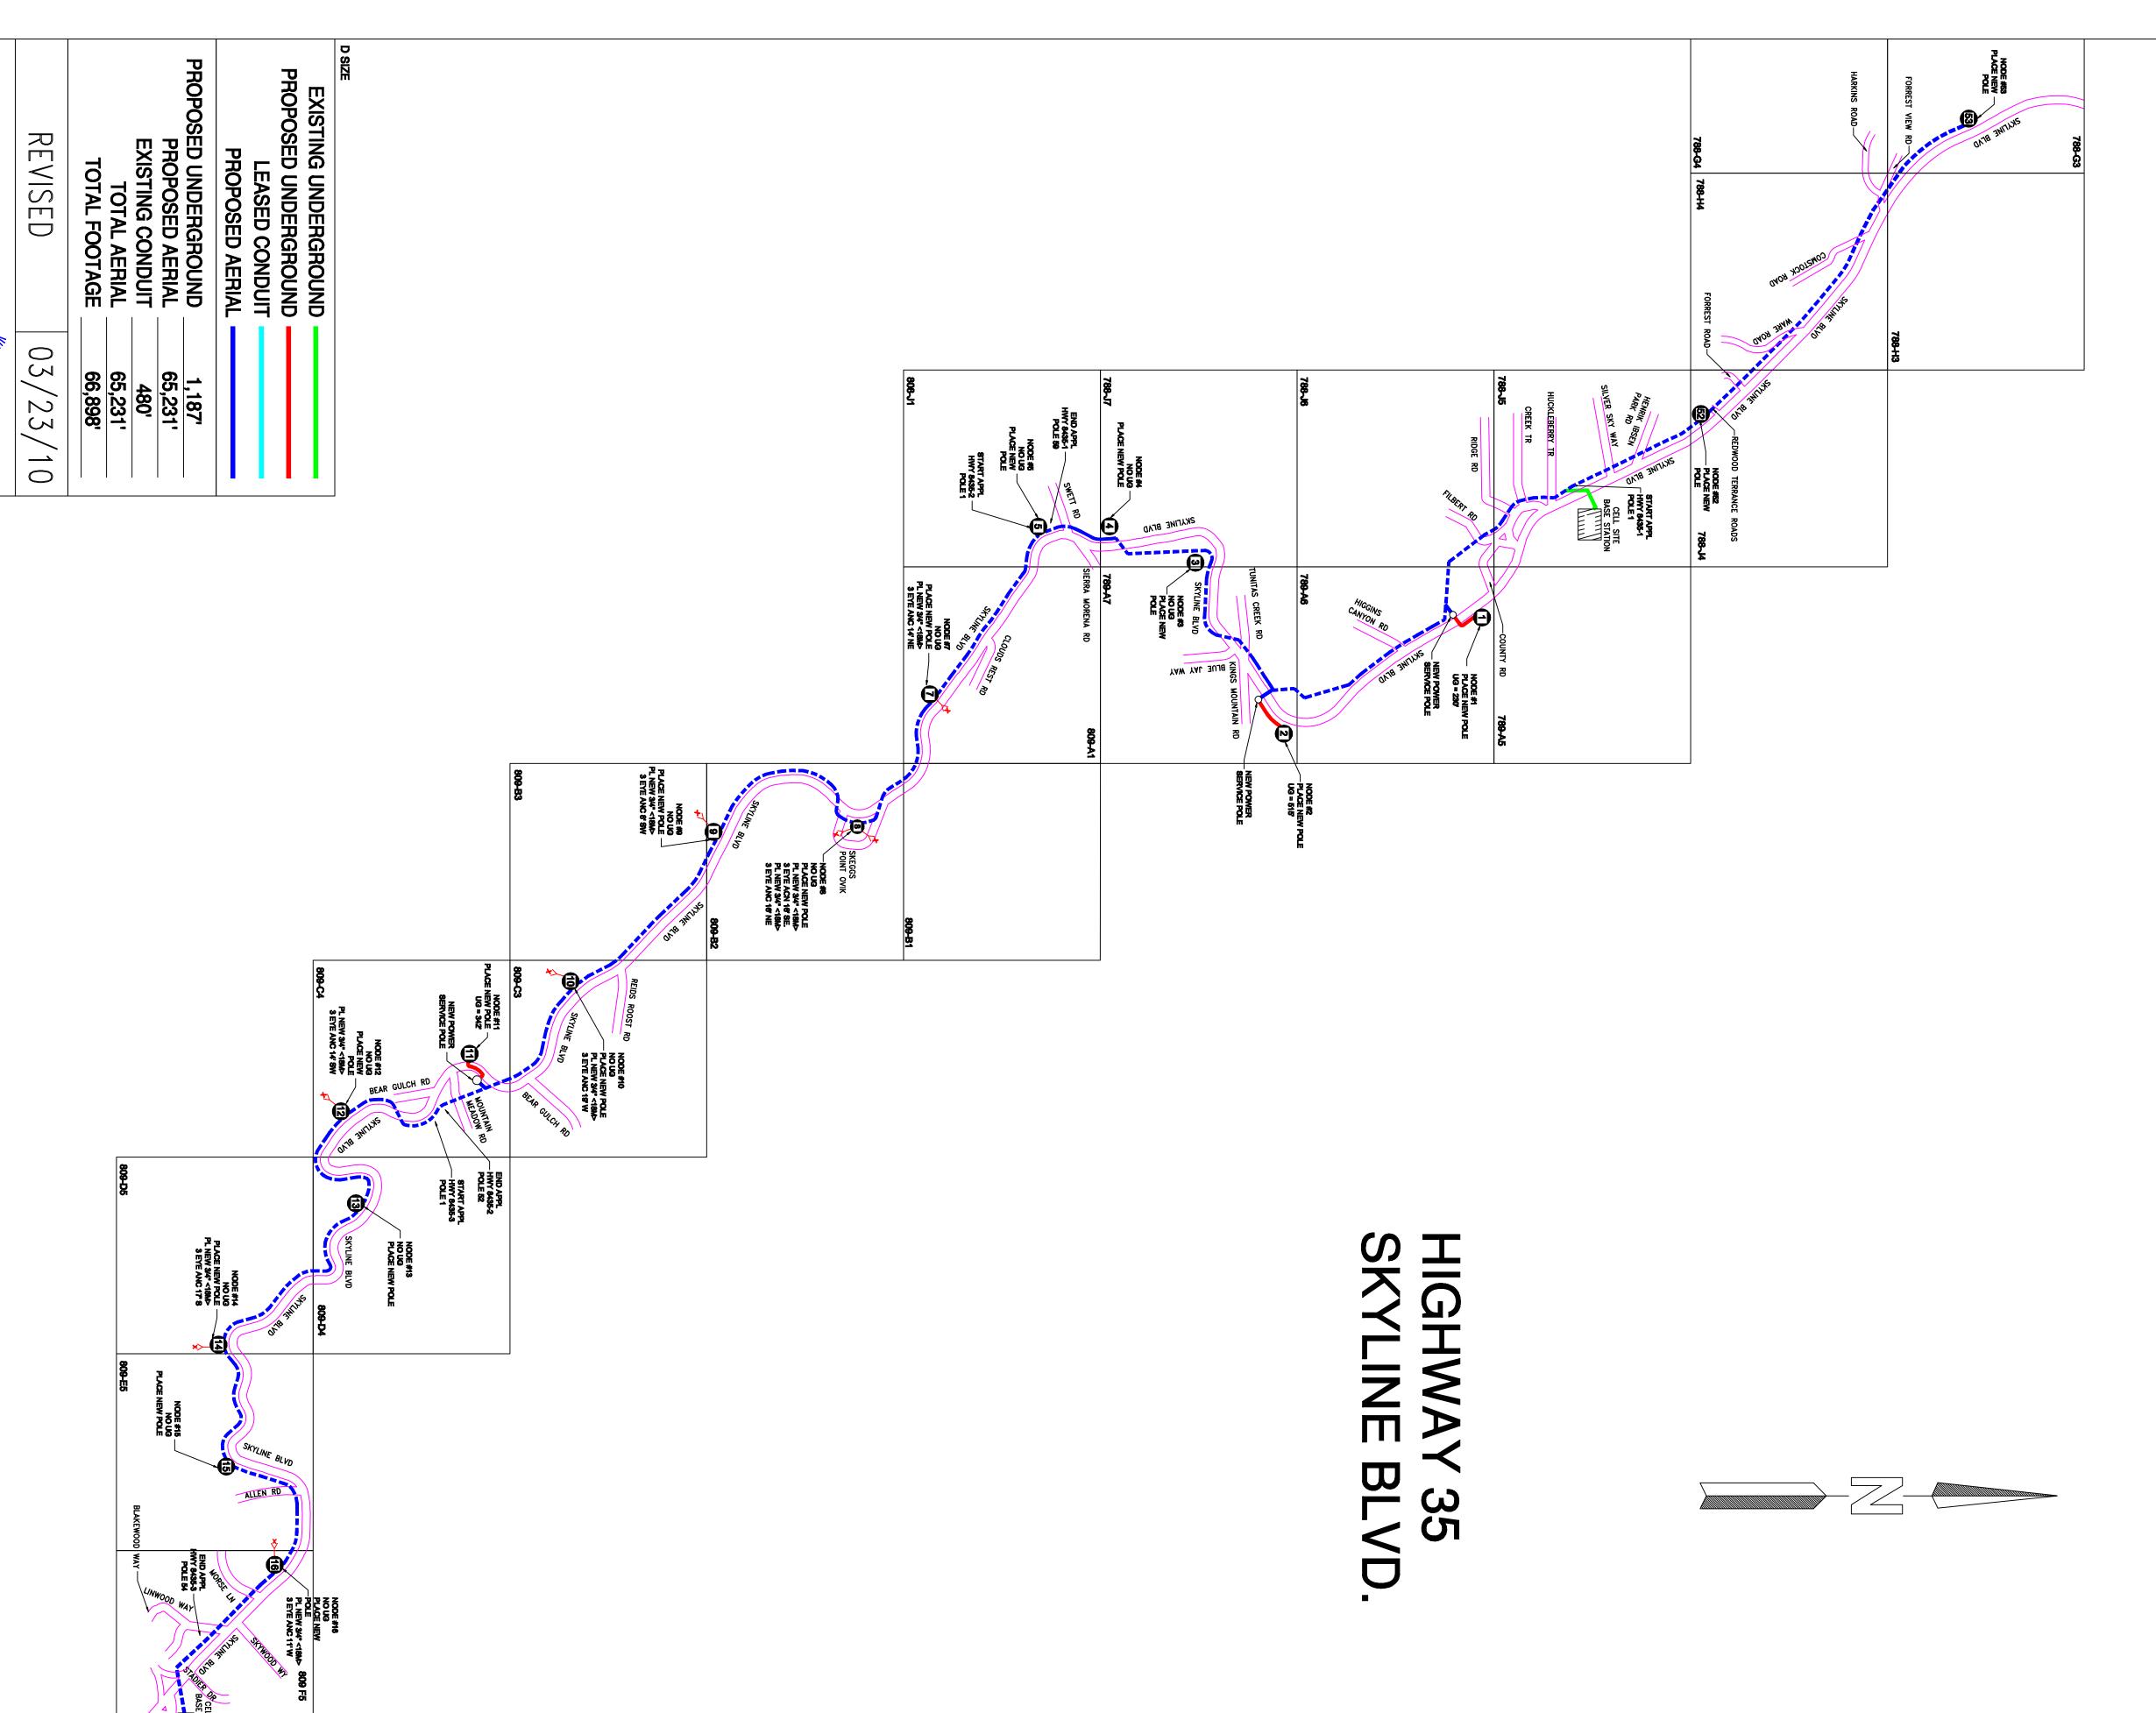



LIGHTWAVE, INC.
CTION FOR TOMORROW....TODAY!
JE ST, SAN MATEO, CA 94402
(650) 286-9977

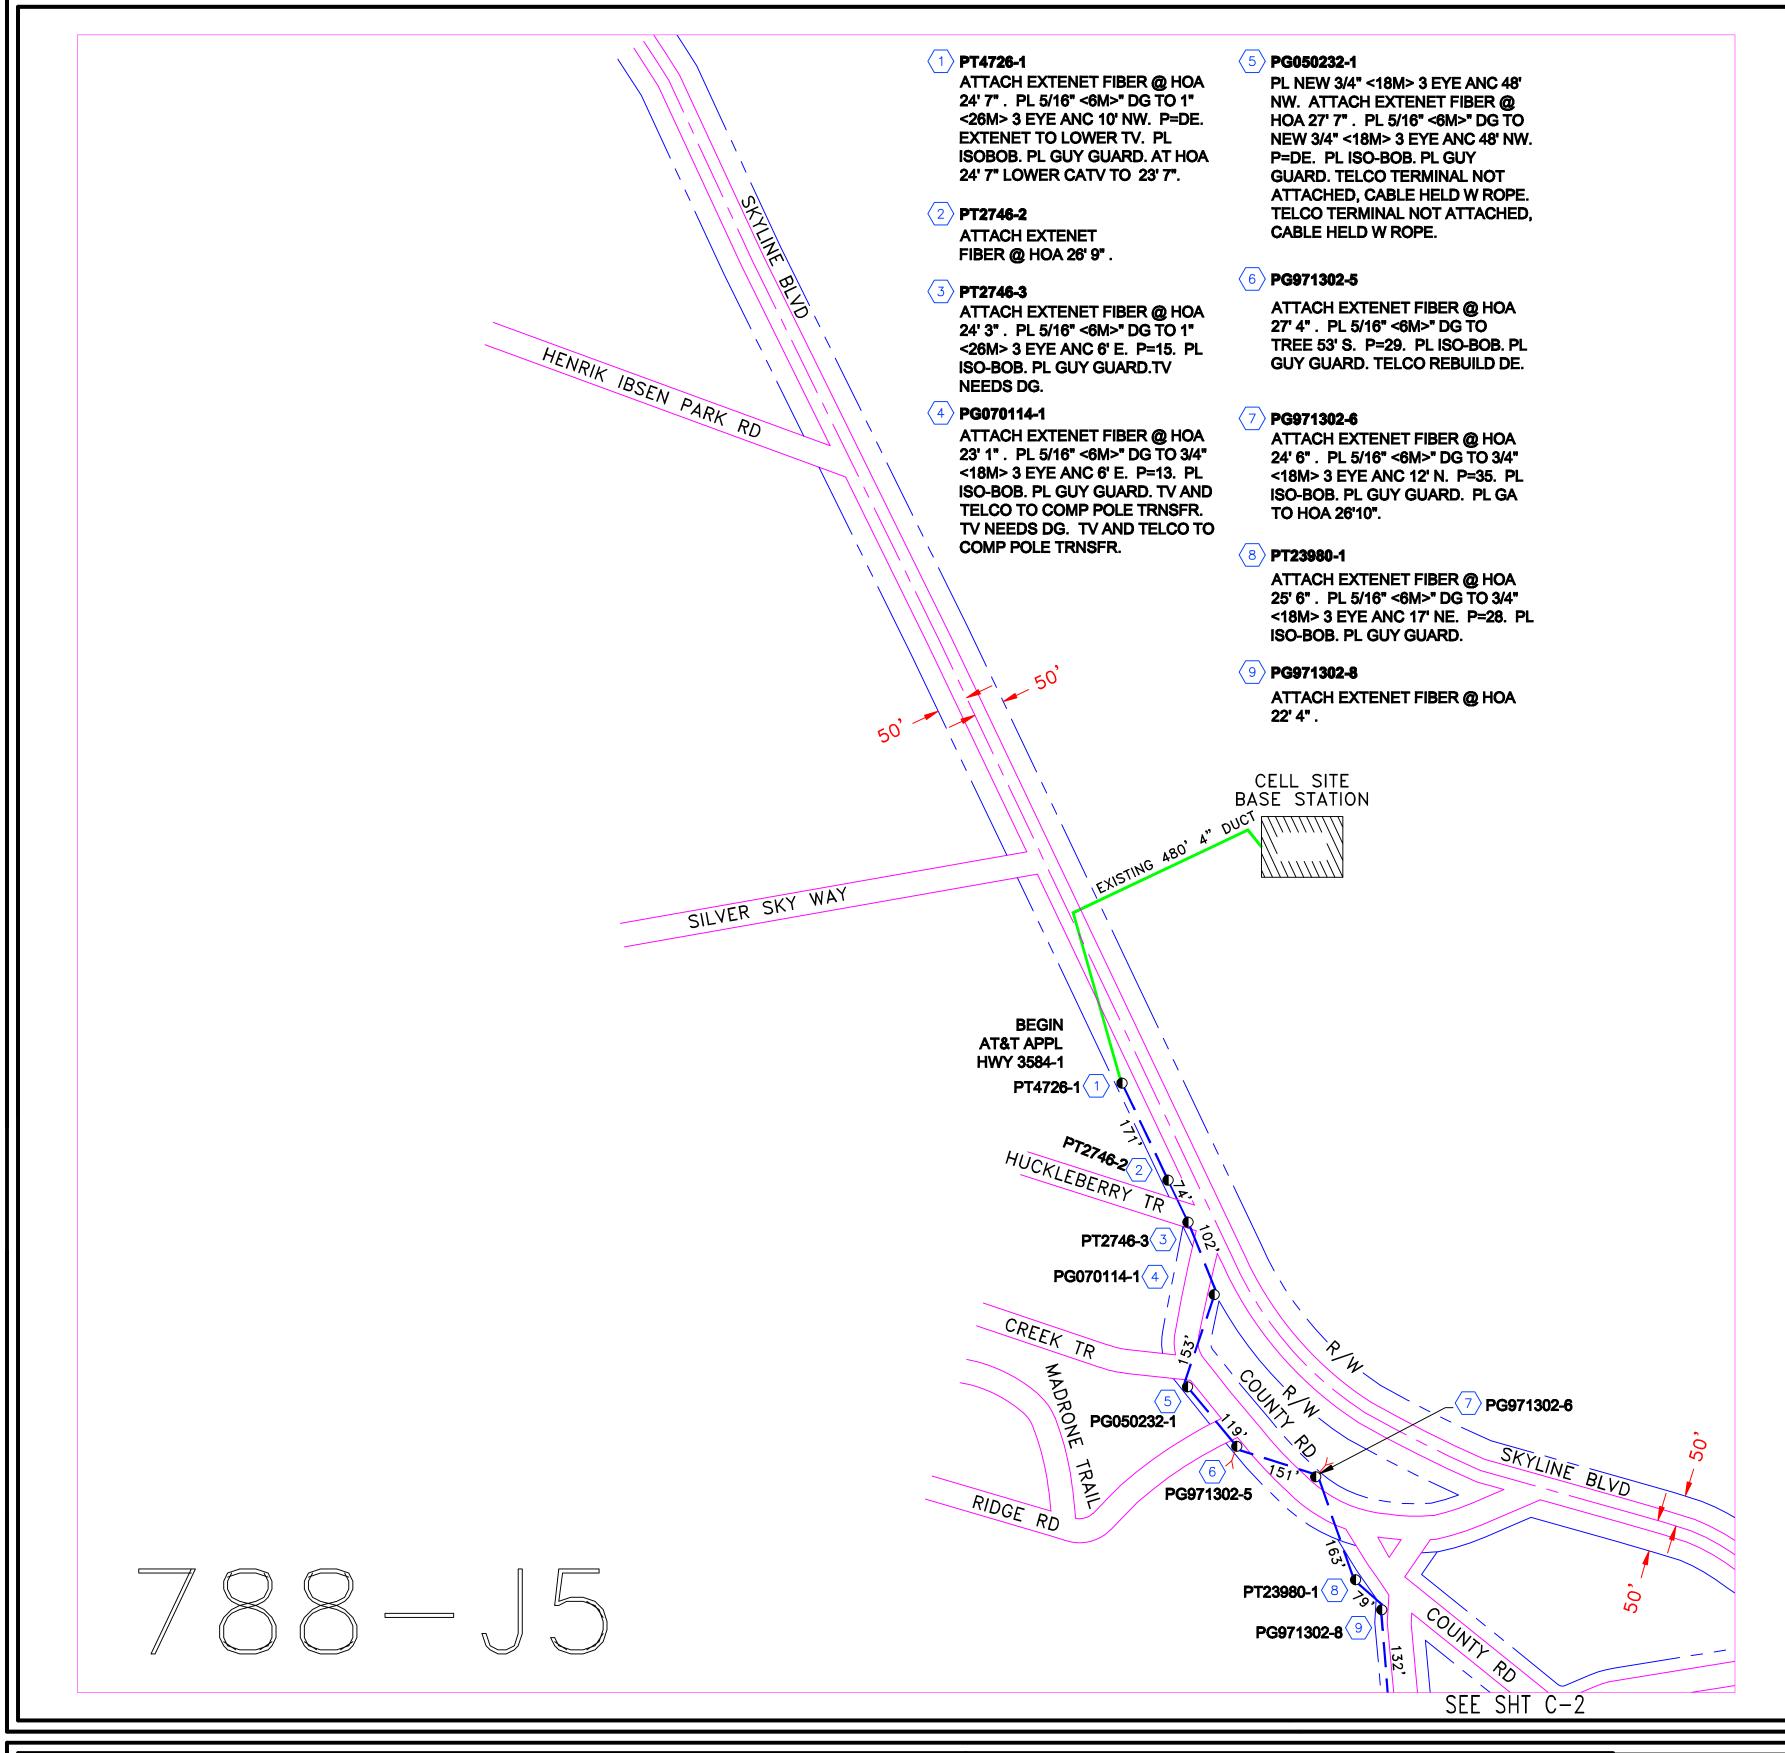

PLACEMENT DATA

PL 1144' OF AERIAL FIBER OPTIC CABLE


CONSTRUCTION NOTE:

- 1) USA UTILITY ALERT MUST
 BE CONTACTED MIN 48 HRS.
 PRIOR TO BEGINING CONSTRUCTION
- 2) ALL EX. UTILITIES BEING CROSSED MUST BE POTHOLED FOR DEPTH & LOCATION PRIOR TO CONSTRUCTION.


NOTES

UNDERGROUND UTILITIES HAVE BEEN PLOTTED FROM AVAILABLE RECORDS AND FIELD OBSERVATIONS, BUT ARE NOT NECESSARILY EXACT. THEREFORE, UTILITY LOCATIONS WILL BE VERIFIED AT LEAST 100 FEET IN ADVANCE OF TRENCHING, DIRECTIONAL BORING OR PLOWING SO THAT CHANGES IN CONDUIT PLACEMENT CAN BE MADE IN THE EVENT OF CONFLICTS.

ALL KNOWN BURIED OBSTRUCTIONS ARE SHOWN ON THE CONSTRUCTION DRAWINGS.
ANY AND ALL OTHERS ENCOUNTERED ARE ALSO THE RESPONSIBILITY OF THE
CONTRACTOR TO LOCATE, PROTECT, AND REPAIR, IF DAMAGED.

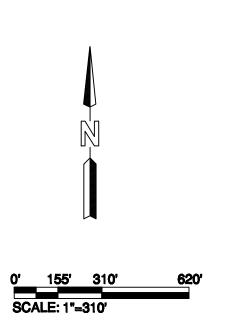



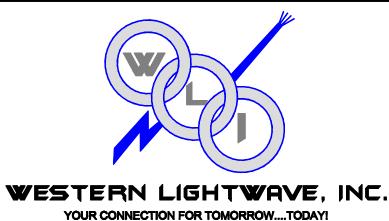

33490 Bailey Park Blvd, Menifee, CA 92584

REVISION	TOTAL FOOTAGE: 1144'	PROJECT NO.: HWY 8435	
1. TRAFFIC CONTROL PLANS 08/10/09	ENGINEERED DATE:	PROJECT NAME : SKYLINE BLVD	
2.	DRAWN BY: ICS	TG PAGE: 788-J5	
3.	DRAFT DATE: 08/10/09	JURISDICTION : COUNTY OF SAN MATEO	
4.			
5.			
6.	SKYLINE BLVD	SHEET TITLE	SHEET
7.	SAN MATEO, CA	DI ANI	
8.		PLAN	C-1

10 **PG971302-9**ATTACH EX

ATTACH EXTENET FIBER @ HOA 19' 7". PL 5/16" <6M>" DG TO 3/4" <18M> 3 EYE ANC 17' NE. P=32. PL ISO-BOB. PL GUY GUARD. TELCO TO COMP POLE TRNSFR.

(11) PG971302-10

ATTACH EXTENET FIBER @ HOA 18' 6".
PL 5/16" <6M>" DG TO 3/4" <18M> 3 EYE
ANC 17' W. P=37. PL ISO-BOB. PL GUY
GUARD. TV TO COMP POLE TRNSFR.

12 PT# N/A

ATTACH EXTENET FIBER @ HOA 23' ". PL 5/16" <6M>" DG TO 3/4" <18M> 3 EYE ANC 10' E. P=34. PL ISO-BOB. PL GUY GUARD. TV NEEDS DG.

13 PT# N/A

ATTACH EXTENET FIBER @ HOA 23' ".
PL 5/16" <6M>" DG TO 3/4" <18M> 3 EYE
ANC 6' W. P=15. PL ISO-BOB. PL GUY
GUARD. TV NEEDS DG.

14) PT# N/

ATTACH EXTENET FIBER @ HOA 21' ".
ATTACH EXTENET FIBER @ HOA 21' 2".
PL 5/16" <6M>" DG TO TREE 27' W.
P=DE. PL 5/16" <6M>" DG TO TREE 28'
S. P=DE. PL ISO-BOB. PL GUY GUARD.

(15) PT# N/

ATTACH EXTENET FIBER @ HOA 18' " .
PL 5/16" <6M>" DG TO TREE 32' N.
P=18. EXTENET TO LOWER TV TO
VACANT DG HOA . PL ISO-BOB. PL
GUY GUARD. AT HOA 18' " LOWER
CATV TO 16' ".

PG971302-9 10 11 PT# N/A

FILBERT RD 7 12 PT# N/A

PT# N/A 13 PG ONLY POLE 258'

REDWOOD CITY TRAFFIC CONTROL PLANS CITY OF REDWOOD CITY

PLACEMENT DATA

PL 890' OF AERIAL FIBER OPTIC CABLE

CONSTRUCTION NOTE:

1) USA UTILITY ALERT MUST
BE CONTACTED MIN 48 HRS.
PRIOR TO BEGINING CONSTRUCTION

2) ALL EX. UTILITIES BEING CROSSED


MUST BE POTHOLED FOR DEPTH

& LOCATION PRIOR TO CONSTRUCTION.

NOTES:

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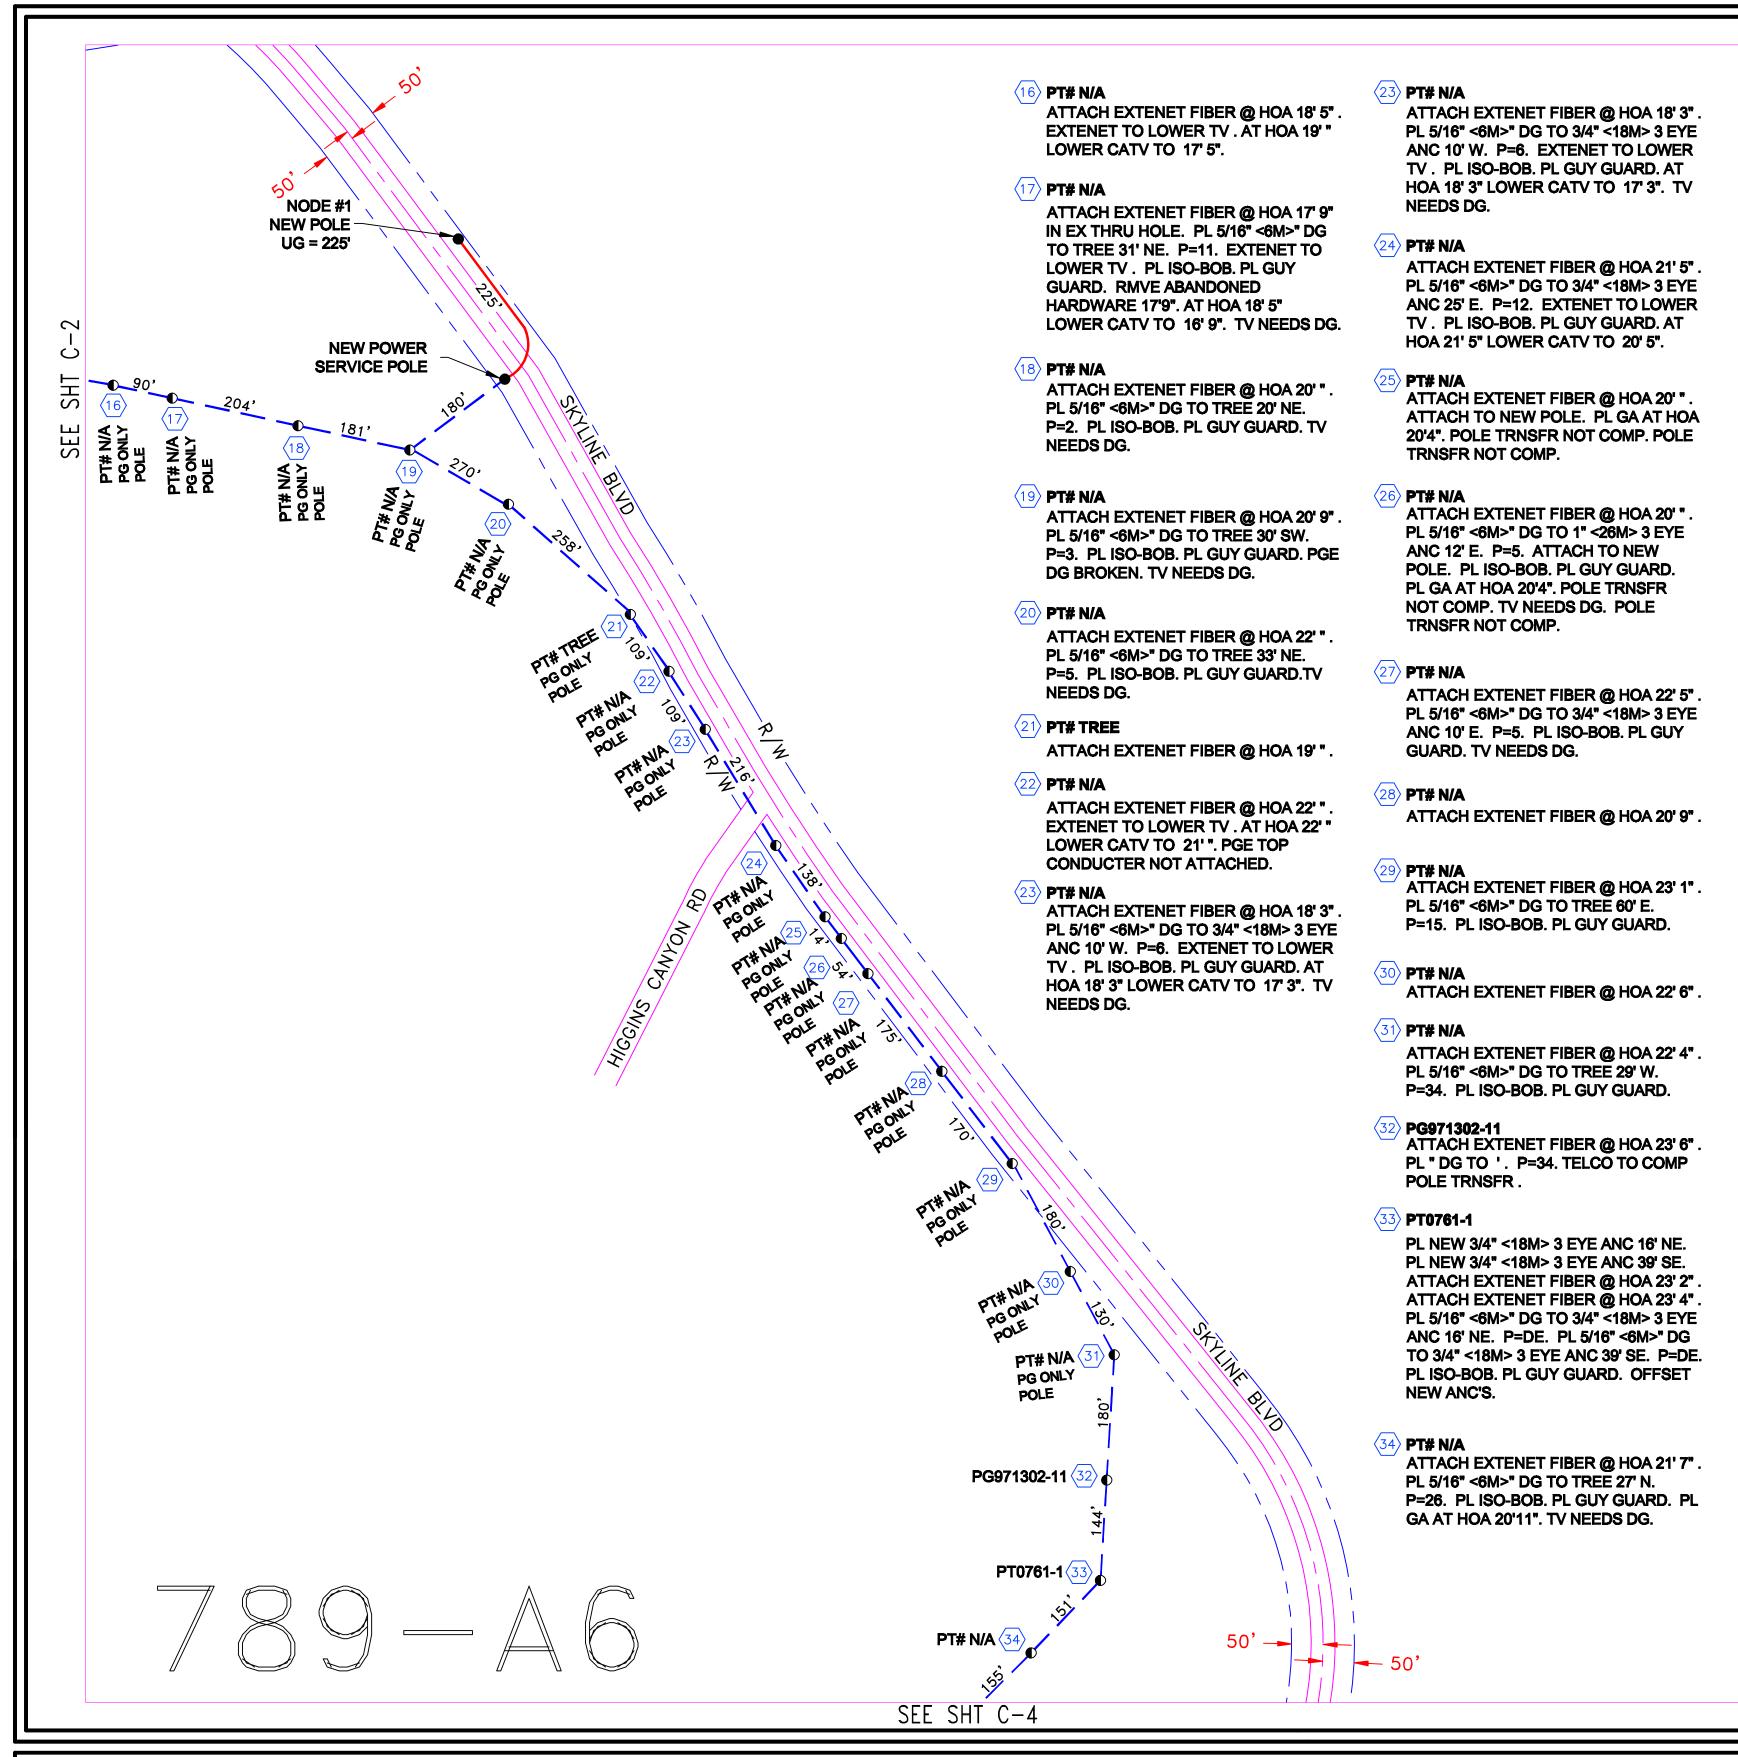
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CONTRACTOR TO LOCATE, PROTECT, AND REPAIR, IF DAMAGED.



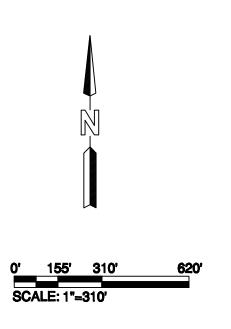



REVISION	TOTAL FOOTAGE: 890'	PROJECT NO.: HWY 8435	
1. TRAFFIC CONTROL PLANS 08/10/09	ENGINEERED DATE:	PROJECT NAME : SKYLINE BLVD	
2.	DRAWN BY: ICS	TG PAGE : 788-J6	
3.	DRAFT DATE: 08/10/09	JURISDICTION : COUNTY OF SAN MATEO	
4.			
5.			
6.	SKYLINE BLVD	SHEET TITLE SHEET	
7.	SAN MATEO, CA	DLAN	
8.	J. 11 1011 11 EO, O/ 1	PLAN	C-2



PLACEMENT DATA

PL 3108' OF AERIAL FIBER OPTIC CABLE PL 225' OF (2) 3" DUCT


CONSTRUCTION NOTE:

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 PRIOR TO BEGINING CONSTRUCTION
- 2) ALL EX. UTILITIES BEING CROSSED MUST BE POTHOLED FOR DEPTH & LOCATION PRIOR TO CONSTRUCTION.


NOTES:

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┖.		

REVISION	TOTAL FOOTAGE: 3333'	PROJECT NO.: HWY 8435	
1. TRAFFIC CONTROL PLANS 08/10/09	ENGINEERED DATE:	PROJECT NAME : SKYLINE BLVD	
2.	DRAWN BY: ICS	TG PAGE: 789-A6	
3.	DRAFT DATE: 08/10/09	JURISDICTION : COUNTY OF SAN MATEO	
4.			
5.			
6.	SKYLINE BLVD	SHEET TITLE	SHEET
7.	SAN MATEO, CA	DLAN	
Ω	57 dt 1017 (1 2 5 ; 57 (PLAN	C-3

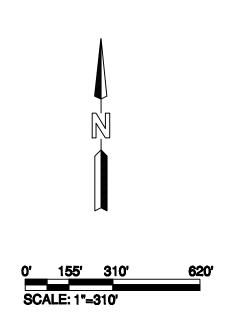PT# N/A PG ONLY POLE NODE #2 **NEW POLE** UG = 515' **PG ONLY POLE** PT# N/A (**PG ONLY POLE** PG ONLY POLE **NEW POWER** KINGS MOUNTAIN RD SKYLINE BLVD **44** PT24377-1 PT# N/A 39**> PT# N/A** ATTACH EXTENET FIBER @ HOA 22' 10". ATTACH EXTENET FIBER @ HOA 25' ". ATTACH EXTENET FIBER @ HOA 21'7". PL 5/16" <6M>" DG TO TREE 27' N. PL 5/16" <6M>" DG TO 1.25" <32M> 3 EYE ANC 16' SE. P=23. PL ISO-BOB. PL GUY P=26. PL ISO-BOB. PL GUY GUARD. PL PT# N/A GA AT HOA 20'11". TV NEEDS DG. ATTACH EXTENET FIBER @ HOA 24' 8". PL 5/16" <6M>" DG TO TREE 17' NW. P=5. PT24376-1 PT# N/A PL ISO-BOB. PL GUY GUARD. TV NEEDS PL NEW 3/4" <18M> 3 EYE ANC 15' S. ATTACH EXTENET FIBER @ HOA 23' 9". ATTACH EXTENET FIBER @ HOA 24' ". PL 5/16" <6M>" DG TO 3/4" <18M> 3 EYE PL 5/16" <6M>" DG TO NEW 3/4" <18M> 3 ANC 17' NW. P=14. PL ISO-BOB. PL PG971302-12 EYE ANC 15' S. P=16. PL ISO-BOB. PL **GUY GUARD. TV NEEDS DG.** ATTACH EXTENET FIBER @ HOA 24' 1". **GUY GUARD. OFFSET NEW ANC.** PT# N/A PG971302-13 ATTACH EXTENET FIBER @ HOA 23' 7". ATTACH EXTENET FIBER @ HOA 25' 5". PL NEW 3/4" <18M> 3 EYE ANC 15' S. PL 5/16" <6M>" DG TO 3/4" <18M> 3 EYE PL 5/16" <6M>" DG TO 1" <26M> 3 EYE ATTACH EXTENET FIBER @ HOA 21' " ANC 12' SE. P=12. PL ISO-BOB. PL ANC 13' W. P=17. PL ISO-BOB. PL GUY PL 5/16" <6M>" DG TO NEW 3/4" <18M> 3 **GUY GUARD.** EYE ANC 15' S. P=8. PL ISO-BOB. PL **GUY GUARD. TV DG BROKEN.**

REDWOOD CITY TRAFFIC CONTROL PLANS CITY OF REDWOOD CITY

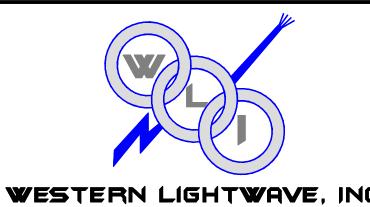PLACEMENT DATA

PL 2178' OF AERIAL FIBER OPTIC CABLE PL 515' OF (2) 3" DUCT

PT# N/A ATTACH EXTENET FIBER @ HOA 20' 9". PL 5/16" <6M>" DG TO TREE 39' SE. P=19. EXTENET TO LOWER TV. PL ISO-BOB. PL GUY GUARD. AT HOA 21' 7" LOWER CATV TO 19'9".

PG971302-14

ATTACH EXTENET FIBER @ HOA 26' ". PL 5/16" <6M>" DG TO TREE 49' E. P=27. PL ISO-BOB. PL GUY GUARD.


CONSTRUCTION NOTE:

1) USA UTILITY ALERT MUST BE CONTACTED MIN 48 HRS. PRIOR TO BEGINING CONSTRUCTION


2) ALL EX. UTILITIES BEING CROSSED MUST BE POTHOLED FOR DEPTH & LOCATION PRIOR TO CONSTRUCTION.

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33490 Bailey Park Blvd, Menifee, CA 92584 (951) 672-9376

REVISION	TOTAL FOOTAGE: 2693'	PROJECT NO.: HWY 8435	
1. TRAFFIC CONTROL PLANS 08/10/09	ENGINEERED DATE:	PROJECT NAME : SKYLINE BLVD	
2.	DRAWN BY: ICS	TG PAGE: 789-A7	
3.	DRAFT DATE: 08/10/09	JURISDICTION : COUNTY OF SAN MATI	EO
4.			
5.			
6.	SKYLINE BLVD	SHEET TITLE	SHEET
7.	SAN MATEO, CA	DLAN	C 4
8.		PLAN	C-4

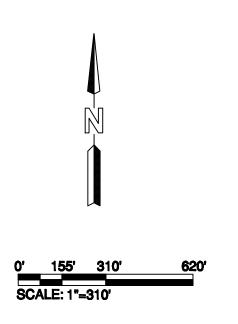47) **PT# N/A**ATTACH EXTENET FIBER @ HOA 20' 8".

48) PT# N/A
PL NEW 3/4" <18M> 3 EYE ANC 15' N.
ATTACH EXTENET FIBER @ HOA 21' 6".
ATTACH EXTENET FIBER @ HOA 21' 8".
PL 5/16" <6M>" DG TO NEW 3/4" <18M>
3 EYE ANC 15' N. P=DE. PL 5/16" <6M>"

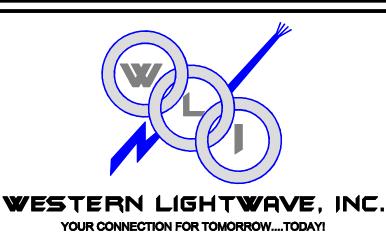PL 5/16" <6M>" DG TO NEW 3/4" <18M>
3 EYE ANC 15' N. P=DE. PL 5/16" <6M>"
DG TO 3/4" <18M> 3 EYE ANC 27' W.
P=DE. PL ISO-BOB. PL GUY GUARD.
OFFSET NEW ANC.

49 PT# N/A

ATTACH EXTENET FIBER @ HOA 27' 4".
PL 5/16" <6M>" DG TO TREE 13' W. P=8.
PL ISO-BOB. PL GUY GUARD. TELCO
TO COMP POLE TRNSFR.

50) PT# N/A

PL NEW 3/4" <18M> 3 EYE ANC 18' E.
ATTACH EXTENET FIBER @ HOA 23' 5".
PL 5/16" <6M>" DG TO NEW 3/4" <18M>
3 EYE ANC 18' E. P=15. PL ISO-BOB.
PL GUY GUARD. OFFSET NEW ANC.
TELCO TO COMP POLE TRNSFR.

51) PG971302-15

PL NEW 3/4" <18M> 3 EYE ANC 14' W. ATTACH EXTENET FIBER @ HOA 26' ". PL 5/16" <6M>" DG TO NEW 3/4" <18M> 3 EYE ANC 14' W. P=12. PL ISO-BOB. PL GUY GUARD. PGE NEEDS DG. TELCO HELD WITH ROPE AT HOA. TELCO NEEDS DG. TV NEEDS DG.

(52) **DT7207**

ATTACH EXTENET FIBER @ HOA 23' 7". PL 5/16" <6M>" DG TO '. P=10. PL ISO-BOB. PL GUY GUARD.TELCO NOT ATTACHED. TELCO NEEDS DG. TV NEEDS DG.

53 PT4996-

ATTACH EXTENET FIBER @ HOA 23' 2". PL 5/16" <6M>" DG TO TREE 22' E. P=10. PL ISO-BOB. PL GUY GUARD. TV NEEDS DG.

94 PG971302-1

PG971302-17
ATTACH EXTENET FIBER @ HOA 24' ".
PL 5/16" <6M>" DG TO TREE 7' E. P=21.
PL ISO-BOB. PL GUY GUARD. TELCO
TO COMP POLE TRNSFR. SOUTH
SPAN BROKEN.

55) PT# N/A

ATTACH EXTENET FIBER @ HOA 28' 7".
PL 5/16" <6M>" DG TO BURIED ANC 45'
W. P=30. PL ISO-BOB. PL GUY GUARD.


56 PT24376-3

ATTACH EXTENET FIBER @ HOA 34' 4".
TELCO NORTH AND SOUTH SPAN

REDWOOD CITY TRAFFIC CONTROL PLANS CITY OF REDWOOD CITY

PLACEMENT DATA

PL 1882' OF AERIAL FIBER OPTIC CABLE

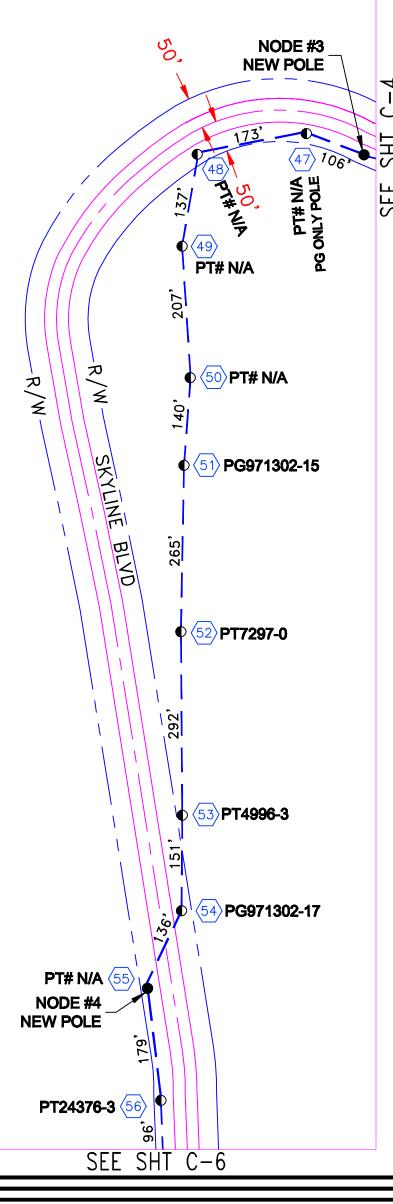


CONSTRUCTION NOTE:

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 PRIOR TO BEGINING CONSTRUCTION
- 2) ALL EX. UTILITIES BEING CROSSED MUST BE POTHOLED FOR DEPTH & LOCATION PRIOR TO CONSTRUCTION.

NOTES:

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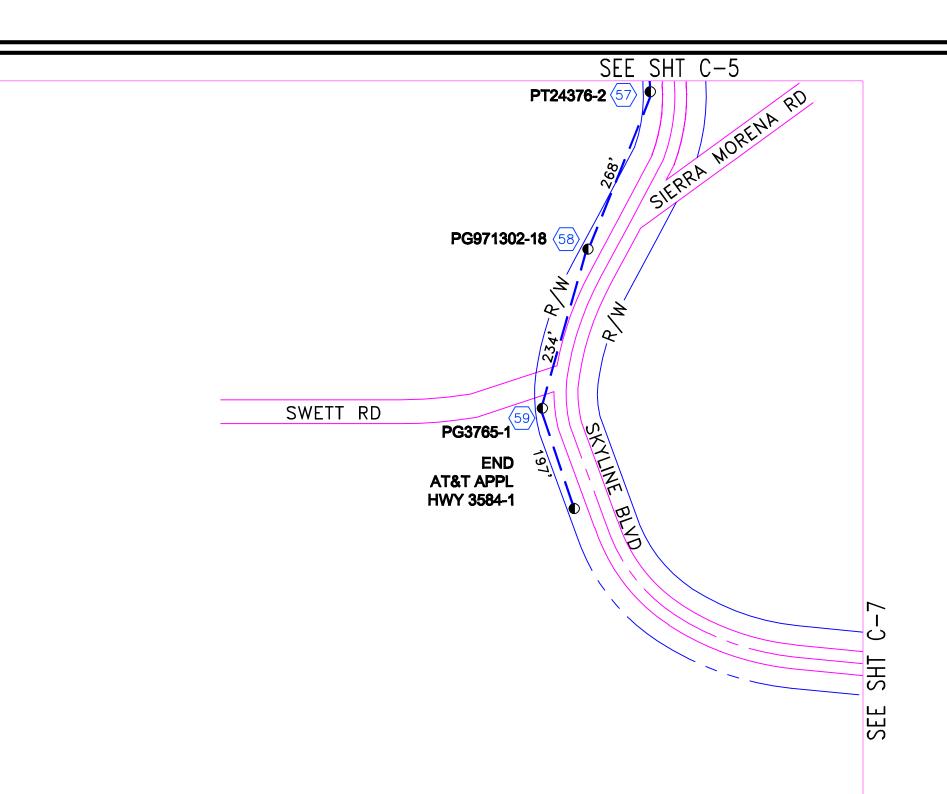
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REVISION	TOTAL FOOTAGE: 1882'	PROJECT NO.: HWY 8435	
1. TRAFFIC CONTROL PLANS 08/10/09	ENGINEERED DATE:	PROJECT NAME : SKYLINE BLVD	
2.	DRAWN BY: ICS	TG PAGE: 788-J7	
3.	DRAFT DATE: 08/10/09	JURISDICTION : COUNTY OF SAN MATEO	
4.			
5.			
6.	SKYLINE BLVD	SHEET TITLE	SHEET
7.	SAN MATEO, CA	DLAN	\sim $_{F}\parallel$
8.		PLAN	C-5

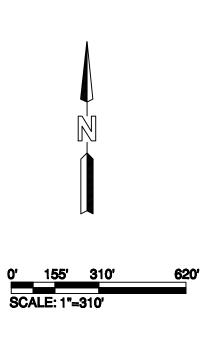

PLACEMENT DATA

PL 699' OF AERIAL FIBER OPTIC CABLE


CONSTRUCTION NOTE:

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 PRIOR TO BEGINING CONSTRUCTION
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PT24376-2

PG971302-18

PG3765-1

PL GA TO 23'10".

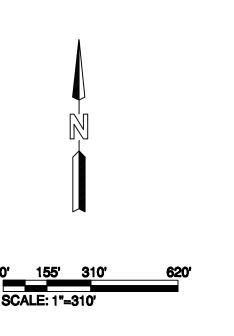ATTACH EXTENET FIBER @ HOA 27' 9".

ATTACH EXTENET FIBER @ HOA 23' 6".

ATTACH EXTENET FIBER @ HOA 24' ".

RAISE DGA TO 24'4". LEAD CONTINUES

ON APP HWY3584-2 POLE 1.

PL 5/16" <6M>" DG TO TREE 15' E. P=24. PL ISO-BOB. PL GUY GUARD.






REVISION	TOTAL FOOTAGE: 699'	PROJECT NO.: HWY 8435	
1. TRAFFIC CONTROL PLANS 08/10/09	ENGINEERED DATE:	PROJECT NAME : SKYLINE BLVD	
2.	DRAWN BY: ICS	TG PAGE: 808-J1	
3.	DRAFT DATE: 08/10/09	JURISDICTION : COUNTY OF SAN MATEO	
4.			
5.			
6.	SKYLINE BLVD	SHEET TITLE	SHEET
7.	SAN MATEO, CA	DI ANI	
8.		PLAN	C-6

PG030065-4
ATTACH EXTENET FIBER @ HOA 23' ". PL
5/16" <6M>" DG TO TREE 36' W. P=14. PL
ISO-BOB.PL GUY GUARD. TV NEEDS DG.

PG971302-20
PL NEW 3/4" <18M> 3 EYE ANC 18' W.
ATTACH EXTENET FIBER @ HOA 24' 4". PL
5/16" <6M>" DG TO NEW 3/4" <18M> 3 EYE
ANC 18' W. P=33. PL ISO-BOB.PL GUY
GUARD. OFFSET NEW ANC.

PG971302-21
PL NEW 3/4" <18M> 3 EYE ANC 16' E.
ATTACH EXTENET FIBER @ HOA 26' 9". PL
5/16" <6M>" DG TO NEW 3/4" <18M> 3 EYE
ANC 16' E. P=14. PL ISO-BOB.PL GUY
GUARD. OFFSET NEW ANC. TELCO TO
COMP POLE TRNSFR.

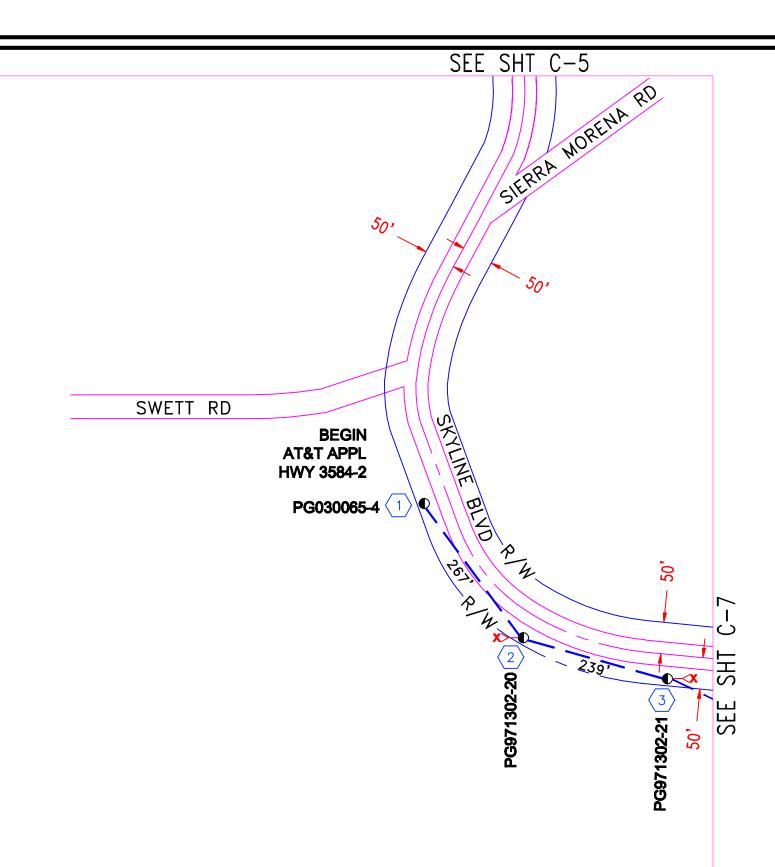

REDWOOD CITY TRAFFIC CONTROL PLANS CITY OF REDWOOD CITY

PLACEMENT DATA

PL 506' OF AERIAL FIBER OPTIC CABLE


CONSTRUCTION NOTE:

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NOTES

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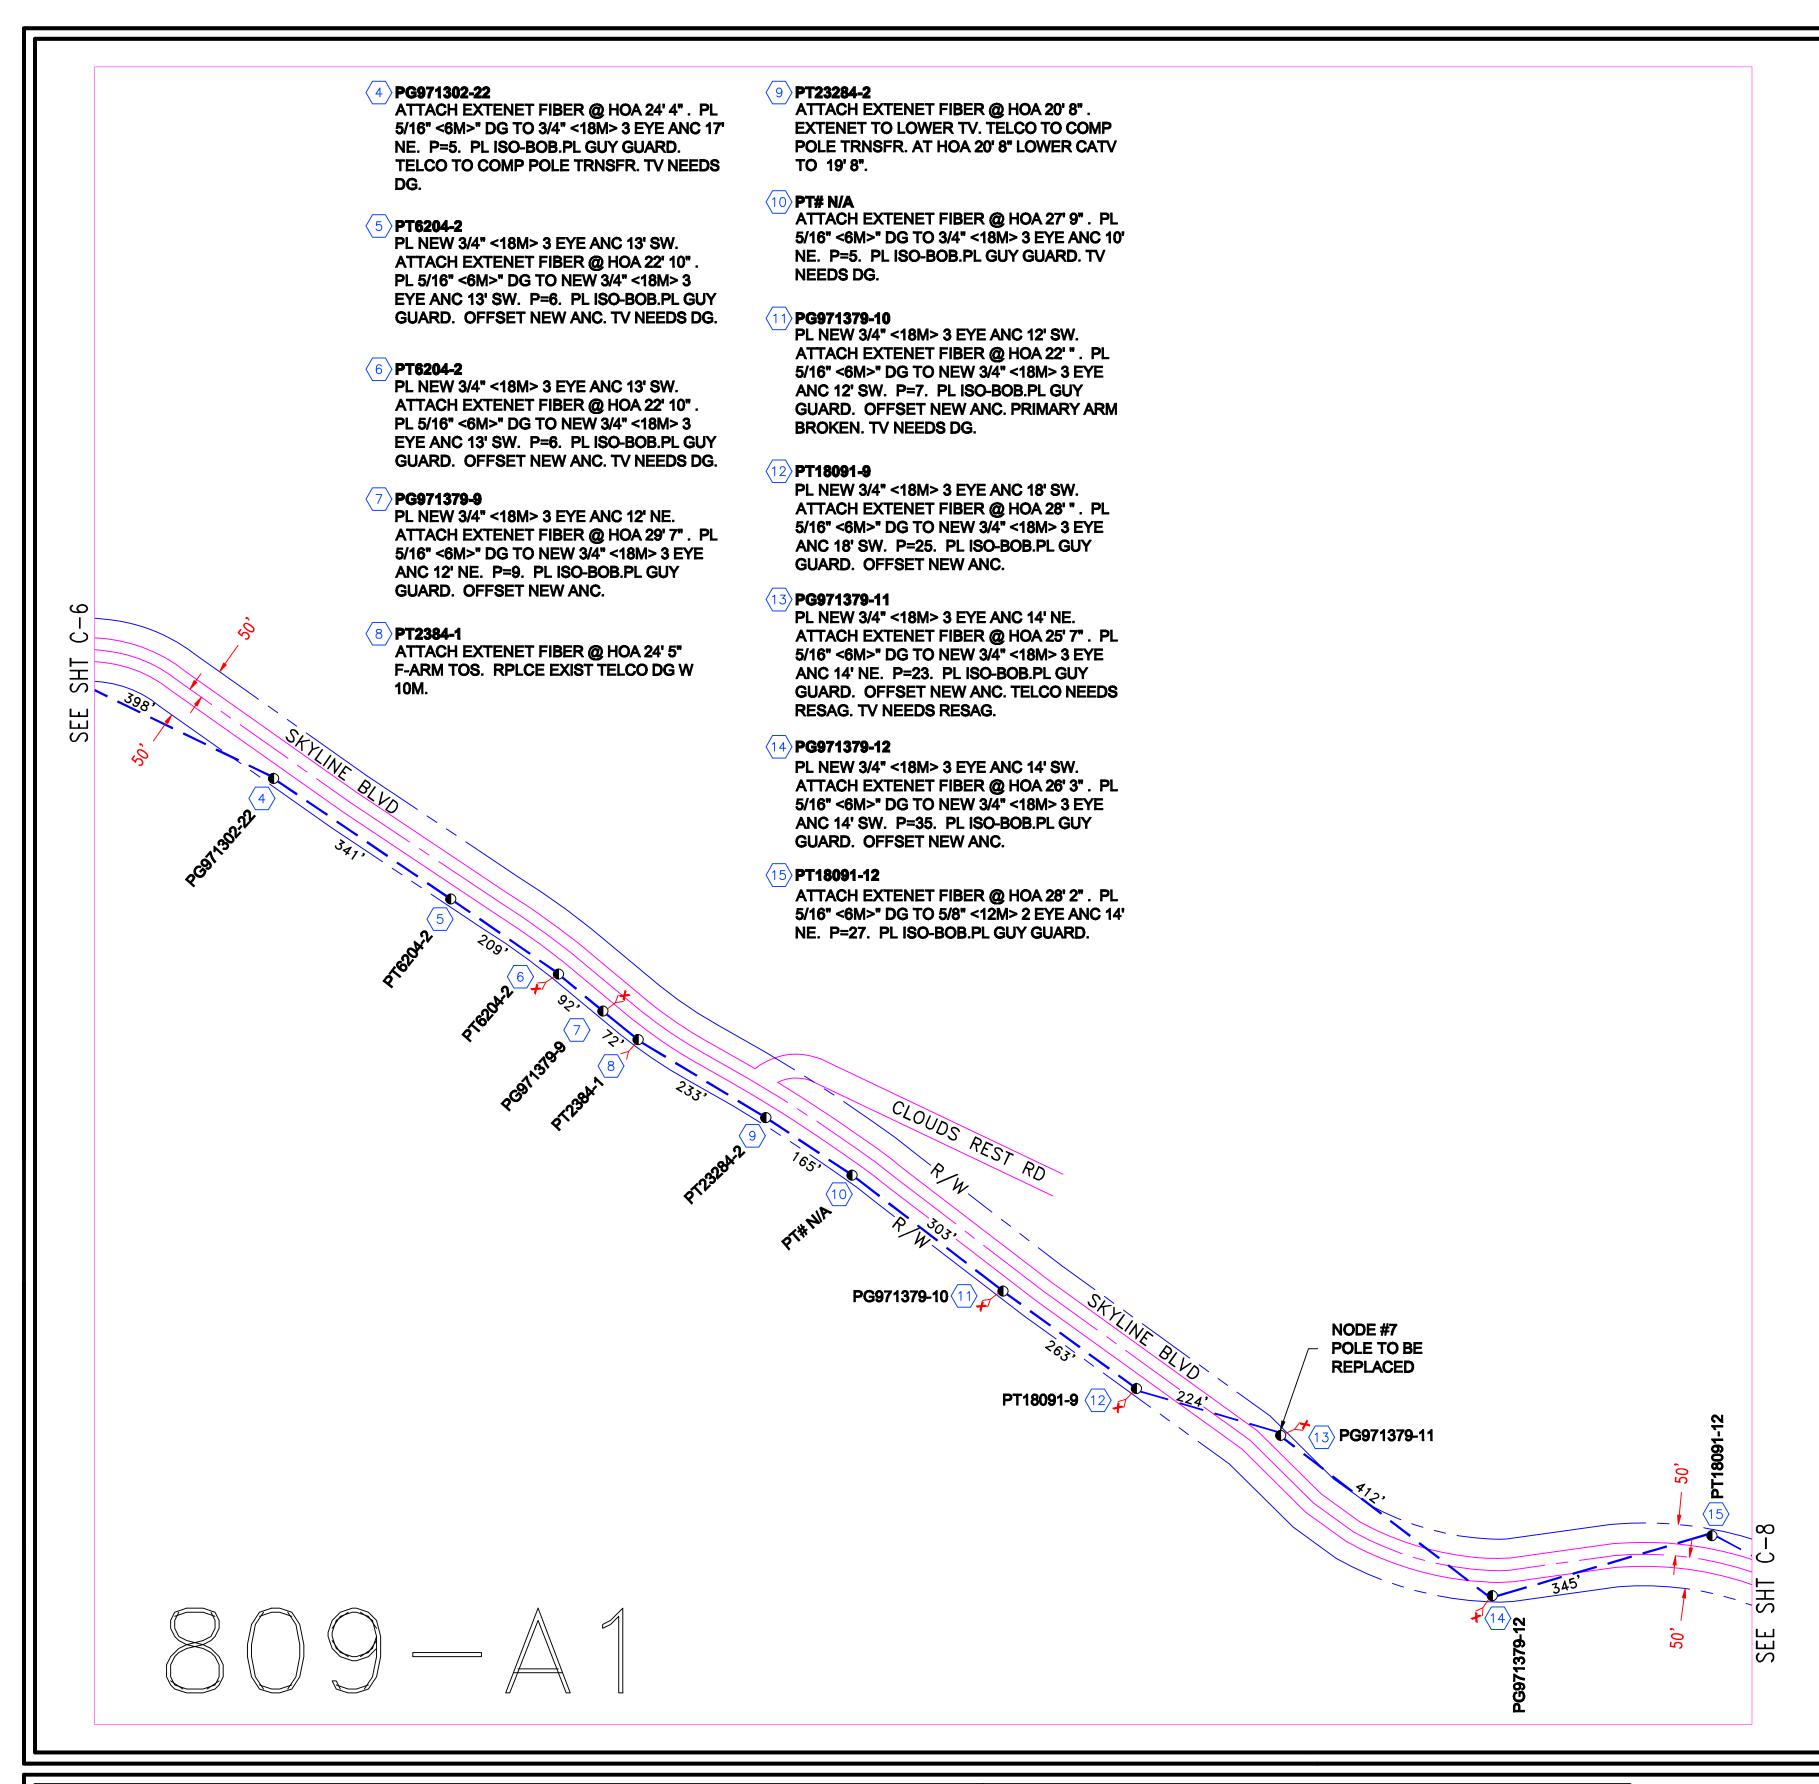
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CONTRACTOR TO LOCATE, PROTECT, AND REPAIR, IF DAMAGED.





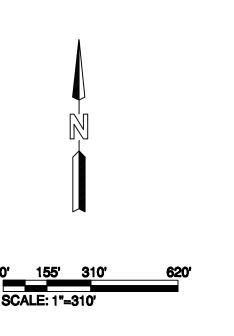

REVISION	TOTAL FOOTAGE: 506'	PROJECT NO.: HWY 8435		
1. TRAFFIC CONTROL PLANS 08/10/09	ENGINEERED DATE:	PROJECT NAME : SKYLINE BLVD	PROJECT NAME : SKYLINE BLVD	
2.	DRAWN BY: ICS	TG PAGE: 808-J1	TG PAGE : 808-J1	
3.	DRAFT DATE: 08/10/09	JURISDICTION : COUNTY OF SAN MATEO		
4.				
5.				
6.	SKYLINE BLVD	SHEET TITLE	SHEET	
7.	SAN MATEO, CA	DLAN		
8.	57 UT 107 (1 E 5, 67 (PLAN	C-6	



PLACEMENT DATA

PL 3057' OF AERIAL FIBER OPTIC CABLE


CONSTRUCTION NOTE:

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REVISION	TOTAL FOOTAGE: 3057'	PROJECT NO.: HWY 8435	
1. TRAFFIC CONTROL PLANS 08/10/09	ENGINEERED DATE:	PROJECT NAME : SKYLINE BLVD	
2.	DRAWN BY: ICS	TG PAGE: 809-A1	
3.	DRAFT DATE: 08/10/09	JURISDICTION : COUNTY OF SAN MATEO	
4.			
5.			
6.	SKYLINE BLVD	SHEET TITLE	SHEET
7.	SAN MATEO, CA	DLAN	C 7
	0, 1, 1, 1, 2, 1, 1, 1, 1, 1, 1, 1, 1, 1, 1, 1, 1, 1,	PLAN	

ATTACH EXTENET FIBER @ HOA 31' 8". PL 5/16" <6M>" DG TO 1" <26M> 3 EYE ANC 15' NE. P=28. PL ISO-BOB.PL GUY GUARD. RMV VACANT DG. RESAG SE SPAN (25'3"). RESAG SE SPAN (17'5"). RESAG SE SPAN (20'9"). RESAG SE SPAN (17'5").

REDWOOD CITY TRAFFIC CONTROL PLANS CITY OF REDWOOD CITY

PLACEMENT DATA

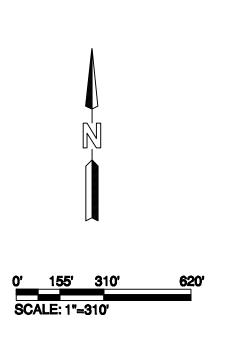PL 334' OF AERIAL FIBER OPTIC CABLE





- 1) USA UTILITY ALERT MUST
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 PRIOR TO BEGINING CONSTRUCTION
- 2) ALL EX. UTILITIES BEING CROSSED MUST BE POTHOLED FOR DEPTH & LOCATION PRIOR TO CONSTRUCTION.

NOTES

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CONTRACTOR TO LOCATE, PROTECT, AND REPAIR, IF DAMAGED.




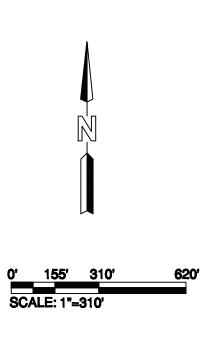

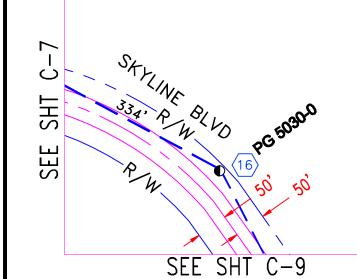



REVISION	TOTAL FOOTAGE: 334'	PROJECT NO.: HWY 8435	
1. TRAFFIC CONTROL PLANS 08/10/09	CONTROL PLANS 08/10/09 ENGINEERED DATE: DRAWN BY: ICS	PROJECT NAME : SKYLINE BLVD	
2.		TG PAGE : 809-B1	
3.	DRAFT DATE: 08/10/09	JURISDICTION : COUNTY OF SAN MATEO	
4.			
5.			
6.	SKYLINE BLVD	SHEET TITLE	SHEET
7.	SAN MATEO, CA	DLAN	
8.	57 tt 1017 (1 2 5, 67 (PLAN	C-8

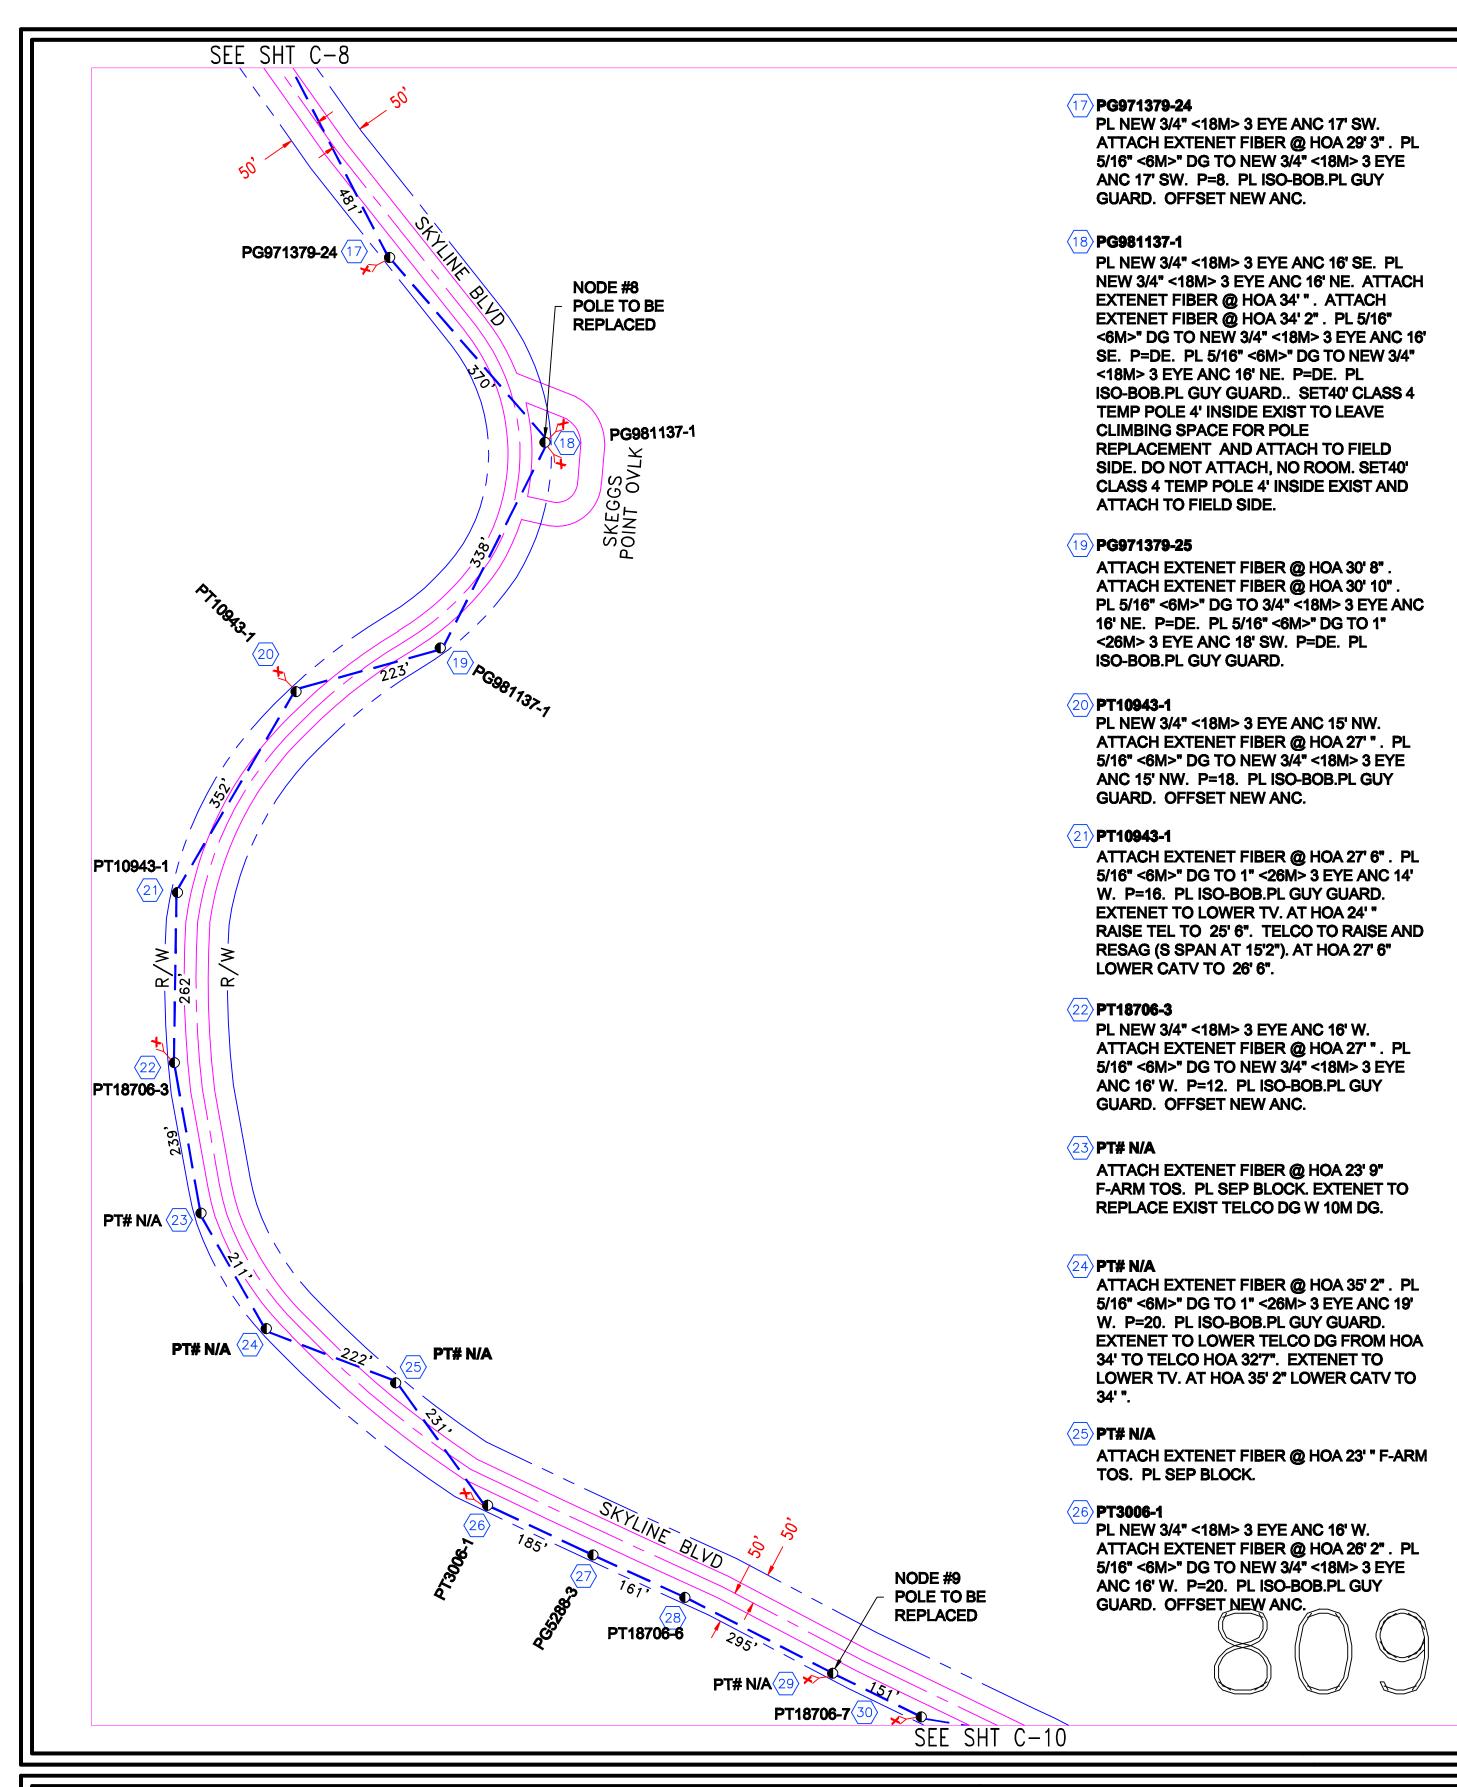

PG5288-3 ATTACH EXTENET FIBER @ HOA 26' 1".

PT18706-6 ATTACH EXTENET FIBER @ HOA 25' 6". EXTENET TO LOWER TV. PGE DG LOOSE (NO PULL). AT HOA 25' " LOWER CATV TO 24'6".

PL NEW 3/4" <18M> 3 EYE ANC 8' SW. ATTACH **EXTENET FIBER @ HOA 24'** 11". PL 5/16" <6M>" DG TO NEW 3/4" <18M> 3 EYE ANC 8' SW. P=13. PL ISO-BOB.PL **GUY GUARD. OFFSET NEW** ANC. PGE DG LOOSE . TV

NEEDS DG.

PT18706-7 PL NEW 3/4" <18M> 3 EYE ANC 16' SW. ATTACH **EXTENET FIBER @ HOA 27'** . PL 5/16" <6M>" DG TO NEW 3/4" <18M> 3 EYE ANC 16' SW. P=15. PL ISO-BOB.PL **GUY GUARD. OFFSET NEW**

REDWOOD CITY TRAFFIC CONTROL PLANS CITY OF REDWOOD CITY

PLACEMENT DATA


PL 3721' OF AERIAL FIBER OPTIC CABLE

CONSTRUCTION NOTE:


- 1) USA UTILITY ALERT MUST BE CONTACTED MIN 48 HRS. PRIOR TO BEGINING CONSTRUCTION
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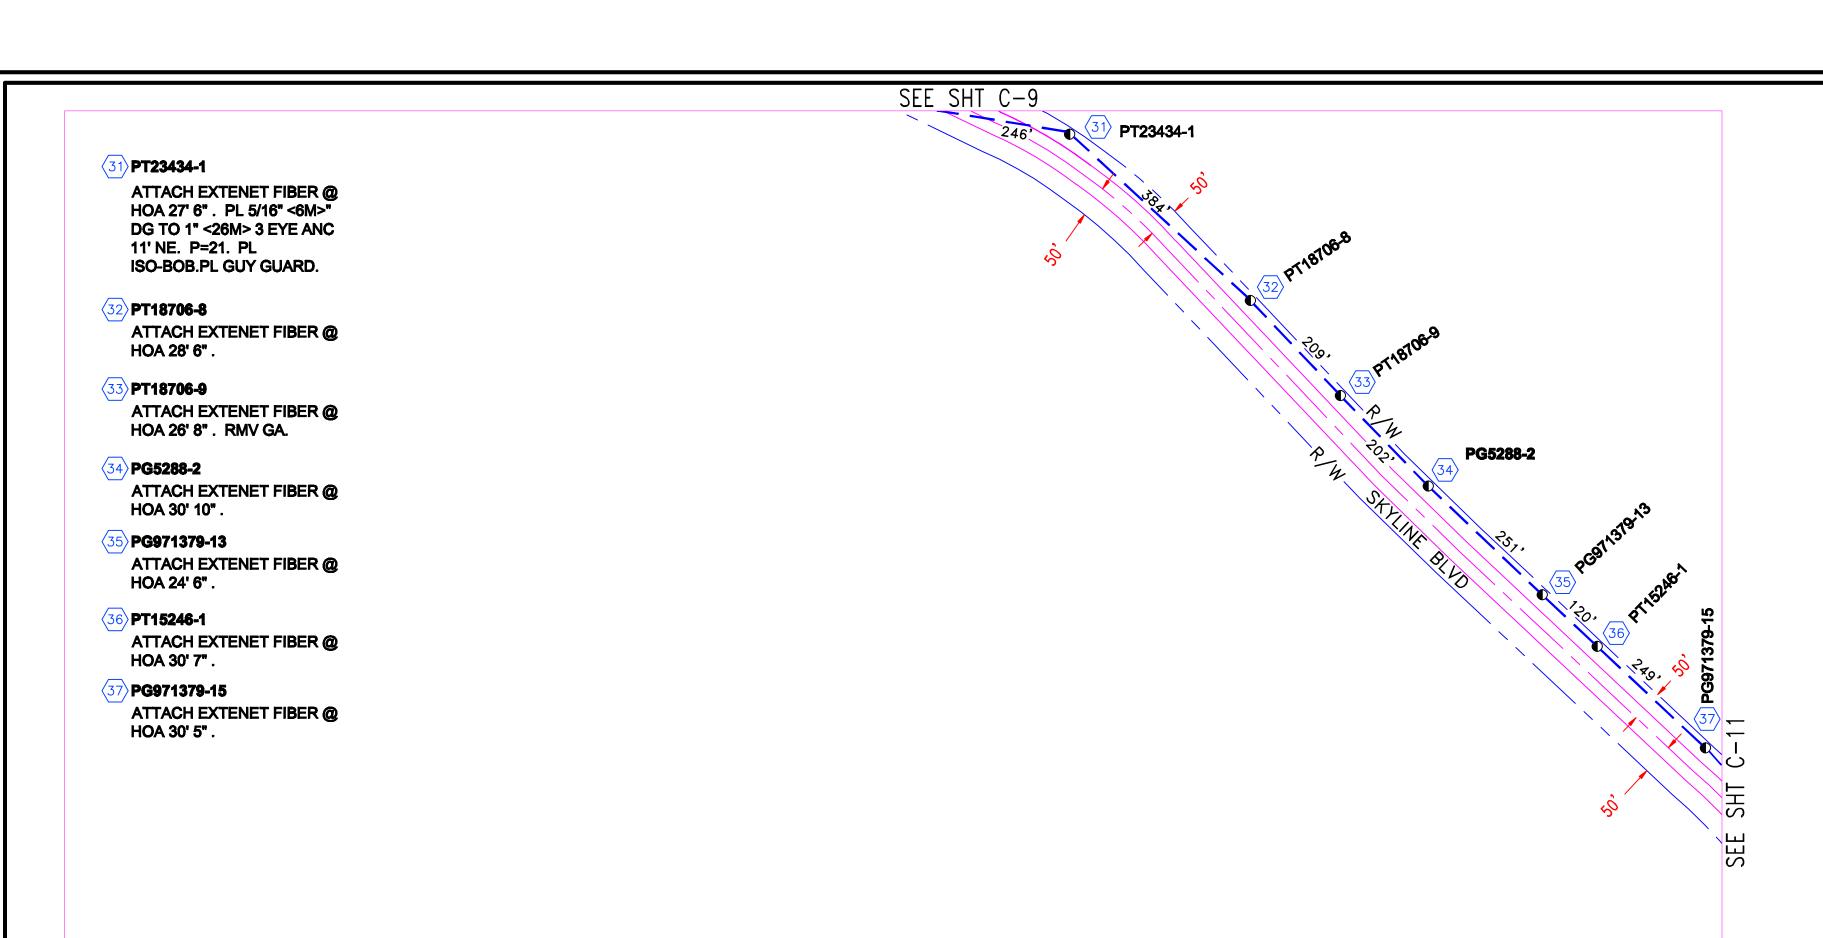




YOUR CONNECTION FOR TOMORROW....TODAY! 33490 Bailey Park Blvd, Menifee, CA 92584

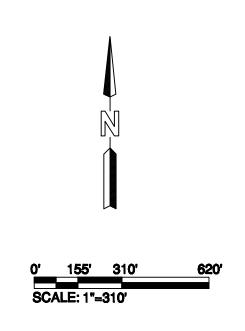	1. TRAFFIC CONTROL PLANS
	2.
	3.
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	5.
	6.
	7.
	8

7				
REVISION	TOTAL FOOTAGE: 3721'	PROJECT NO. : HWY 8435		
1. TRAFFIC CONTROL PLANS 08/10/09	ENGINEERED DATE:	PROJECT NAME : SKYLINE BLVD		
2.	DRAWN BY: ICS	TG PAGE: 809-B2		
3.	DRAFT DATE: 08/10/09	JURISDICTION : COUNTY OF SAN	JURISDICTION : COUNTY OF SAN MATEO	
4.				
5.				
6.	SKYLINE BLVD	SHEET TITLE	SHEET	
7.	SAN MATEO, CA	DLAN		
8.	57 tt 1717 (1 2 5, 57 t	PLAN	C-9	

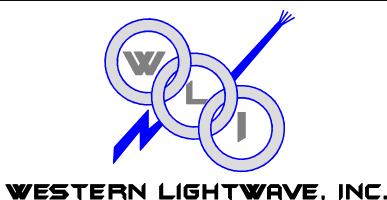

PLACEMENT DATA

PL 1661' OF AERIAL FIBER OPTIC CABLE

CONSTRUCTION NOTE:

1) USA UTILITY ALERT MUST
BE CONTACTED MIN 48 HRS.
PRIOR TO BEGINING CONSTRUCTION

2) ALL EX. UTILITIES BEING CROSSED


MUST BE POTHOLED FOR DEPTH

& LOCATION PRIOR TO CONSTRUCTION.

NOTES

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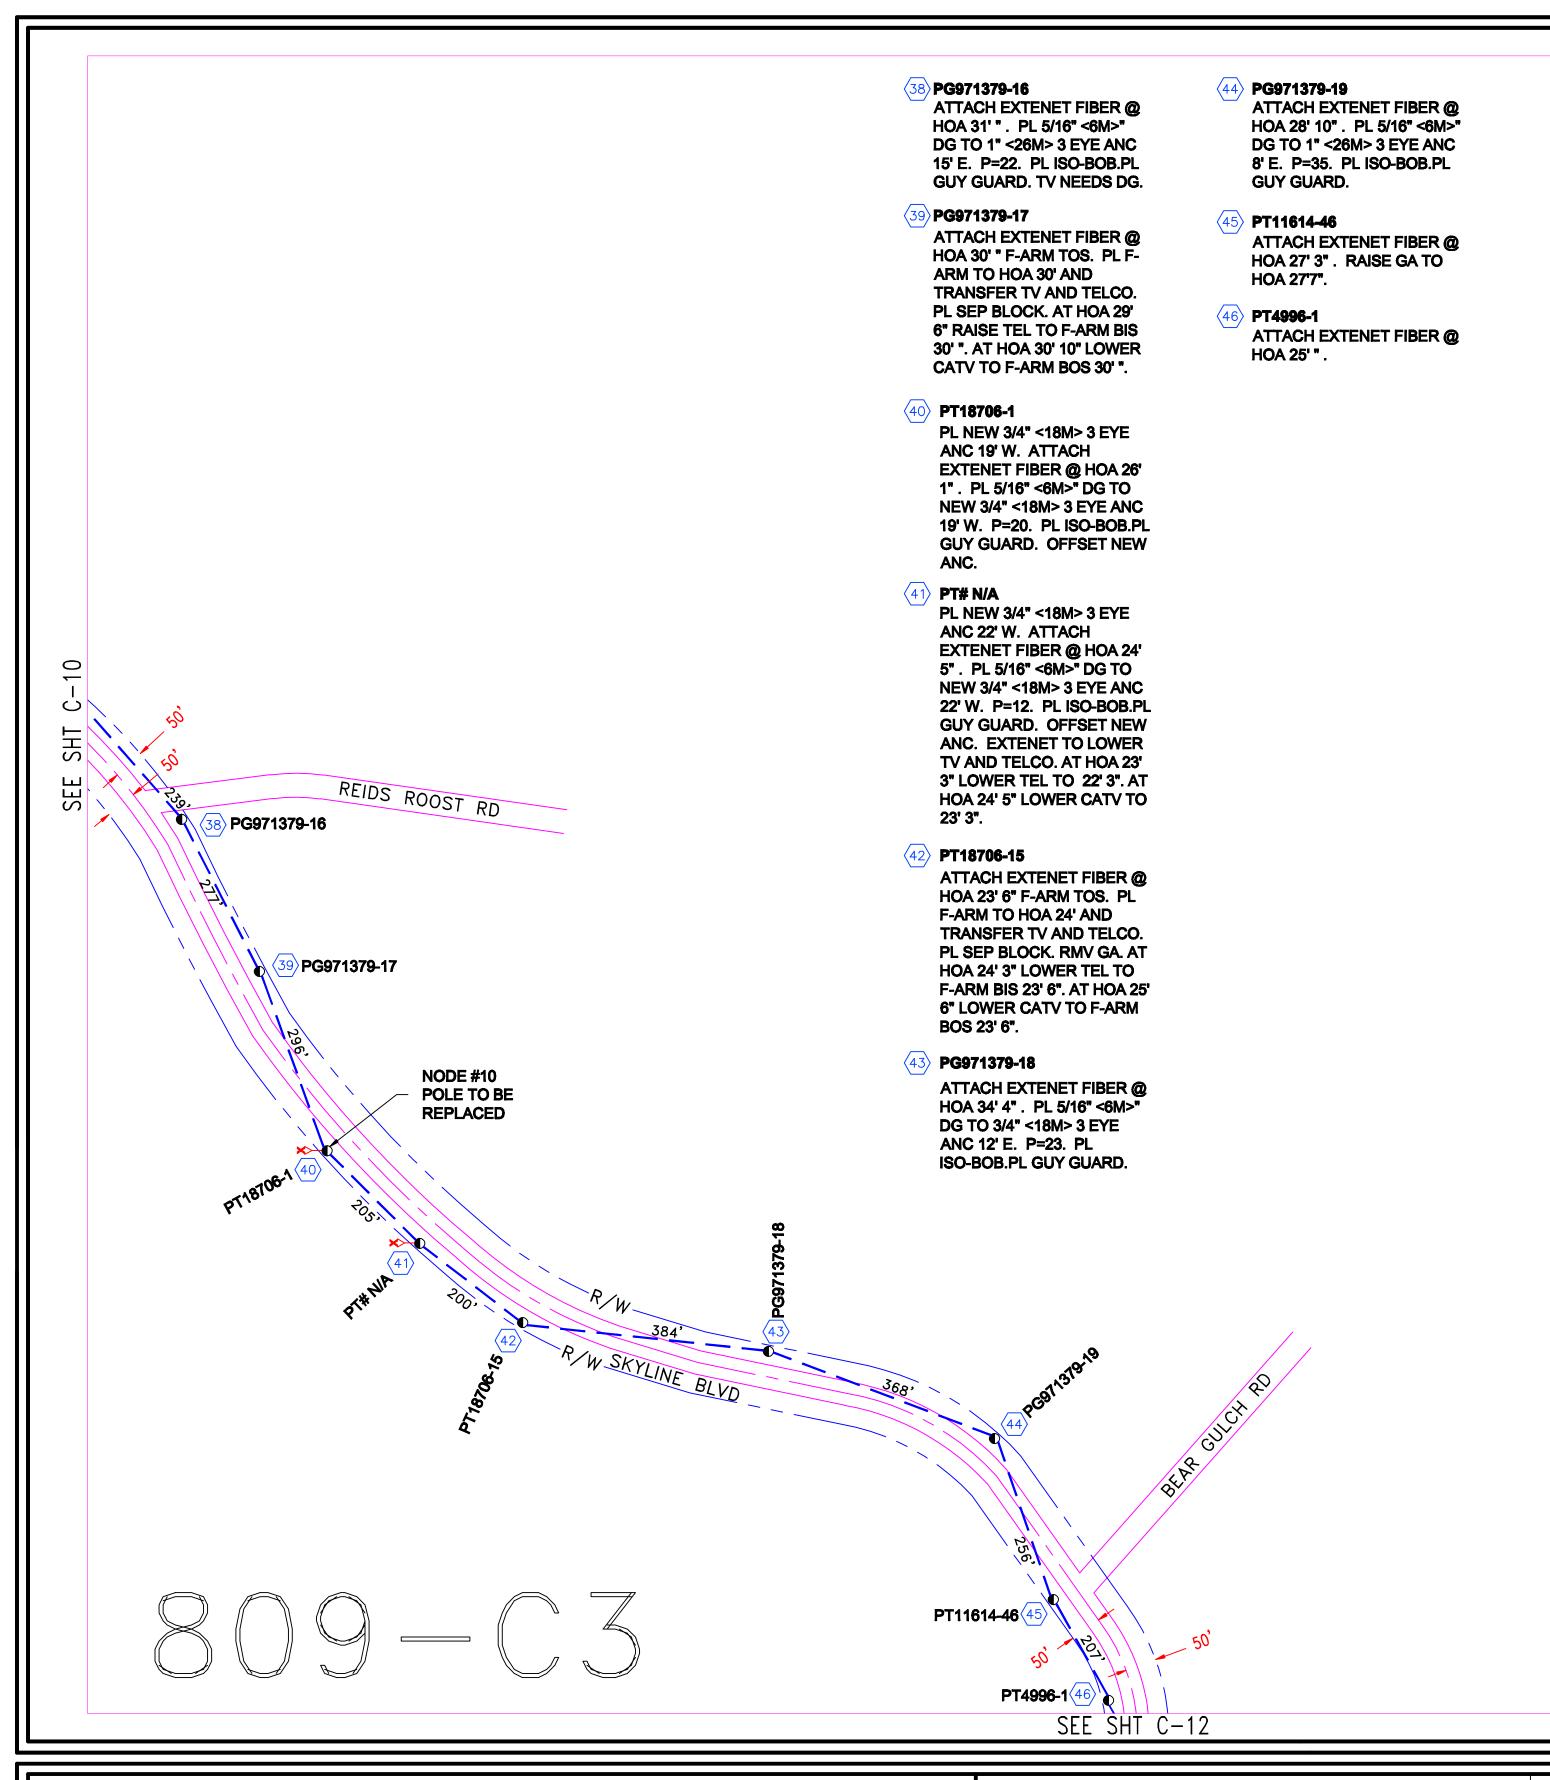
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REVISION	TOTAL FOOTAGE: 1661'	PROJECT NO.: HWY 8435	
1. TRAFFIC CONTROL PLANS 08/10/09	ENGINEERED DATE:	PROJECT NAME : SKYLINE BLVD	
2.	DRAWN BY: ICS	TG PAGE: 809-B3	
3.	DRAFT DATE: 08/10/09	JURISDICTION : COUNTY OF SAN MATEO	
4.			
5.			
6.	SKYLINE BLVD	SHEET TITLE	SHEET
7.	SAN MATEO, CA	DLAN	
8.		PLAN	C-10

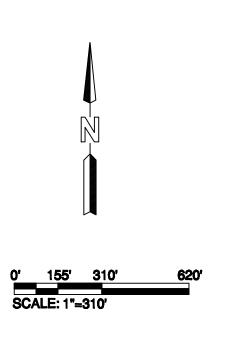

PLACEMENT DATA

PL 2432' OF AERIAL FIBER OPTIC CABLE


CONSTRUCTION NOTE:

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 PRIOR TO BEGINING CONSTRUCTION
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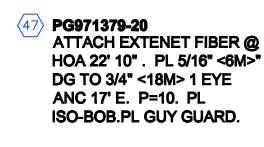






YOUR CONNECTION FOR TOMORROW....TODAY! 33490 Bailey Park Blvd, Menifee, CA 92584 (951) 672-9376

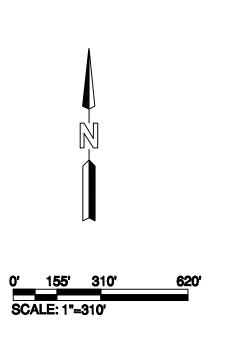REVISION	TOTAL FOOTAGE: 2432'	PROJECT NO.: HWY 8435	
TRAFFIC CONTROL PLANS 08/10/09	ENGINEERED DATE:	PROJECT NAME : SKYLINE BLVD	
	DRAWN BY: ICS	TG PAGE: 809-C3	
	DRAFT DATE: 08/10/09	JURISDICTION : COUNTY OF SAN MATE	0
	SKYLINE BLVD	SHEET TITLE	SHEET
	SAN MATEO, CA	PLAN	C-11



48 PT18058-7

ATTACH EXTENET FIBER @ HOA 25'
3". PL 5/16" <6M>" DG TO BURIED
ANC 17' E. P=18. PL ISO-BOB.PL
GUY GUARD. OFFSET NEW ANC.

49 **PT23645-1**

ATTACH EXTENET FIBER @ HOA 21' 3" . PL GA TO HOA 21'7".

PG971379-21


ATTACH EXTENET FIBER @ HOA 21' "PL DGA TO HOA 21'4". ATTACH TEL @ HOA 19' ". TELCO TO COMP POLE TRNSFR. AT HOA 22' "LOWER CATV TO 20' ".

51) **PG971379-22**

ATTACH EXTENET FIBER @ HOA 26' 2".

52 PG981196-

PL NEW 3/4" <18M> 3 EYE ANC 14' S.
PL NEW 3/4" <18M> 3 EYE ANC 24' W.
ATTACH EXTENET FIBER @ HOA 28' 5"
. ATTACH EXTENET FIBER @ HOA 28'
7". PL 1/4" <6.6M>" DG TO NEW 3/4"
<18M> 3 EYE ANC 14' S. P=DE. PL 1/4"
<6.6M>" DG TO NEW 3/4" <18M> 3 EYE
ANC 24' W. P=DE. PL ISO-BOB.PL
GUY GUARD. OFFSET NEW ANC.
LEAD CONTINUES ON APP HWY3584-3
POLE 1.

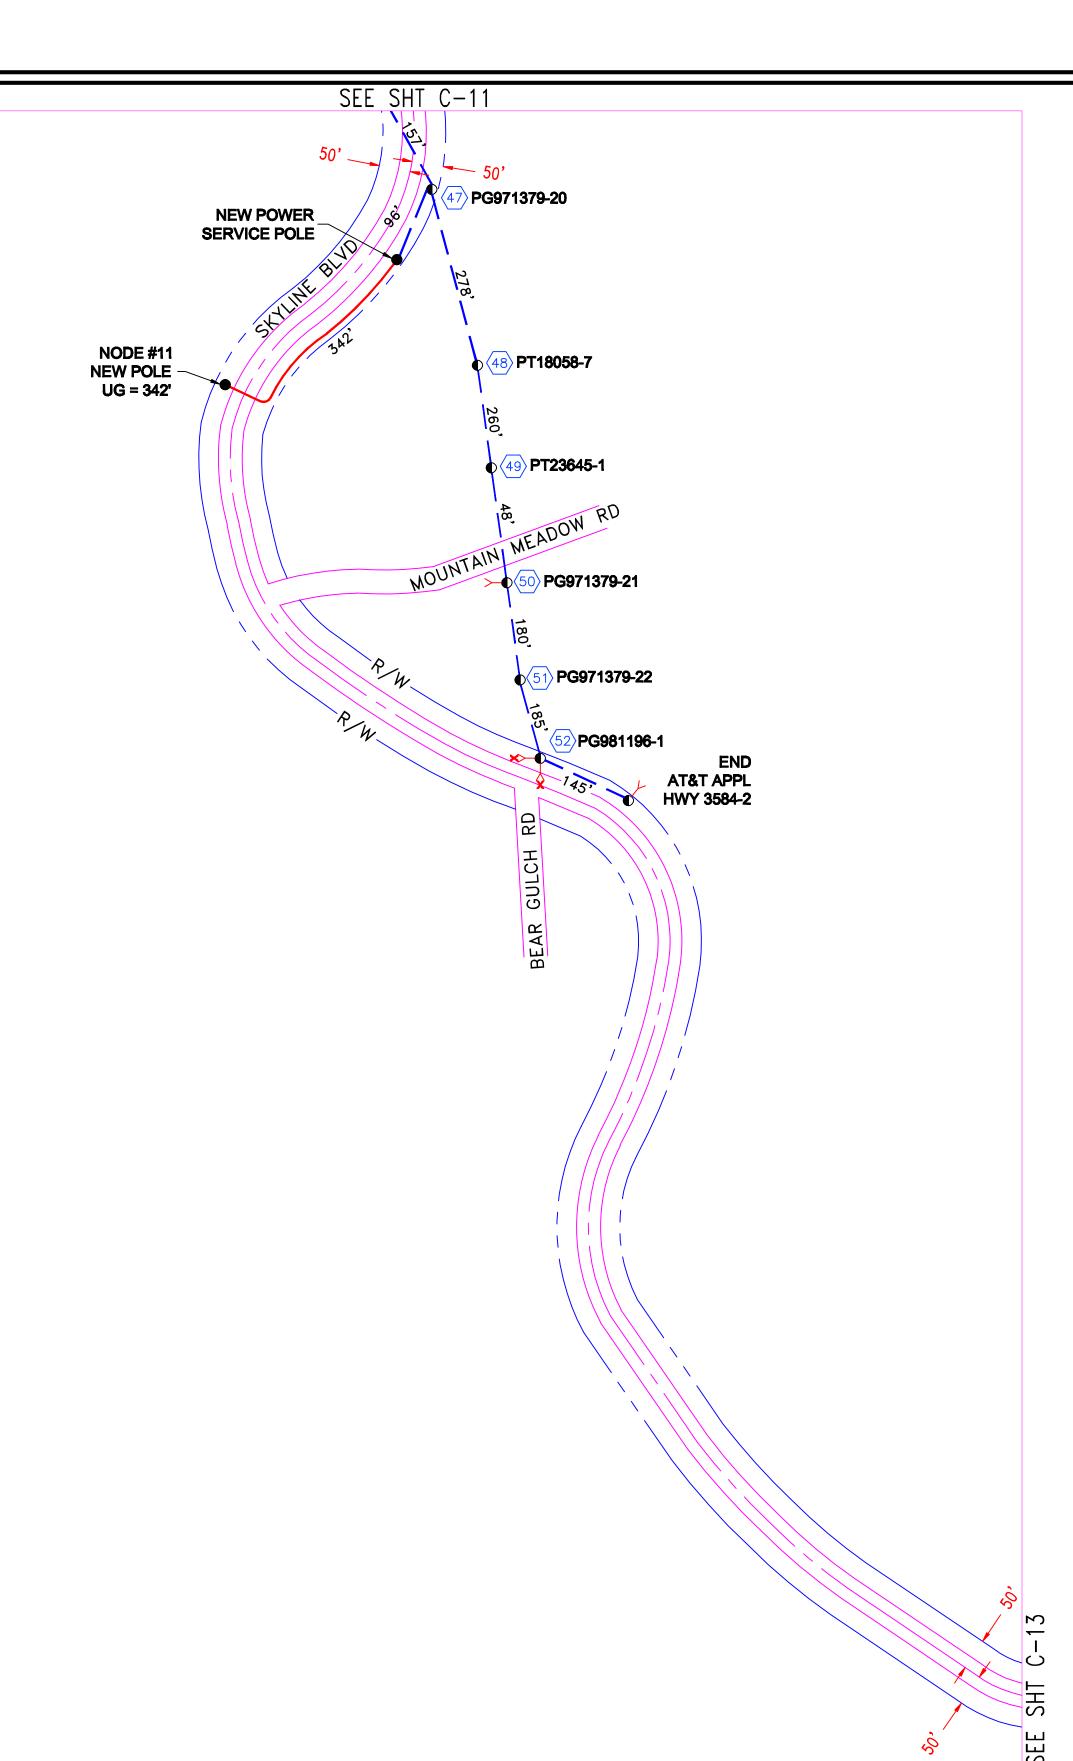

REDWOOD CITY TRAFFIC CONTROL PLANS CITY OF REDWOOD CITY

PLACEMENT DATA

PL 1349' OF AERIAL FIBER OPTIC CABLE PL 342' OF (2) 3" DUCT


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REVISION	TOTAL FOOTAGE: 1691'	PROJECT NO.: HWY 8435	
1. TRAFFIC CONTROL PLANS 08/10/09	ENGINEERED DATE:	PROJECT NAME : SKYLINE BLVD	
2.	DRAWN BY: ICS	TG PAGE: 809-C4	
3.	DRAFT DATE: 08/10/09	JURISDICTION : COUNTY OF SAN MATEO	
4.			
5.			
6.	SKYLINE BLVD	SHEET TITLE	SHEET
7.	SAN MATEO, CA	DI ANI	
8.	J. 11 107 11 E.J., 071	PLAN	C-12

PT23854-1 ATTACH EXTEN

ATTACH EXTENET FIBER @ HOA 23' 3" F-ARM TOS. RPLCE ARM W F-ARM. PL SEP BLOCK. TRNSFR TV AND TELCO TO NEW ARM. AT HOA 22' 3" RAISE TEL TO F-ARM BIS 23' 3". AT HOA 23' 3" LOWER CATV TO F-ARM BOS 23' 3".

2 PT25938-1

PL NEW 3/4" <18M> 3 EYE ANC 22' E. EXTENET ATTACH 6.6M STRAND AND LASH FIBER @ HOA 24' 6". PL 1/4" <6.6M>" DG TO NEW 3/4" <18M> 3 EYE ANC 22' E. P=26. PL ISO-BOB. PL GUY GUARD. OFFSET NEW ANC.

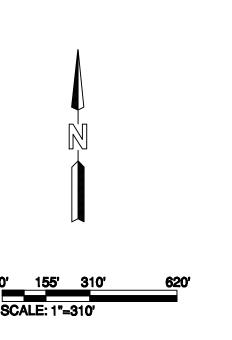3 PT25938-2

PL NEW 3/4" <18M> 3 EYE ANC 18' E. EXTENET ATTACH 6.6M STRAND AND LASH FIBER @ HOA 24' 7". PL 1/4" <6.6M>" DG TO NEW 3/4" <18M> 3 EYE ANC 18' E. P=29. PL ISO-BOB. PL GUY GUARD. OFFSET NEW ANC.

4 PG971379

PL NEW 3/4" <18M> 3 EYE ANC 16' WNW. EXTENET ATTACH 6.6M STRAND AND LASH FIBER @ HOA 23' 6". PL 1/4" <6.6M>" DG TO NEW 3/4" <18M> 3 EYE ANC 16' WNW. P=34. PL ISO-BOB. PL GUY GUARD. OFFSET NEW ANC.

5 PT25938-4

PL NEW 3/4" <18M> 3 EYE ANC 13' W.
EXTENET ATTACH 6.6M STRAND AND
LASH FIBER @ HOA 31' 10". PL 1/4"
<6.6M>" DG TO NEW 3/4" <18M> 3 EYE
ANC 13' W. P=28. PL ISO-BOB. PL GUY
GUARD. OFFSET NEW ANC.

6 PG971225-15


PL NEW 3/4" <18M> 3 EYE ANC 14' SW. EXTENET ATTACH 6.6M STRAND AND LASH FIBER @ HOA 28' 7". PL 1/4" <6.6M>" DG TO NEW 3/4" <18M> 3 EYE ANC 14' SW. P=16. PL ISO-BOB. PL GUY GUARD. OFFSET NEW ANC.

√ 7 PT25938-6

PL NEW 3/4" <18M> 3 EYE ANC 14' SW. EXTENET ATTACH 6.6M STRAND AND LASH FIBER @ HOA 29' 4". PL 1/4" <6.6M>" DG TO NEW 3/4" <18M> 3 EYE ANC 14' SW. P=15. PL ISO-BOB. PL GUY GUARD. OFFSET NEW ANC.

8 PT25938-7

EXTENET ATTACH 6.6M STRAND AND LASH FIBER @ HOA 29' " . PL 1/4" <6.6M>" DG TO 1.25" <32M> 3 EYE ANC 30' SW. P=14. PL ISO-BOB. PL GUY GUARD.

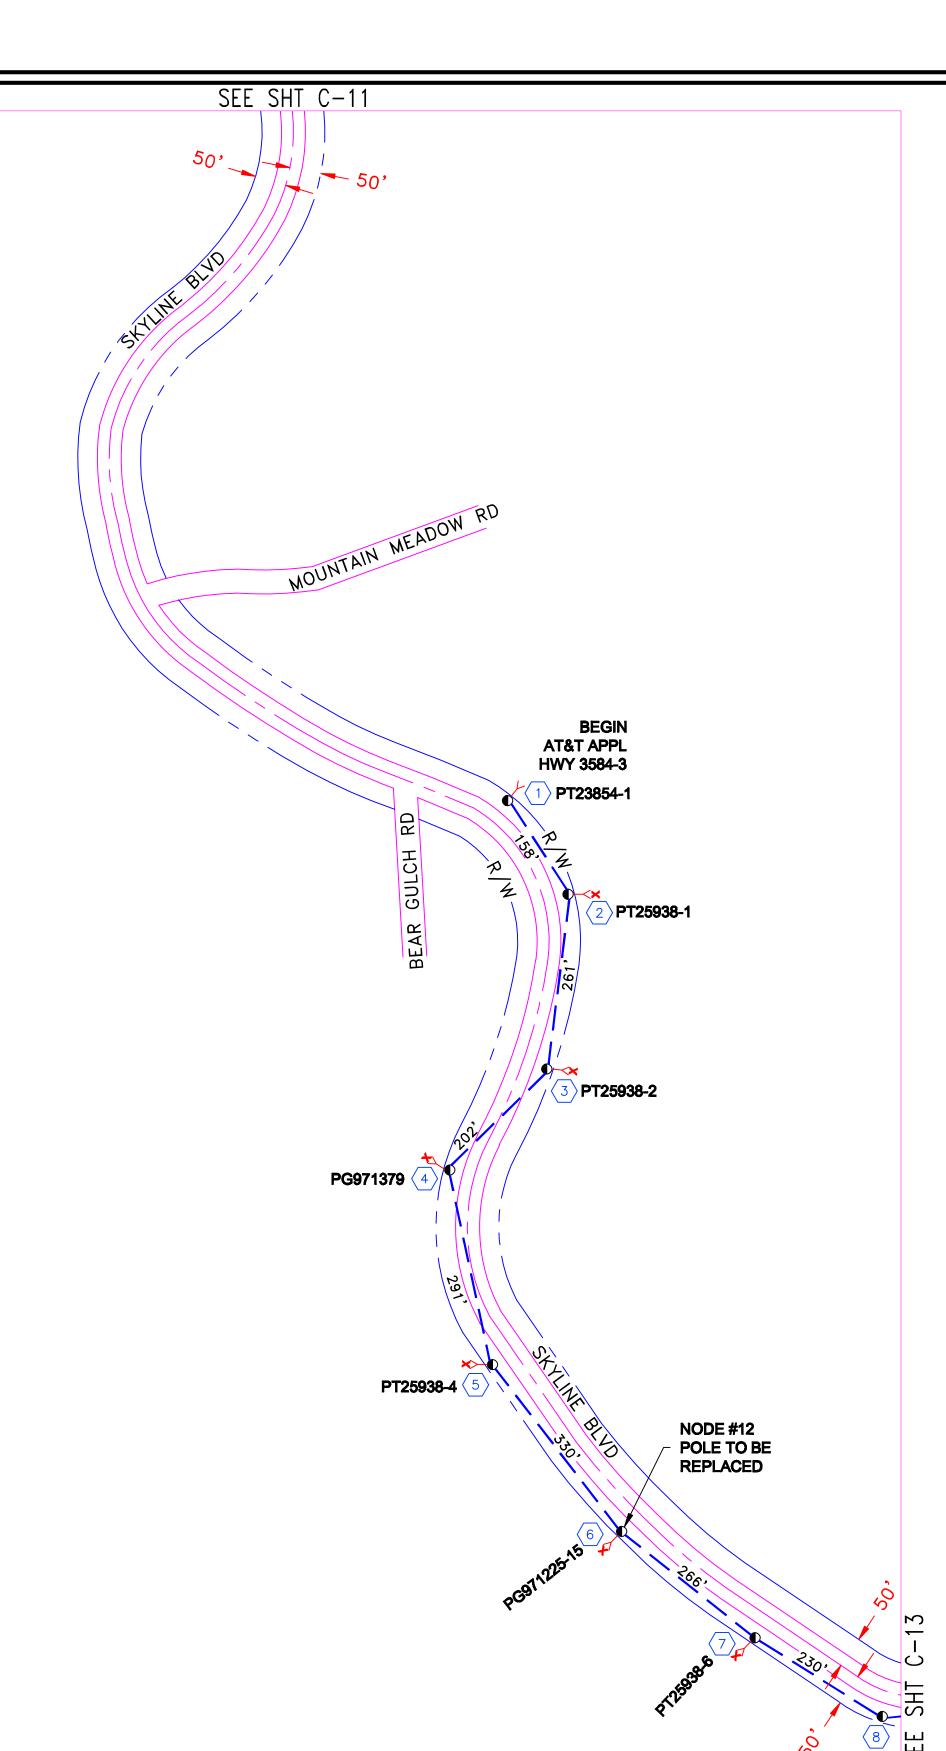

REDWOOD CITY TRAFFIC CONTROL PLANS CITY OF REDWOOD CITY

PLACEMENT DATA

PL 1738' OF AERIAL FIBER OPTIC CABLE

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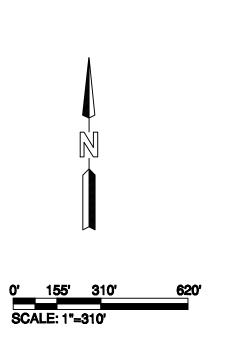
MUST BE POTHOLED FOR DEPTH

& LOCATION PRIOR TO CONSTRUCTION.

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REVISION	TOTAL FOOTAGE: 1738'	PROJECT NO.: HWY 8435	
1. TRAFFIC CONTROL PLANS 08/10/09	ENGINEERED DATE:	PROJECT NAME : SKYLINE BLVD	
2.	DRAWN BY: ICS	TG PAGE: 809-C4	
3.	DRAFT DATE: 08/10/09	JURISDICTION : COUNTY OF SAN MATEO	
4.			
5.			
6.	SKYLINE BLVD	SHEET TITLE	SHEET
7.	SAN MATEO, CA	DIANI	
8.		PLAN	C-12

PT22074-2

EXTENET ATTACH 6.6M STRAND AND LASH FIBER @ HOA 25' 11". PL 1/4" <6.6M>" DG TO 3/4" <18M> 3 EYE ANC 15' SW. P=39. PL ISO-BOB. PL GUY

PT22074-3

EXTENET ATTACH 6.6M STRAND AND LASH FIBER @ HOA 30' ". EXTENET ATTACH 6.6M STRAND AND LASH FIBER @ HOA 30' 2" . PL 1/4" <6.6M>" DG TO 1" <26M> 3 EYE ANC 24' SW. P=DE. PL 1/4" <6.6M>" DG TO 3/4" <18M> 3 EYE ANC 12' E. P=DE. PL ISO-BOB. PL GUY GUARD. TELCO NOT ATTACHED, RECENT POLE REPLACEMENT. TV NOT ATTACHED, RECENT POLE REPLACEMENT.

1 PT25938-10

PL NEW 3/4" <18M> 3 EYE ANC 13' E. EXTENET ATTACH 6.6M STRAND AND LASH FIBER @ HOA 33' 2" . PL 1/4" <6.6M>" DG TO NEW 3/4" <18M> 3 EYE ANC 13' E. P=19. PL ISO-BOB. PL GUY GUARD. OFFSET NEW ANC.

PT25938-11

PL NEW 3/4" <18M> 3 EYE ANC 23' NW. EXTENET ATTACH 6.6M STRAND AND LASH FIBER @ HOA 30' " . PL 1/4" <6.6M>" DG TO NEW 3/4" <18M> 3 EYE ANC 23' NW. P=36. PL ISO-BOB. PL GUY GUARD. OFFSET NEW ANC.

PG040075-1

PL NEW 3/4" <18M> 3 EYE ANC 56' E. PL NEW 3/4" <18M> 3 EYE ANC 27' NW. EXTENET ATTACH 6.6M STRAND AND LASH FIBER @ HOA 28' 6". EXTENET ATTACH 6.6M STRAND AND LASH FIBER @ HOA 28' 8" . PL 1/4" <6.6M>" DG TO NEW 3/4" <18M> 3 EYE ANC 56' E. P=DE. PL 1/4" <6.6M>" DG TO NEW 3/4" <18M> 3 EYE ANC 27' NW. P=DE. PL ISO-BOB. PL GUY GUARD. OFFSET NEW ANC. EAST TV DG LOOSE.

PT25938-10

PT22074-3

(14) **PT25938-13**

EXTENET ATTACH 6.6M STRAND AND LASH FIBER @ HOA 28' 6" . PL 1/4" <6.6M>" DG TO TREE 50' NE. P=31. PL ISO-BOB. PL GUY GUARD. TELCO TO COMP POLE TRNSFR. TV TO COMP POLE TRNSFR.

PT25938-14

EXTENET ATTACH 6.6M STRAND AND LASH FIBER @ HOA 35' " . PL 1/4" <6.6M>" DG TO 1" <26M> 3 EYE ANC 10' E. P=23. PL ISO-BOB. PL GUY GUARD.

PT# N/A

EXTENET ATTACH 6.6M STRAND AND LASH FIBER @ HOA 27' 4" . PL 1/4" <6.6M>" DG TO 3/4" <18M> 3 EYE ANC 17' W. P=17. PL ISO-BOB. PL GUY GUARD.

PG070129-1

PL NEW 3/4" <18M> 3 EYE ANC 18' NW. PL NEW 3/4" <18M> 3 EYE ANC 14' S. **EXTENET ATTACH 6.6M STRAND AND** LASH FIBER @ HOA 27' 3". EXTENET ATTACH 6.6M STRAND AND LASH FIBER @ HOA 27' 5". PL 1/4" <6.6M>" DG TO NEW 3/4" <18M> 3 EYE ANC 18' NW. P=DE. PL 1/4" <6.6M>" DG TO NEW 3/4" <18M> 3 EYE ANC 14' S. P=DE. PL ISO-BOB. PL GUY **GUARD. OFFSET NEW ANC.**

8 PT# N/A **EXTENET ATTACH 6.6M STRAND AND** LASH FIBER @ HOA 25' 8" . PL 1/4" <6.6M>" DG TO 5/8" <12M> 2 EYE ANC 18' S. P=21. PL ISO-BOB. PL GUY GUARD.

PT# N/A

PL NEW 3/4" <18M> 3 EYE ANC 23' N. PL NEW 3/4" <18M> 3 EYE ANC 23' E. **EXTENET ATTACH 6.6M STRAND AND** LASH FIBER @ HOA 23' 3". EXTENET ATTACH 6.6M STRAND AND LASH FIBER @ HOA 23' 5". PL 1/4" <6.6M>" DG TO NEW 3/4" <18M> 3 EYE ANC 23' N. P=DE. PL 1/4" <6.6M>" DG TO NEW 3/4" <18M> 3 EYE ANC 23' E. P=DE. PL ISO-BOB. PL GUY GUARD. OFFSET NEW ANC. EXTENET TO LOWER TV. AT HOA 22' 7" LOWER CATV TO 22' ".

PL NEW 3/4" <18M> 3 EYE ANC 24' S. **EXTENET ATTACH 6.6M STRAND AND** LASH FIBER @ HOA 25' 4". EXTENET ATTACH 6.6M STRAND AND LASH FIBER @ HOA 25' 2" . PL 1/4" <6.6M>" DG TO 3/4" <18M> 3 EYE ANC 17' S. P=DE. PL 1/4" <6.6M>" DG TO NEW 3/4" <18M> 3 EYE ANC 24' S. P=DE. PL ISO-BOB. PL GUY GUARD. OFFSET NEW ANC.

PT# N/A

PT# N/A PG ONLY POLE

PG ONLY POLE

PT# N/A (21) /- 50'

SEE SHT C-14

PL NEW 3/4" <18M> 3 EYE ANC 14' W. **EXTENET ATTACH 6.6M STRAND AND** LASH FIBER @ HOA 24' 5" . PL 1/4" <6.6M>" DG TO NEW 3/4" <18M> 3 EYE ANC 14' W. P=31. PL ISO-BOB. PL GUY GUARD. OFFSET NEW ANC.

REDWOOD CITY TRAFFIC CONTROL PLANS CITY OF REDWOOD CITY

PLACEMENT DATA


PL 2931' OF AERIAL FIBER OPTIC CABLE

CONSTRUCTION NOTE: 1) USA UTILITY ALERT MUST BE CONTACTED MIN 48 HRS. PRIOR TO BEGINING CONSTRUCTION

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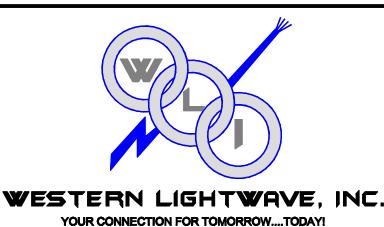
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NODE #13 POLE TO BE -REPLACED

PT# N/A

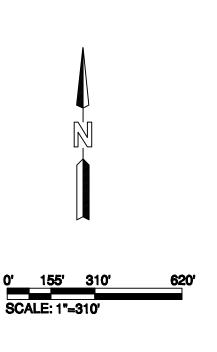

33490 Bailey Park Blvd, Menifee, CA 92584

PT# N/A PG ONLY POLE

REVISION	TOTAL FOOTAGE: 2931'	PROJECT NO.: HWY 8435	
1. TRAFFIC CONTROL PLANS 08/10/09	ENGINEERED DATE:	PROJECT NAME : SKYLINE BLVI)
2.	DRAWN BY: ICS	TG PAGE: 809-D4	
3.	DRAFT DATE: 08/10/09	JURISDICTION : COUNTY OF SAI	N MATEO
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6.	SKYLINE BLVD	SHEET TITLE	SHEET
7.	SAN MATEO, CA	DLAN	C 10
	37 (1 1 1 1 1 1 2 3 3 7 1 1 1 1 1 1 2 3 3 7 1 1 1 1 1 1 2 3 3 7 1 1 1 1 1 1 1 1 1 1 1 1 1 1 1 1 1	PLAN	C-13

PT# N/A PL NEW 3/4" <18M> 3 EYE ANC 15' W. **EXTENET ATTACH 6.6M STRAND AND** LASH FIBER @ HOA 24' 10". PL 1/4" <6.6M>" DG TO NEW 3/4" <18M> 3 EYE ANC 15' W. P=19. PL ISO-BOB. PL GUY GUARD. OFFSET NEW ANC. PT# N/A PL NEW 3/4" <18M> 3 EYE ANC 11' SW. **EXTENET ATTACH 6.6M STRAND AND**

LASH FIBER @ HOA 25' 6" . PL 1/4" <6.6M>" DG TO NEW 3/4" <18M> 3 EYE ANC 11' SW. P=7. PL ISO-BOB. PL GUY GUARD. OFFSET NEW ANC.

PT# N/A **EXTENET ATTACH 6.6M STRAND AND** LASH FIBER @ HOA 28' 5" . PL 1/4" <6.6M>" DG TO 3/4" <18M> 3 EYE ANC 14' SE. P=28. PL ISO-BOB. PL GUY GUARD.

PT# N/A PL NEW 3/4" <18M> 3 EYE ANC 15' E. **EXTENET ATTACH 6.6M STRAND AND** LASH FIBER @ HOA 31' " . PL 1/4" <6.6M>" DG TO NEW 3/4" <18M> 3 EYE ANC 15' E. P=25. PL ISO-BOB. PL GUY GUARD. OFFSET NEW ANC.

PT# N/A PL NEW 3/4" <18M> 3 EYE ANC 14' W. **EXTENET ATTACH 6.6M STRAND AND** LASH FIBER @ HOA 27' " . PL 1/4" <6.6M>" DG TO NEW 3/4" <18M> 3 EYE ANC 14' W. P=30. PL ISO-BOB. PL GUY GUARD. OFFSET NEW ANC.

PT# N/A PL NEW 3/4" <18M> 3 EYE ANC 16' NE. EXTENET ATTACH 6.6M STRAND AND LASH FIBER @ HOA 26' 6" . PL 1/4" <6.6M>" DG TO NEW 3/4" <18M> 3 EYE ANC 16' NE. P=27. PL ISO-BOB. PL GUY GUARD. OFFSET NEW ANC.

28) PT# N/A PL NEW 3/4" <18M> 3 EYE ANC 17' S. **EXTENET ATTACH 6.6M STRAND AND** LASH FIBER @ HOA 25' 10". PL 1/4" <6.6M>" DG TO NEW 3/4" <18M> 3 EYE ANC 17' S. P=39. PL ISO-BOB. PL GUY GUARD. OFFSET NEW ANC.

SEE SHT C-13 PG ONLY POLE **PG ONLY POLE** PT# N/A PG ONLY POLE PT# N/A PG ONLY POLE PT# N/A (26) ×> POLE TO BE-**PG ONLY POLE** REPLACED PG ONLY POLE

REDWOOD CITY TRAFFIC CONTROL PLANS CITY OF REDWOOD CITY

PLACEMENT DATA


PL 1629' OF AERIAL FIBER OPTIC CABLE

CONSTRUCTION NOTE:

- 1) USA UTILITY ALERT MUST BE CONTACTED MIN 48 HRS. PRIOR TO BEGINING CONSTRUCTION
- 2) ALL EX. UTILITIES BEING CROSSED MUST BE POTHOLED FOR DEPTH & LOCATION PRIOR TO CONSTRUCTION.

UNDERGROUND UTILITIES HAVE BEEN PLOTTED FROM AVAILABLE RECORDS AND FIELD OBSERVATIONS, BUT ARE NOT NECESSARILY EXACT. THEREFORE, UTILITY LOCATIONS WILL BE VERIFIED AT LEAST 100 FEET IN ADVANCE OF TRENCHING, DIRECTIONAL BORING OR PLOWING SO THAT CHANGES IN CONDUIT PLACEMENT CAN BE MADE IN THE EVENT OF CONFLICTS.

ALL KNOWN BURIED OBSTRUCTIONS ARE SHOWN ON THE CONSTRUCTION DRAWINGS. ANY AND ALL OTHERS ENCOUNTERED ARE ALSO THE RESPONSIBILITY OF THE CONTRACTOR TO LOCATE, PROTECT, AND REPAIR, IF DAMAGED

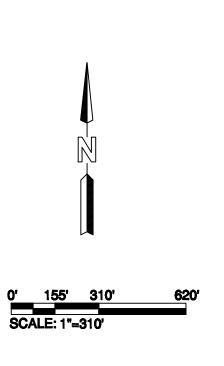





REVISION	TOTAL FOOTAGE: 1629'	PROJECT NO.: HWY 8435	
1. TRAFFIC CONTROL PLANS 08/10/09	ENGINEERED DATE:	PROJECT NAME : SKYLINE BLVD	
2.	DRAWN BY: ICS	TG PAGE: 809-D5	
3.	DRAFT DATE: 08/10/09	JURISDICTION : COUNTY OF SAN MATEO	
4.			
5.			
6.	SKYLINE BLVD	SHEET TITLE	SHEET
7.	SAN MATEO, CA	DI ANI	
8 .		PLAN	C-14

PG ONLY POLE SKYLINE BLVD PT# N/A PG ONLY POLE PT# N/A PG ONLY POLE PG ONLY POLE PT# N/A **NODE #15** POLE TO BE **REPLACED** PT# N/A PT# N/A PT# N/A PT# N/A

EXTENET ATTACH 6.6M STRAND AND LASH FIBER @ HOA 25' 4" . PL 1/4" <6.6M>" DG TO 1" <26M> 3 EYE ANC 13' NW. P=DE. PL 1/4" <6.6M>" DG TO 1" <26M> 3 EYE ANC 16' NE. P=DE. PL ISO-BOB. PL GUY

EXTENET ATTACH 6.6M STRAND AND LASH FIBER @ HOA 26' 5".

PT# N/A

PL NEW 3/4" <18M> 3 EYE ANC 16' S. **EXTENET ATTACH 6.6M STRAND AND** LASH FIBER @ HOA 25' 9" . PL 1/4" <6.6M>" DG TO NEW 3/4" <18M> 3 EYE ANC 16' S. P=38. PL ISO-BOB. PL GUY GUARD.

PT# N/A

PL NEW 3/4" <18M> 3 EYE ANC 20' N. EXTENET ATTACH 6.6M STRAND AND LASH FIBER @ HOA 25' 2" . PL 1/4" <6.6M>" DG TO NEW 3/4" <18M> 3 EYE ANC 20' N. P=37. PL ISO-BOB. PL GUY GUARD. OFFSET NEW ANC.

PL NEW 3/4" <18M> 3 EYE ANC 14' NE. **EXTENET ATTACH 6.6M STRAND AND** LASH FIBER @ HOA 22' 9" . PL 1/4" <6.6M>" DG TO NEW 3/4" <18M> 3 EYE ANC 14' NE. P=36. PL ISO-BOB. PL GUY GUARD. OFFSET NEW ANC. EXTENET TO LOWER TV. AT HOA 22' 9" LOWER CATV TO 21' 9".

PT# N/A

PL NEW 3/4" <18M> 3 EYE ANC 17' S. EXTENET ATTACH 6.6M STRAND AND LASH FIBER @ HOA 24' 6" . PL 1/4" <6.6M>" DG TO NEW 3/4" <18M> 3 EYE ANC 17' S. P=43. PL ISO-BOB. PL GUY GUARD. OFFSET NEW ANC.

PT# N/A

EXTENET ATTACH 6.6M STRAND AND LASH FIBER @ HOA 26' 5". EXTENET ATTACH 6.6M STRAND AND LASH FIBER @ HOA 26' 7". PL 1/4" <6.6M>" DG TO BURIED ANC 21' S. P=DE. PL 1/4" <6.6M>" DG TO 3/4" <18M> 3 EYE ANC 17' NE. P=DE. PL ISO-BOB. PL GUY GUARD.

PL NEW 3/4" <18M> 3 EYE ANC 11' E. **EXTENET ATTACH 6.6M STRAND AND** LASH FIBER @ HOA 27' 3" . PL 1/4" <6.6M>" DG TO NEW 3/4" <18M> 3 EYE ANC 11' E. P=19. PL ISO-BOB. PL GUY GUARD. OFFSET NEW ANC.

PT# N/A

EXTENET ATTACH 6.6M STRAND AND LASH FIBER @ HOA 32' ".

(38) **PT# N/A**

EXTENET ATTACH 6.6M STRAND AND LASH FIBER @ HOA 29' " . PL GA TO HOA

PT# N/A

PL NEW 3/4" <18M> 3 EYE ANC 20' N. PL NEW 3/4" <18M> 3 EYE ANC 20' SW. **EXTENET ATTACH 6.6M STRAND AND** LASH FIBER @ HOA 23' 4". EXTENET ATTACH 6.6M STRAND AND LASH FIBER @ HOA 23' 2". PL 1/4" <6.6M>" DG TO NEW 3/4" <18M> 3 EYE ANC 20' N. P=DE. PL 1/4" <6.6M>" DG TO NEW 3/4" <18M> 3 EYE ANC 20' SW. P=DE. PL ISO-BOB. PL GUY **GUARD. OFFSET NEW ANC. EXTENET TO** LOWER TV. AT HOA 23' 4" LOWER CATV TO 22' 2". AT HOA 23' 2" LOWER CATV TO

PL NEW 3/4" <18M> 3 EYE ANC 11' N. **EXTENET ATTACH 6.6M STRAND AND** LASH FIBER @ HOA 24' 8" . PL 1/4" <6.6M>" DG TO NEW 3/4" <18M> 3 EYE ANC 11' N. P=27. PL ISO-BOB. PL GUY GUARD. OFFSET NEW ANC. RAISE GA TO HOA 25'.

PL NEW 3/4" <18M> 3 EYE ANC 14' N. EXTENET ATTACH 6.6M STRAND AND LASH FIBER @ HOA 27' 8" . PL 1/4" <6.6M>" DG TO NEW 3/4" <18M> 3 EYE ANC 14' N. P=3. PL ISO-BOB. PL GUY GUARD. OFFSET NEW ANC.

PT# N/A

EXTENET ATTACH 6.6M STRAND AND LASH FIBER @ HOA 27' 8" . PL 1/4" <6.6M>" DG TO 3/4" <18M> 3 EYE ANC 10' N. P=16. PL ISO-BOB. PL GUY GUARD. TV NEEDS

REDWOOD CITY TRAFFIC CONTROL PLANS CITY OF REDWOOD CITY

PLACEMENT DATA


PL 3533' OF AERIAL FIBER OPTIC CABLE

CONSTRUCTION NOTE:


- 1) USA UTILITY ALERT MUST BE CONTACTED MIN 48 HRS. PRIOR TO BEGINING CONSTRUCTION
- 2) ALL EX. UTILITIES BEING CROSSED MUST BE POTHOLED FOR DEPTH & LOCATION PRIOR TO CONSTRUCTION.

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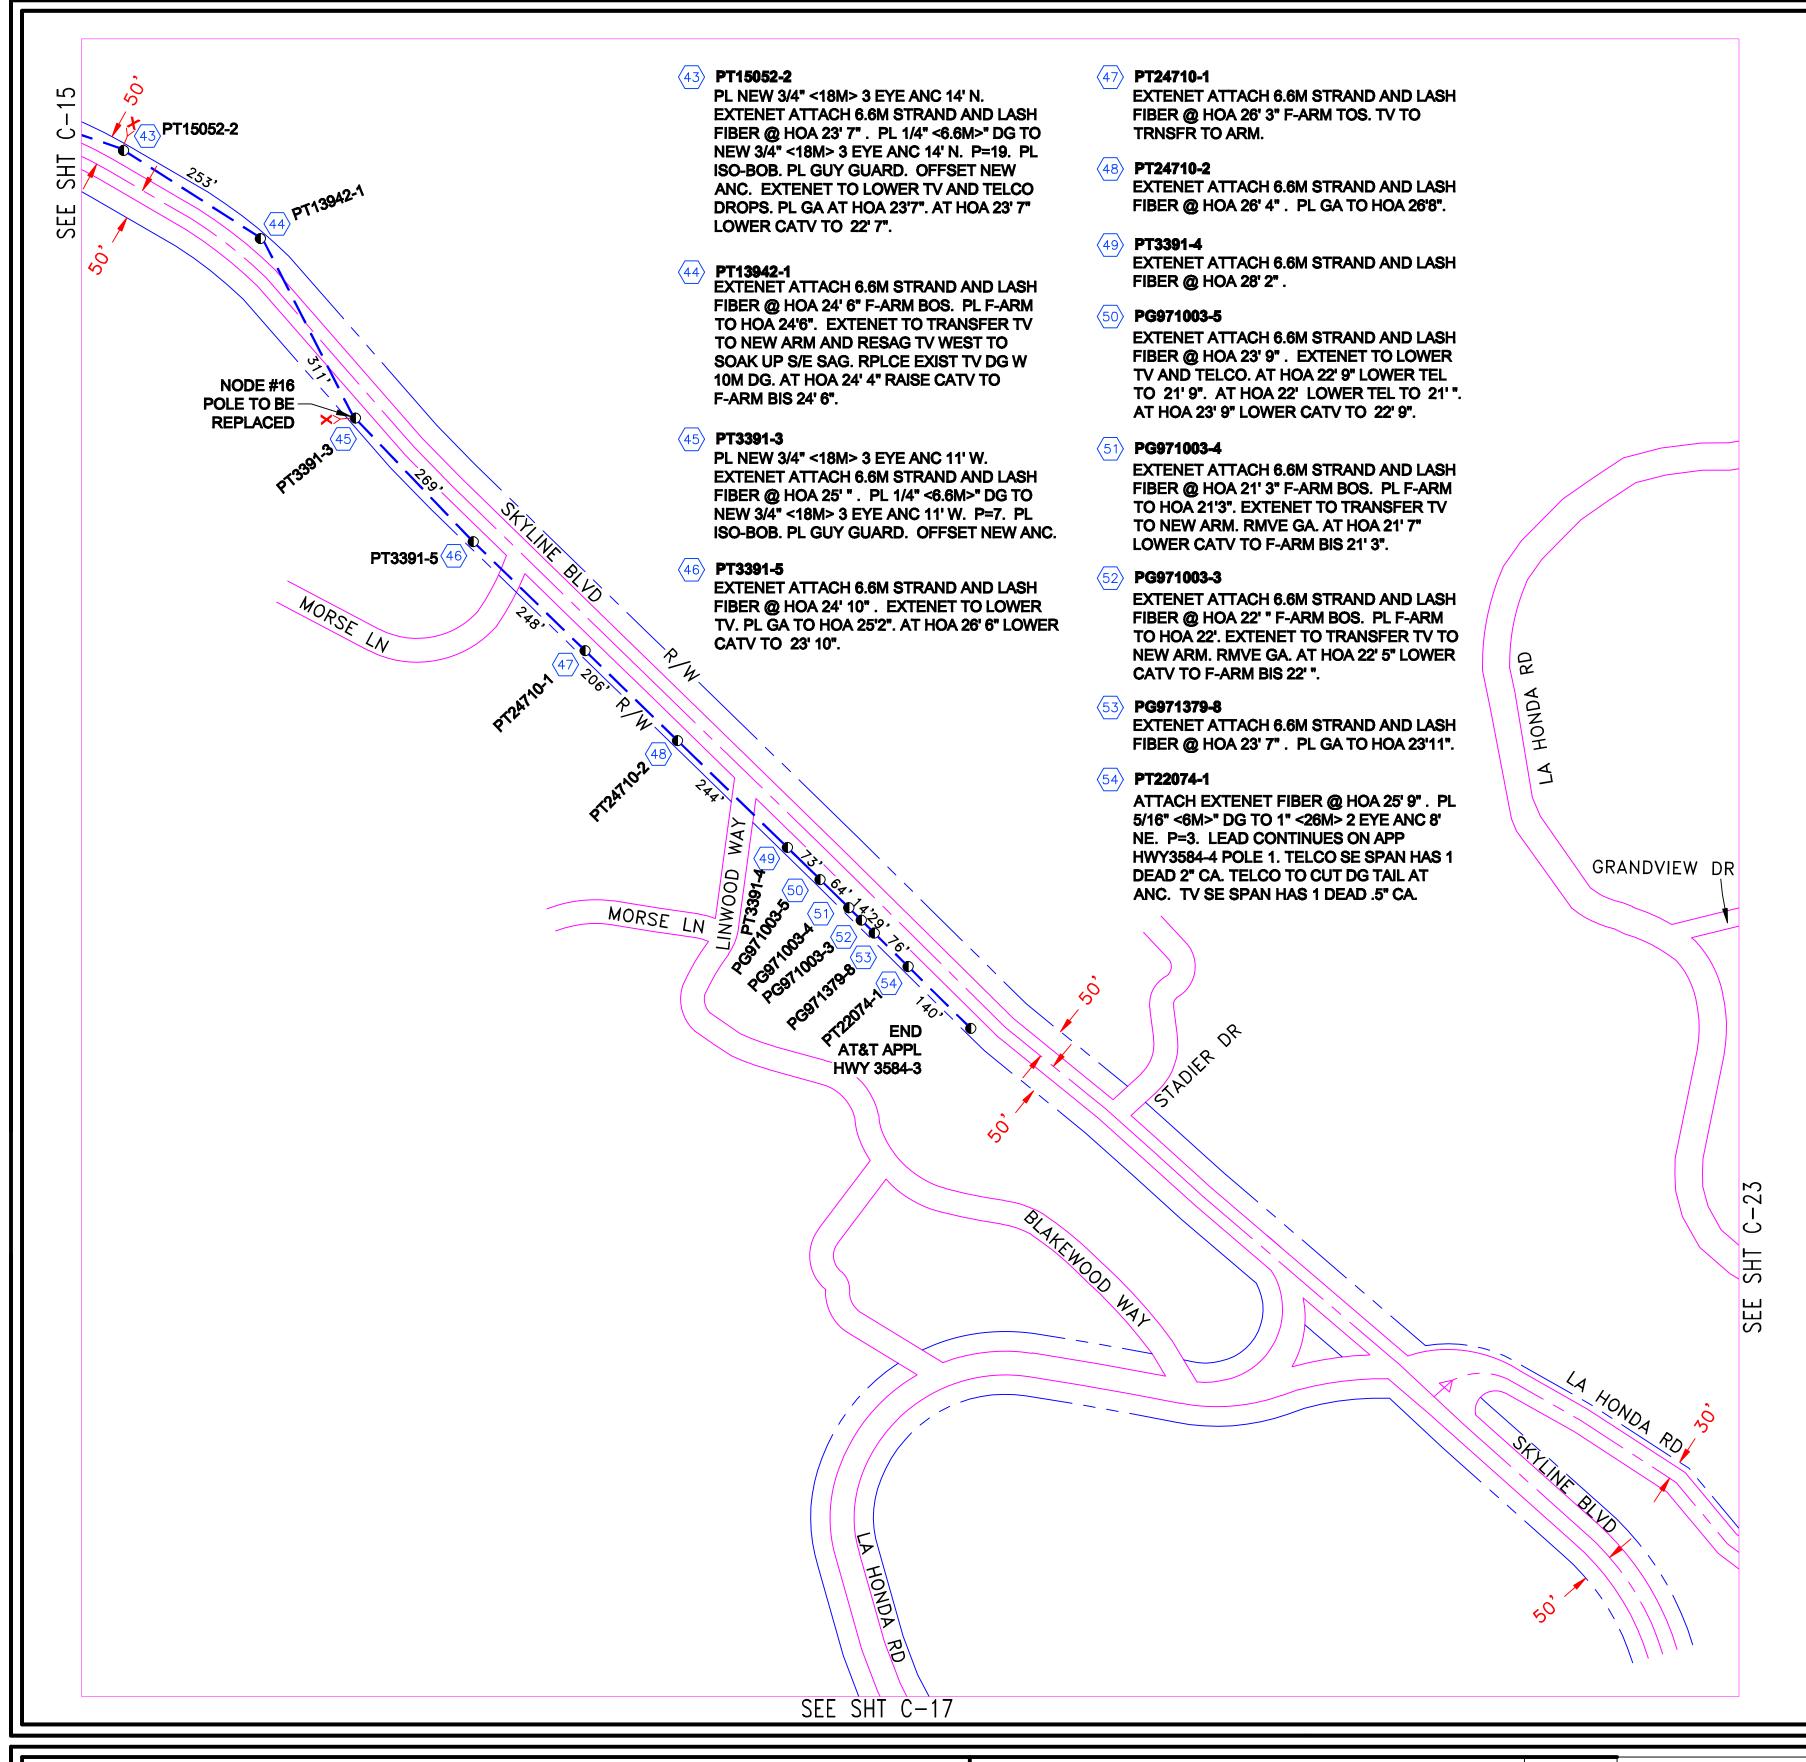




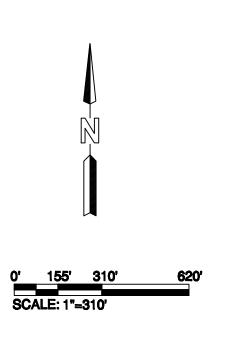

33490 Bailey Park Blvd, Menifee, CA 92584

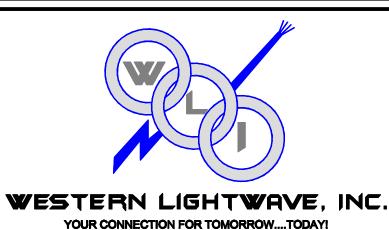REVISION	TOTAL FOOTAGE: 3533'	PROJECT NO.: HWY 8435	
1. TRAFFIC CONTROL PLANS 08/10/09	ENGINEERED DATE:	PROJECT NAME : SKYLINE BLVD	
2.	DRAWN BY: ICS	TG PAGE: 809-E5	
3.	DRAFT DATE: 08/10/09	JURISDICTION : COUNTY OF SAN MATEO	
4.			
5.			
6.	SKYLINE BLVD	SHEET TITLE	SHEET
7.	SAN MATEO, CA	DI ANI	C 15
8.	57 H 1 1111 1 1 2 3 7 7 1	PLAN	C-15



PLACEMENT DATA

PL 1927' OF AERIAL FIBER OPTIC CABLE


CONSTRUCTION NOTE:

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 BE CONTACTED MIN 48 HRS.
 PRIOR TO BEGINING CONSTRUCTION
- 2) ALL EX. UTILITIES BEING CROSSED MUST BE POTHOLED FOR DEPTH & LOCATION PRIOR TO CONSTRUCTION.

NOTES:

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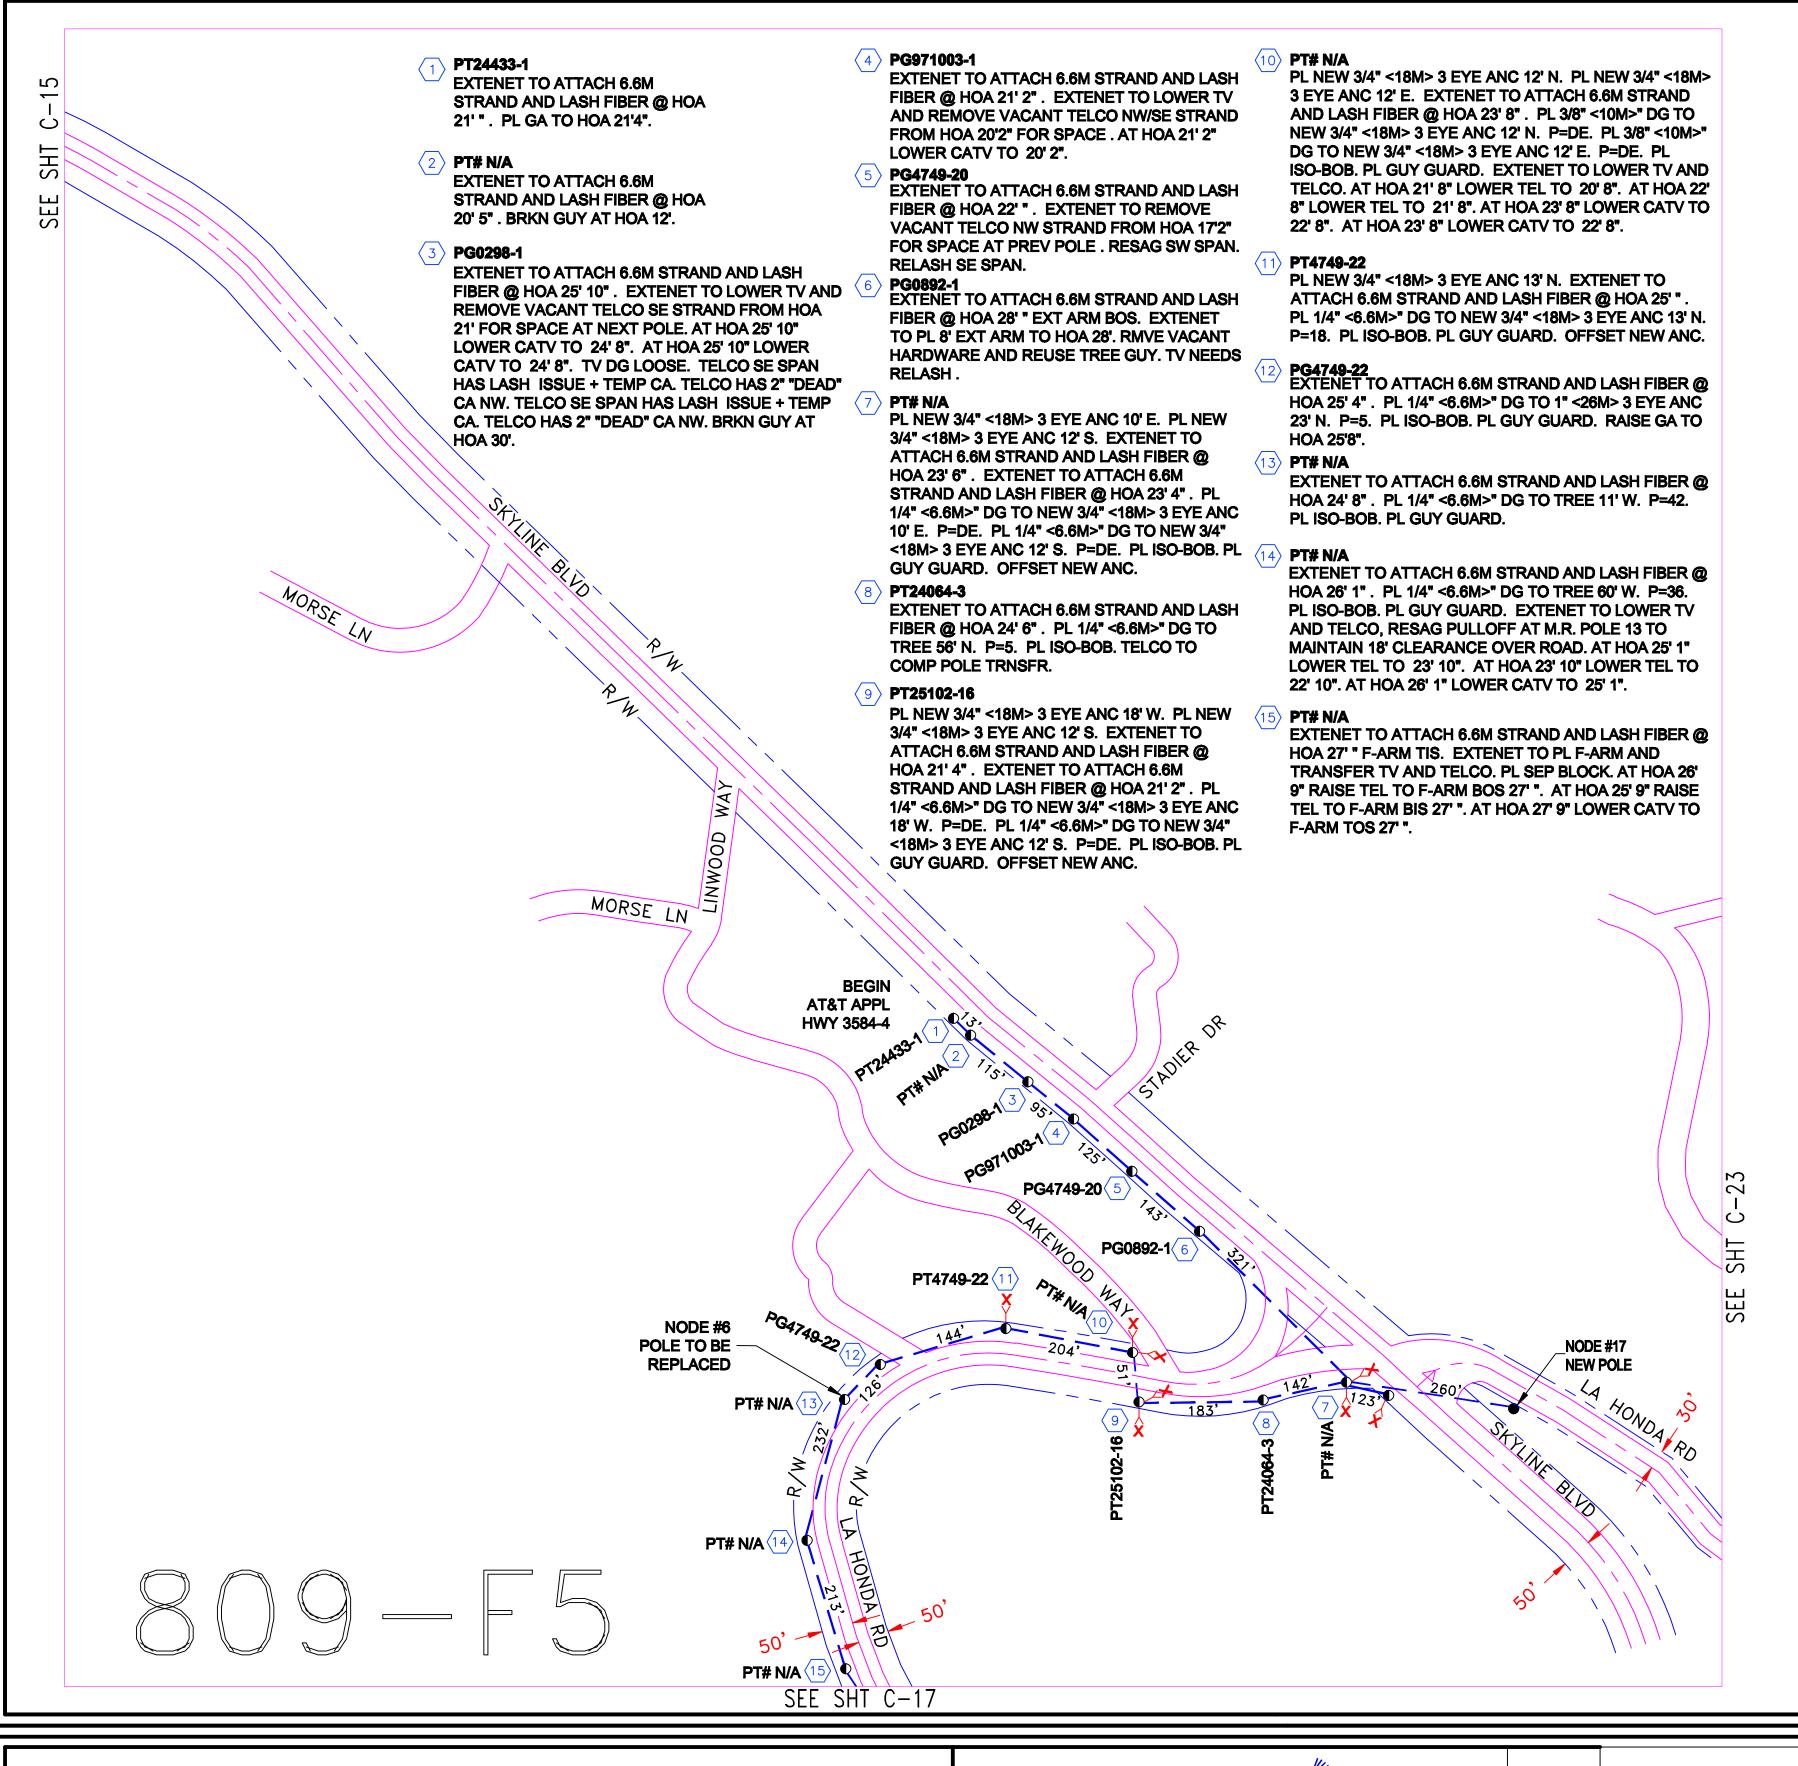


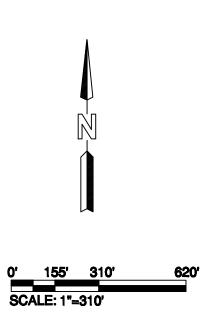

YOUR CONNECTION FOR TOMORROW....TODAY! 33490 Bailey Park Blvd, Menifee, CA 92584

1

REVISION	TOTAL FOOTAGE: 1927'	PROJECT NO.: HWY 8435	
1. TRAFFIC CONTROL PLANS 08/10/09	ENGINEERED DATE:	PROJECT NAME : SKYLINE BLVI)
2.	DRAWN BY: ICS	TG PAGE: 809-F5	
3.	DRAFT DATE: 08/10/09	JURISDICTION : COUNTY OF SAI	N MATEO
4.			
5.			
6.	SKYLINE BLVD	SHEET TITLE	SHEET
7.	SAN MATEO, CA	DI ANI	
8.	57 tt 1817 (1 E 5, 57 (PLAN	C-16



PLACEMENT DATA

PL 2490' OF AERIAL FIBER OPTIC CABLE


CONSTRUCTION NOTE:

- 1) USA UTILITY ALERT MUST
 BE CONTACTED MIN 48 HRS.
 PRIOR TO BEGINING CONSTRUCTION
- 2) ALL EX. UTILITIES BEING CROSSED MUST BE POTHOLED FOR DEPTH & LOCATION PRIOR TO CONSTRUCTION.

OTES:

UNDERGROUND UTILITIES HAVE BEEN PLOTTED FROM AVAILABLE RECORDS AND FIELD OBSERVATIONS, BUT ARE NOT NECESSARILY EXACT. THEREFORE, UTILITY LOCATIONS WILL BE VERIFIED AT LEAST 100 FEET IN ADVANCE OF TRENCHING, DIRECTIONAL BORING OR PLOWING SO THAT CHANGES IN CONDUIT PLACEMENT CAN BE MADE IN THE EVENT OF CONFLICTS.

ALL KNOWN BURIED OBSTRUCTIONS ARE SHOWN ON THE CONSTRUCTION DRAWINGS.
ANY AND ALL OTHERS ENCOUNTERED ARE ALSO THE RESPONSIBILITY OF THE
CONTRACTOR TO LOCATE, PROTECT, AND REPAIR, IF DAMAGED.

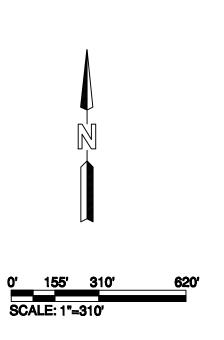

SHEET

C-16





YOUR CONNECTION FOR TOMORROW....TODAY

33490 Bailey Park Blvd, Menifee, CA 92584

REVISION	TOTAL FOOTAGE: 2490'	PROJECT NO.: HWY 8435	
RAFFIC CONTROL PLANS 08/10/09	ENGINEERED DATE:	PROJECT NAME : SKYLINE BLVD	
	DRAWN BY: ICS	TG PAGE : 809-F5	
	DRAFT DATE: 08/10/09	JURISDICTION : COUNTY OF SAN MAT	EO
	SKYLINE BLVD	SHEET TITLE	SI
	SAN MATEO, CA	DLAN	
	1	PLAN	

PT# N/A EXTENET TO ATTACH 6.6M STRAND AND LASH FIBER @ HOA 27' " F-ARM TIS. PL SEP BLOCK.

- PT# N/A
 EXTENET TO ATTACH 6.6M STRAND
 AND LASH FIBER @ HOA 27' ".
- PT# N/A
 EXTENET TO ATTACH 6.6M
 STRAND AND LASH FIBER @ HOA
 27' 6". PL 1/4" <6.6M>" DG TO
 TREE 42' E. P=33. PL ISO-BOB. PL
 GUY GUARD. EXTENET TO LOWER
 TV AND TELCO. AT HOA 26' 6"
 LOWER TEL TO 25' 6". AT HOA 25'
 6" LOWER TEL TO 24' 6". AT HOA
 27' 6" LOWER CATV TO 26' 6".
- PT# N/A
 EXTENET TO ATTACH 6.6M
 STRAND AND LASH FIBER @ HOA
 27' 6" F-ARM TIS. EXTENET TO
 MOVE TV. PL SEP BLOCK. AT HOA
 27' 6" LOWER CATV TO F-ARM TOS
 27' 6"
- PT4790-1
 DO NOT ATTACH. NO SPACE. SET
 35' CLASS 5 TEMP POLE 2' NORTH
 OF EXIST.
- PT# N/A (TEMP)
 PL NEW 3/4" <18M> 3 EYE ANC 12'
 NW. PL NEW 3/4" <18M> 3 EYE
 ANC 12' SW. EXTENET TO ATTACH
 6.6M STRAND AND LASH FIBER @
 HOA 27' ". EXTENET TO ATTACH
 6.6M STRAND AND LASH FIBER @
 HOA 27' 2". PL 3/8" <10M>" DG TO
 NEW 3/4" <18M> 3 EYE ANC 12' NW.
 P=DE. PL 3/8" <10M>" DG TO NEW
 3/4" <18M> 3 EYE ANC 12' NW.
 P=DE. PL ISO-BOB. PL GUY
 GUARD. OFFSET NEW ANC. SET
 35' CLASS 5 TEMP POLE 2' NORTH
 OF EXIST.
- **(21) PT# N/A**

PL NEW 3/4" <18M> 3 EYE ANC 16' N. PL NEW 3/4" <18M> 3 EYE ANC 16' S. EXTENET TO ATTACH 6.6M STRAND AND LASH FIBER @ HOA 29' ". EXTENET TO ATTACH 6.6M STRAND AND LASH FIBER @ HOA 29' 2". PL 1/4" <6.6M>" DG TO NEW 3/4" <18M> 3 EYE ANC 16' N. P=DE PL 1/4" <6.6M>" DG TO NEW 3/4" <18M> 3 EYE ANC 16' S. P=DE. PL ISO-BOB. PL GUY GUARD.

PT# N/A EXTENET TO ATTACH 6.6M STRAND AND LASH FIBER @ HOA 28' 6" . PL 1/4" <6.6M>" DG TO BURIED ANC 16' E. P=42. PL


ISO-BOB. PL GUY GUARD.

PG0117-1
EXTENET TO ATTACH 6.6M
STRAND AND LASH FIBER @ HOA
22' " E-ARM TS. EXTENET TO PL EARM TO HOA 22' AND TRANSFER
TV. PL SEP BLOCK. AT HOA 22' "
LOWER CATV TO E-ARM BS 22' ".


PG4749-1 EXTENET TO ATTACH 6.6M STRAND AND LASH FIBER @ HOA 31' ". PL 1/4" <6.6M>" DG TO TREE 30' E. P=36. PL ISO-BOB. PL GUY


- PG4749-2
 EXTENET TO ATTACH 6.6M
 STRAND AND LASH FIBER @ HOA
 25' " . PL 1/4" <6.6M>" DG TO TREE
 24' W. P=42. PL ISO-BOB. PL GUY
 GUARD. RAISE GA TO HOA 25'4".
- PG4749-3
 EXTENET TO ATTACH 6.6M
 STRAND AND LASH FIBER @ HOA
 25' 6". PL 1/4" <6.6M>" DG TO
 TREE 30' E. P=43. PL ISO-BOB. PL
 GUY GUARD.
- PG4749-19
 EXTENET TO ATTACH 6.6M
 STRAND AND LASH FIBER @ HOA
 23' 9" . PL 1/4" <6.6M>" DG TO
 TREE 46' W. P=30. PL ISO-BOB. PL
 GUY GUARD.
- PT16941-2
 EXTENET TO ATTACH 6.6M
 STRAND AND LASH FIBER @ HOA
- PG030161-1
 EXTENET TO ATTACH 6.6M
 STRAND AND LASH FIBER @ HOA
 23' ". PL 1/4" <6.6M>" DG TO TREE
 13' E. P=40. PL ISO-BOB. PL GUY
 GUARD.

SEE SHT C-16 TO THE SHAPE OF T

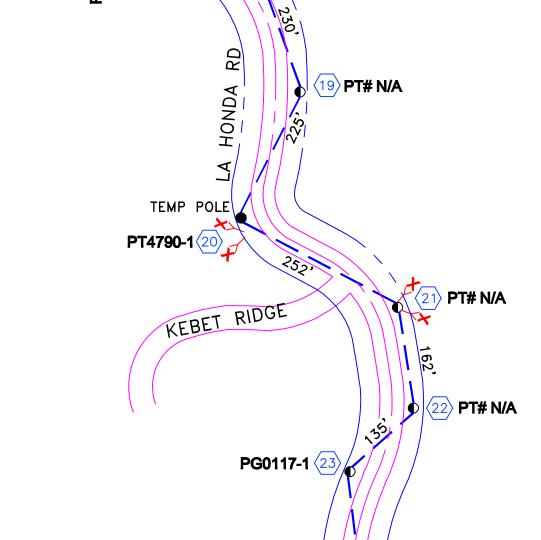

NODE #18

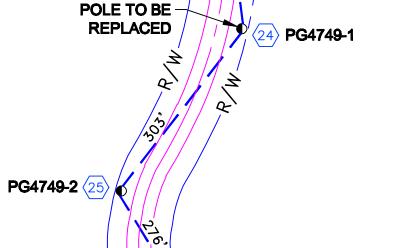

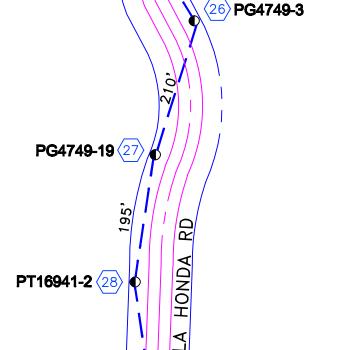

50° 5 29° PG

SEE SHT C-18

REDWOOD CITY TRAFFIC CONTROL PLANS CITY OF REDWOOD CITY

PLACEMENT DATA

PL 3248' OF AERIAL FIBER OPTIC CABLE

CONSTRUCTION NOTE:

- 1) USA UTILITY ALERT MUST
 BE CONTACTED MIN 48 HRS.
 PRIOR TO BEGINING CONSTRUCTION
- 2) ALL EX. UTILITIES BEING CROSSED
 MUST BE POTHOLED FOR DEPTH
 & LOCATION PRIOR TO CONSTRUCTION.


NOTES:

UNDERGROUND UTILITIES HAVE BEEN PLOTTED FROM AVAILABLE RECORDS AND FIELD OBSERVATIONS, BUT ARE NOT NECESSARILY EXACT. THEREFORE, UTILITY LOCATIONS WILL BE VERIFIED AT LEAST 100 FEET IN ADVANCE OF TRENCHING, DIRECTIONAL BORING OR PLOWING SO THAT CHANGES IN CONDUIT PLACEMENT CAN BE MADE IN THE EVENT OF CONFLICTS.

ALL KNOWN BURIED OBSTRUCTIONS ARE SHOWN ON THE CONSTRUCTION DRAWINGS.


ANY AND ALL OTHERS ENCOUNTERED ARE ALSO THE RESPONSIBILITY OF THE

CONTRACTOR TO LOCATE, PROTECT, AND REPAIR, IF DAMAGED.

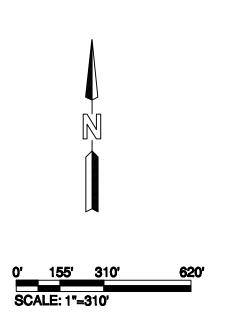

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REVISION	TOTAL FOOTAGE: 3248'	PROJECT NO. : HWY 8435	
1. TRAFFIC CONTROL PLANS 08/10/09	ENGINEERED DATE:	PROJECT NAME : SKYLINE BLVD	
2.	DRAWN BY: ICS	TG PAGE: 809-F6	
3.	DRAFT DATE: 08/10/09	JURISDICTION : COUNTY OF SAN MATEO	
4.			
5.			
6.	SKYLINE BLVD	SHEET TITLE	SHEET
7.	SAN MATEO, CA	DI ANI	
8.		PLAN	C-17

PT16941-4 **EXTENET TO ATTACH 6.6M** STRAND AND LASH FIBER @ HOA 24' "F-ARM TIS. PL ISO-BOB. PL **GUY GUARD. EXTENET TP PL** F-ARM TO HOA 24' AND TRANSFER TV AND TELCO. PL SEP BLOCK. AT HOA 24' 5" LOWER TEL TO F-ARM BOS 24' ". AT HOA 23' 5" RAISE TEL TO F-ARM BIS 24' ". AT HOA 25' 5"

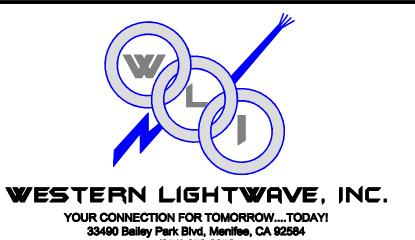PT16941-5 **EXTENET TO ATTACH 6.6M** STRAND AND LASH FIBER @ HOA 30' " F-ARM TIS. PL SEP BLOCK.

LOWER CATV TO F-ARM TOS 24' ".

PG020231-1 **EXTENET TO ATTACH 6.6M** STRAND AND LASH FIBER @ HOA 34' 6" . PL 1/4" <6.6M>" DG TO TREE 51' W. P=5. PL ISO-BOB. PI **GUY GUARD. EXTENET TO LOWER** TV AND TELCO. REFRAME TELCO DG TO SAME HOA. AT HOA 33' 6" LOWER TEL TO 32' 4". AT HOA 32' 4" LOWER TEL TO 31'4". AT HOA 34' 6" LOWER CATV TO 33' 6".

PG00984-2 **EXTENET TO ATTACH 6.6M** STRAND AND LASH FIBER @ HOA 36' ". PL 1/4" <6.6M>" DG TO TREE 36' E. P=5. PL ISO-BOB. PL GUY **GUARD. EXTENET TO LOWER TV** AND TELCO. TELCO NEEDS DG. TV **NEEDS DG.**

EXTENET TO ATTACH 6.6M STRAND AND LASH FIBER @ HOA 25' ". PL 1/4" <6.6M>" DG TO TREE 35' W. P=30. PL ISO-BOB. PL GUY GUARD.

EXTENET TO ATTACH 6.6M STRAND AND LASH FIBER @ HOA

PG981327-1 **EXTENET TO ATTACH 6.6M** STRAND AND LASH FIBER @ HOA

PG4749-6 **EXTENET TO ATTACH 6.6M** STRAND AND LASH FIBER @ HOA 29' ". PL 1/4" <6.6M>" DG TO TREE 72' E. P=20. PL ISO-BOB. PL GUY GUARD.

PG4749-7 PL NEW 3/4" <18M> 3 EYE ANC 24' W. EXTENET TO ATTACH 6.6M STRAND AND LASH FIBER @ HOA 26' 9" . PL 1/4" <6.6M>" DG TO NEW 3/4" <18M> 3 EYE ANC 24' W. P=15. PL ISO-BOB. PL GUY GUARD. OFFSET NEW ANC.

PG4749-8 **EXTENET TO ATTACH 6.6M** STRAND AND LASH FIBER @ HOA 22' 6". EXTENET TO ATTACH 6.6M STRAND AND LASH FIBER @ HOA 22' 4" . PL 1/4" <6.6M>" DG TO TREE 54' SW. P=DE. PL 1/4" <6.6M>" DG TO TREE 26' NW. P=DE. PL ISO-BOB. PL GUY GUARD.

PG4749-9 **EXTENET TO ATTACH 6.6M** STRAND AND LASH FIBER @ HOA 25' " . PL 1/4" <6.6M>" DG TO TREE 51' S. P=20. PL ISO-BOB. PL GUY GUARD.


PT25979-1 **EXTENET TO ATTACH 6.6M** STRAND AND LASH FIBER @ HOA

PT0123-2 **EXTENET TO ATTACH 6.6M** STRAND AND LASH FIBER @ HOA 25' ". EXTENET TO ATTACH 6.6M STRAND AND LASH FIBER @ HOA 24' 8" . PL 1/4" <6.6M>" DG TO 1" <26M> 3 EYE ANC 8' E. P=DE. PL 1/4" <6.6M>" DG TO TREE 102' N. P=DE. PL ISO-BOB. PL GUY

PT# N/A **EXTENET TO ATTACH 6.6M** STRAND AND LASH FIBER @ HOA 23' " F-ARM TIS. PL SEP BLOCK.

PT# N/A **EXTENET TO ATTACH 6.6M** STRAND AND LASH FIBER @ HOA 28' " . PL 1/4" <6.6M>" DG TO 1" <26M> 3 EYE ANC 12' W. P=15. PL ISO-BOB. PL GUY GUARD.

PT# N/A **EXTENET TO ATTACH 6.6M** STRAND AND LASH FIBER @ HOA 26' " . PL 1/4" <6.6M>" DG TO TREE 23' W. P=20. PL ISO-BOB. PL GUY

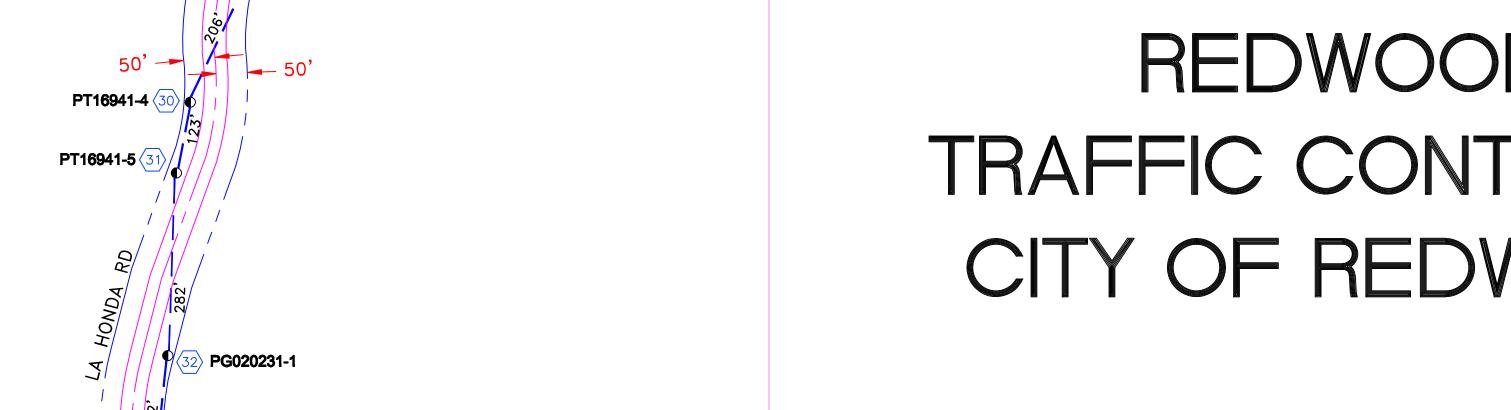

REDWOOD CITY TRAFFIC CONTROL PLANS CITY OF REDWOOD CITY

PLACEMENT DATA

PL 3213' OF AERIAL FIBER OPTIC CABLE


CONSTRUCTION NOTE:

1) USA UTILITY ALERT MUST BE CONTACTED MIN 48 HRS. PRIOR TO BEGINING CONSTRUCTION 2) ALL EX. UTILITIES BEING CROSSED

MUST BE POTHOLED FOR DEPTH & LOCATION PRIOR TO CONSTRUCTION.

UNDERGROUND UTILITIES HAVE BEEN PLOTTED FROM AVAILABLE RECORDS AND FIELD OBSERVATIONS, BUT ARE NOT NECESSARILY EXACT. THEREFORE, UTILITY LOCATIONS WILL BE VERIFIED AT LEAST 100 FEET IN ADVANCE OF TRENCHING, DIRECTIONAL BORING OR PLOWING SO THAT CHANGES IN CONDUIT PLACEMENT CAN BE MADE IN THE EVENT OF CONFLICTS.

ALL KNOWN BURIED OBSTRUCTIONS ARE SHOWN ON THE CONSTRUCTION DRAWINGS. ANY AND ALL OTHERS ENCOUNTERED ARE ALSO THE RESPONSIBILITY OF THE CONTRACTOR TO LOCATE, PROTECT, AND REPAIR, IF DAMAGED.

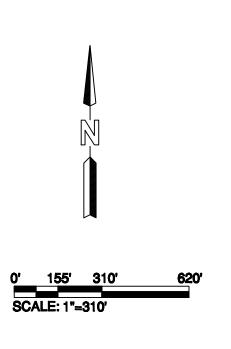





SEE SHT C-17

PG00984-2

PG981327-1 (36) P

PG4749-6

PG4749-7

LA HONDA RD

NODE #20

REPLACED S.

SEE SHT C-19

POLE TO BE

PT# N/A <44>

PT# N/A

NODE #19

PG00984-3 (3

PG981327-1

EXISTING POLE TO

BE USED WITH

ARRANGEMENT

REVISION	TOTAL FOOTAGE: 3213'	PROJECT NO. : HWY 8435	
1. TRAFFIC CONTROL PLANS 08/10/09	ENGINEERED DATE:	PROJECT NAME : SKYLINE BLVD	
2.	DRAWN BY: ICS	TG PAGE: 809-F7	
3.	DRAFT DATE: 08/10/09	JURISDICTION : COUNTY OF SAN MAT	EO
4.			
5.			
6.	SKYLINE BLVD	SHEET TITLE	SHEET
7.	SAN MATEO, CA	DIANI	
8.		PLAN	C-18

PG4749-10 EXTENET TO ATTACH 6.6M STRAND AND LASH FIBER @ HOA 26' " . PL 1/4" <6.6M>" DG TO TREE 13' W. P=44. RAISE DGA TO HOA

PG4749-11
EXTENET TO ATTACH 6.6M
STRAND AND LASH FIBER @ HOA

PT2275-2
EXTENET TO ATTACH 6.6M
STRAND AND LASH FIBER @ HOA
28' 5". EXTENET TO ATTACH 6.6M
STRAND AND LASH FIBER @ HOA
28' 7". PL 1/4" <6.6M>" DG TO
TREE 40' SE. P=DE. PL 1/4"
<6.6M>" DG TO TREE 20' N. P=DE.
PL ISO-BOB. PL GUY GUARD.

PT22275-1
EXTENET TO ATTACH 6.6M
STRAND AND LASH FIBER @ HOA
28' " . PL 1/4" <6.6M>" DG TO 3/4"
<18M> 3 EYE ANC 13' NW. P=45.
PL ISO-BOB. PL GUY GUARD.

PT25944-1
EXTENET TO ATTACH 6.6M
STRAND AND LASH FIBER @ HOA
27' " . PL 1/4" <6.6M>" DG TO 1.25"
<32M> 3 EYE ANC 23' SW. P=42.
PL ISO-BOB. PL GUY GUARD.

PG030017-1
PL NEW 3/4" <18M> 3 EYE ANC 10'
N. PL NEW 3/4" <18M> 3 EYE ANC
21' E. EXTENET TO ATTACH 6.6M
STRAND AND LASH FIBER @ HOA
29' 6". EXTENET TO ATTACH 6.6M
STRAND AND LASH FIBER @ HOA
29' 8". PL 1/4" <6.6M>" DG TO NEW
3/4" <18M> 3 EYE ANC 10' N. P=DE.
PL 1/4" <6.6M>" DG TO NEW 3/4"
<18M> 3 EYE ANC 21' E. P=DE. PL
ISO-BOB. PL GUY GUARD. OFFSET

PT6432-2
EXTENET TO ATTACH 6.6M
STRAND AND LASH FIBER @ HOA
30' 6" . PL 1/4" <6.6M>" DG TO 1.25"
<32M> 3 EYE ANC 12' E. P=36. PL
ISO-BOB. PL GUY GUARD.

NEW ANC.

PG080171-1
EXTENET TO ATTACH 6.6M
STRAND AND LASH FIBER @ HOA
28' 6". PL 1/4" <6.6M>" DG TO
TREE 40' E. P=39. PL ISO-BOB. PL
GUY GUARD.

PT24107-1
EXTENET TO ATTACH 6.6M
STRAND AND LASH FIBER @ HOA
32' "

PT# N/A
EXTENET TO ATTACH 6.6M
STRAND AND LASH FIBER @ HOA
28' " . PL 1/4" <6.6M>" DG TO TREE
18' W. P=42. PL ISO-BOB. PL GUY
GUARD.

DO NOT ATTACH. POLE ROTTON. SET 40' CLASS 4 TEMP POLE 2' SOUTH OF EXIST.

TEMP:
EXTENET TO ATTACH 6.6M
STRAND AND LASH FIBER @ HOA
30' ". PL 5/16" <6M>" DG TO TREE
66' W. P=30. PL ISO-BOB. PL GUY
GUARD. SET 40' CLASS 4 TEMP
POLE 2' SOUTH OF EXIST M.R.
POLE 56.

PT# N/A
EXTENET TO ATTACH 6.6M
STRAND AND LASH FIBER @ HOA
30' ". PL 1/4" <6.6M>" DG TO 1"
<26M> 3 EYE ANC 15' E. P=12. PL
ISO-BOB. PL GUY GUARD.

PT# N/A
EXTENET TO ATTACH 6.6M
STRAND AND LASH FIBER @ HOA
28' 9" . PL 1/4" <6.6M>" DG TO
TREE 15' E. P=33. PL ISO-BOB. PL
GUY GUARD.

SEE SHT C-3 PG4749-10 4 PG4749-11(47 PT22275-2 3 EYE ANC 10' N. PL NEW 3/4" <18M> 3 EYE ANC 21' E. **NODE #21** POLE TO BE-REPLACED PT6432-2 52 PT# N/A

REDWOOD CITY TRAFFIC CONTROL PLANS CITY OF REDWOOD CITY

PLACEMENT DATA

PL 3249' OF AERIAL FIBER OPTIC CABLE

CONSTRUCTION NOTE:

1) USA UTILITY ALERT MUST
BE CONTACTED MIN 48 HRS.
PRIOR TO BEGINING CONSTRUCTION
2) ALL EX. UTILITIES BEING CROSSED

MUST BE POTHOLED FOR DEPTH & LOCATION PRIOR TO CONSTRUCTION.


NOTES:

POLE TO BE -


REPLACED

UNDERGROUND UTILITIES HAVE BEEN PLOTTED FROM AVAILABLE RECORDS AND FIELD OBSERVATIONS, BUT ARE NOT NECESSARILY EXACT. THEREFORE, UTILITY LOCATIONS WILL BE VERIFIED AT LEAST 100 FEET IN ADVANCE OF TRENCHING, DIRECTIONAL BORING OR PLOWING SO THAT CHANGES IN CONDUIT PLACEMENT CAN BE MADE IN THE EVENT OF CONFLICTS.


ALL KNOWN BURIED OBSTRUCTIONS ARE SHOWN ON THE CONSTRUCTION DRAWINGS.
ANY AND ALL OTHERS ENCOUNTERED ARE ALSO THE RESPONSIBILITY OF THE
CONTRACTOR TO LOCATE, PROTECT, AND REPAIR, IF DAMAGED.

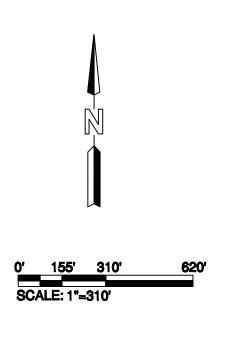



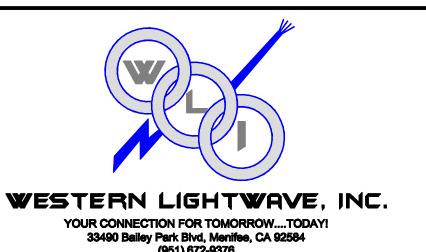

REVISION	TOTAL FOOTAGE: 3249'	PROJECT NO.: HWY 8435	
1. TRAFFIC CONTROL PLANS 08/10/09	ENGINEERED DATE:	PROJECT NAME : SKYLINE BLVD	
2.	DRAWN BY: ICS	TG PAGE: 829-F1	
3.	DRAFT DATE: 08/10/09	JURISDICTION : COUNTY OF SAN MAT	EO
4.			
5.			
6.	SKYLINE BLVD	SHEET TITLE	SHEET
7.	SAN MATEO, CA	DI ANI	
8.		PLAN	C-19

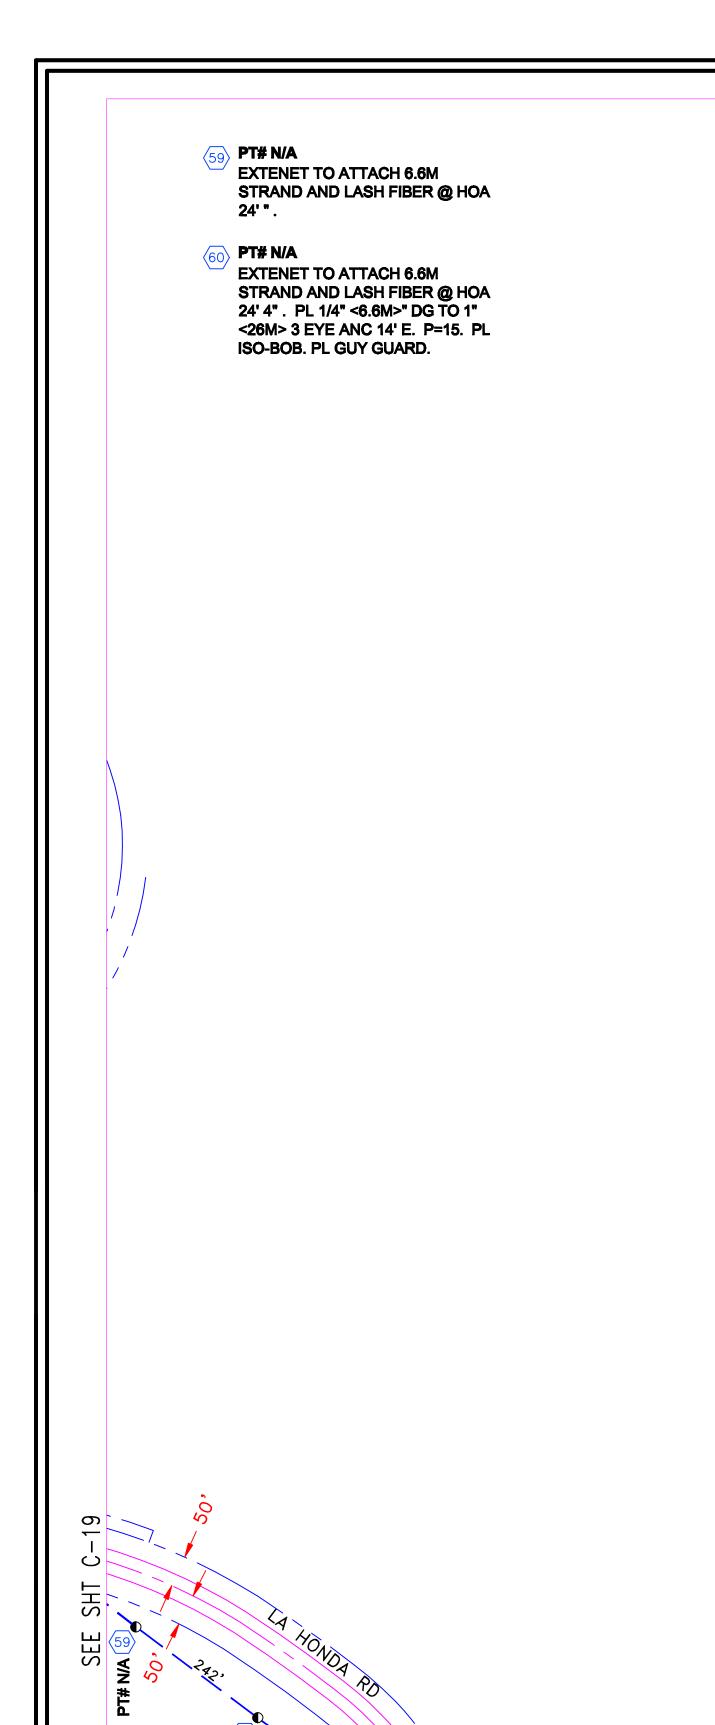

SEE SHT C-21

REDWOOD CITY TRAFFIC CONTROL PLANS CITY OF REDWOOD CITY

PLACEMENT DATA

PL 438' OF AERIAL FIBER OPTIC CABLE


CONSTRUCTION NOTE:

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 PRIOR TO BEGINING CONSTRUCTION
- 2) ALL EX. UTILITIES BEING CROSSED MUST BE POTHOLED FOR DEPTH & LOCATION PRIOR TO CONSTRUCTION.

NOTES:

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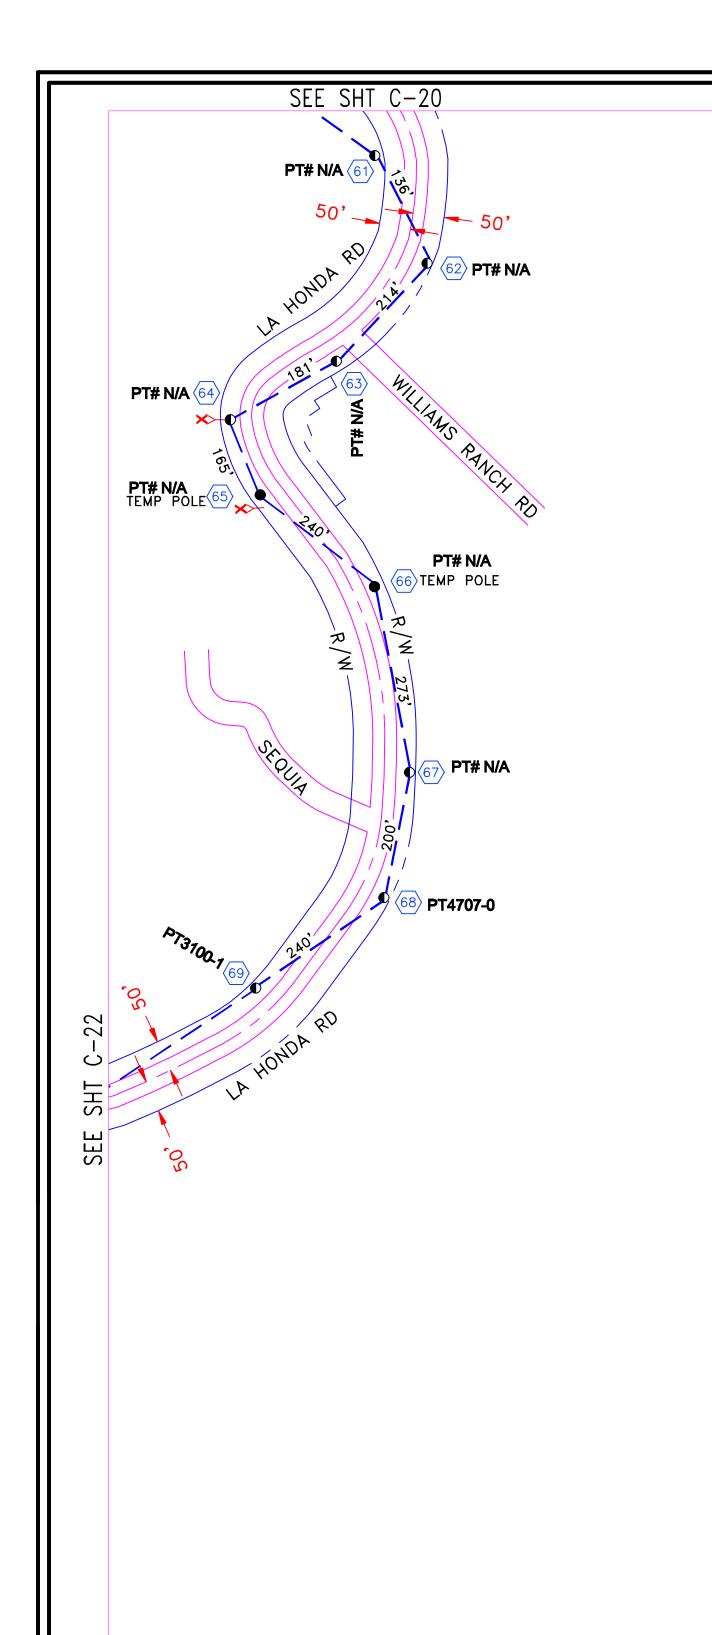
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exte	YOUR NETWORK EVERYWHERE
	SYSTEMS

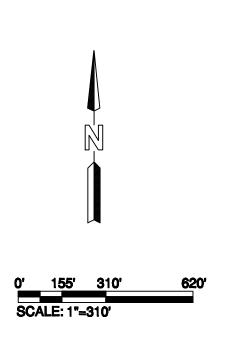

REVISION	TOTAL FOOTAGE: 438'	PROJECT NO. : HWY 8435	
1. TRAFFIC CONTROL PLANS 08/10/09	ENGINEERED DATE:	PROJECT NAME : SKYLINE BLVD	
2.	DRAWN BY: ICS	TG PAGE: 829-G1	
3.	DRAFT DATE: 08/10/09	JURISDICTION : COUNTY OF SAN MAT	EO
4.			
5.			
6.	SKYLINE BLVD	SHEET TITLE	SHEET
7.	SAN MATEO, CA	DLAN	C 20
8.	3, 11, 11, 11, 11, 11, 11, 11, 11, 11, 1	PLAN	C-20



PT# N/A
EXTENET TO ATTACH 6.6M
STRAND AND LASH FIBER @ HOA
21' 6" EXT ARM TMS. PL SEP

POLE TRNSFR.

BLOCK.

PT# N/A
EXTENET TO ATTACH 6.6M
STRAND AND LASH FIBER @ HOA
26' 2" . EXTENET TO ATTACH 6.6M
STRAND AND LASH FIBER @ HOA
26' " . PL 1/4" <6.6M>" DG TO
BURIED ANC 11' SE. P=DE. PL 1/4"
<6.6M>" DG TO 1" <26M> 3 EYE
ANC 27' NE. P=DE. PL ISO-BOB. PL
GUY GUARD. TELCO TO COMP

PT# N/A

EXTENET TO ATTACH 6.6M

STRAND AND LASH FIBER @ HOA

27' 2" . EXTENET TO ATTACH 6.6M

STRAND AND LASH FIBER @ HOA

27' 4" . PL 1/4" <6.6M>" DG TO 3/4"

<18M> 3 EYE ANC 18' E. P=DE. PL

1/4" <6.6M>" DG TO BURIED ANC 13'

S. P=DE. PL ISO-BOB. PL GUY

GUARD. TELCO TO COMP POLE

TRNSFR.

PT# N/A
PL NEW 3/4" <18M> 3 EYE ANC 12'
N. EXTENET TO ATTACH 6.6M
STRAND AND LASH FIBER @ HOA
30' " . PL 1/4" <6.6M>" DG TO NEW
3/4" <18M> 3 EYE ANC 12' N. P=25.
PL ISO-BOB. PL GUY GUARD.

65 PT# N/A
DO NOT ATTACH. NO SPACE.
ATTACH TO TV TEMP POLE 4' SW.
TV ON TEMP POLE 4' SW.
TEMP:

TEMP:
PL NEW 3/4" <18M> 3 EYE ANC 18'
NW. EXTENET TO ATTACH 6.6M
STRAND AND LASH FIBER @ HOA
25' ". PL 1/4" <6.6M>" DG TO NEW
3/4" <18M> 3 EYE ANC 18' NW.
P=10. PL ISO-BOB. PL GUY GUARD.
OFFSET NEW ANC.

66 PT# N/A
DO NOT ATTACH. NO SPACE. SET
40' CLASS 4 TEMP POLE 2' NORTH
OF EXIST.

TEMP: EXTENET TO ATTACH 6.6M STRAND AND LASH FIBER @ HOA 32' " . SET 40' CLASS 4 TEMP POLE 2' NORTH OF EXIST M.R. POLE 66.

67 PT# N/A
EXTENET TO ATTACH 6.6M
STRAND AND LASH FIBER @ HOA
23' 2" EXT ARM TMS. REPLACE
EXIST TELCO DG WITH 10M DG. PL
SEP BLOCK.

EXTENET TO ATTACH 6.6M
STRAND AND LASH FIBER @ HOA
29' ". PL 1/4" <6.6M>" DG TO 3/4"
<18M> 3 EYE ANC 14' E. P=25. PL
ISO-BOB. PL GUY GUARD.

PT3100-1
EXTENET TO ATTACH 6.6M
STRAND AND LASH FIBER @ HOA
23' 7". PL ISO-BOB. PL GUY
GUARD.

REDWOOD CITY TRAFFIC CONTROL PLANS CITY OF REDWOOD CITY

PLACEMENT DATA

PL 1649' OF AERIAL FIBER OPTIC CABLE

CONSTRUCTION NOTE:


1) USA UTILITY ALERT MUST
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PRIOR TO BEGINING CONSTRUCTION

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NOTES

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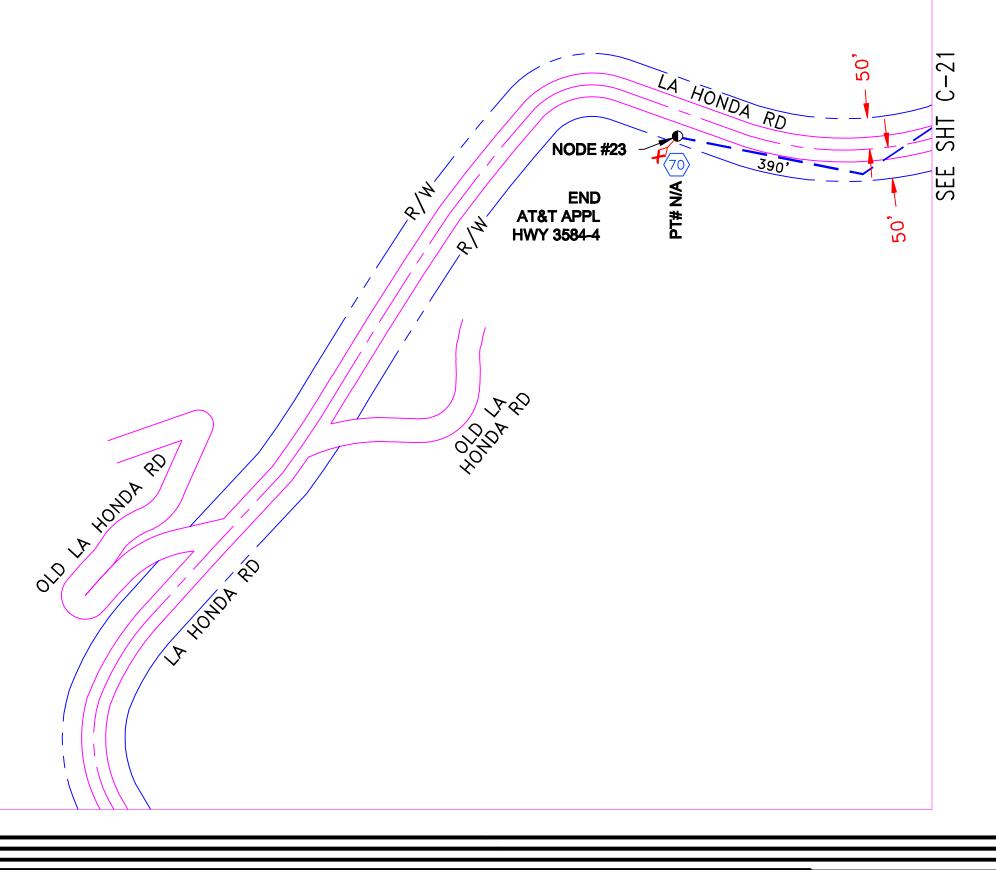
REVISION	TOTAL FOOTAGE: 1649'	PROJECT NO. : HWY 8435	
1. TRAFFIC CONTROL PLANS 08/10/09	ENGINEERED DATE:	PROJECT NAME : SKYLINE BLVD	
2.	DRAWN BY: ICS	TG PAGE: 829-G2	
3.	DRAFT DATE: 08/10/09	JURISDICTION : COUNTY OF SAN	MATEO
4.			
5.			
6.	SKYLINE BLVD	SHEET TITLE	SHEET
7.	SAN MATEO, CA	DI ANI	
8.		PLAN	C-21

PT# N/A
PL NEW 3/4" <18M> 3 EYE ANC 16'
SW. EXTENET TO ATTACH 6.6M
STRAND AND LASH FIBER @ HOA
29' 4". PL 1/4" <6.6M>" DG TO NEW
3/4" <18M> 3 EYE ANC 16' SW.
P=DE. PL ISO-BOB. PL GUY
GUARD. OFFSET NEW ANC. RAISE
DGA TO HOA 29'8". TV NEEDS DG.

REDWOOD CITY TRAFFIC CONTROL PLANS CITY OF REDWOOD CITY

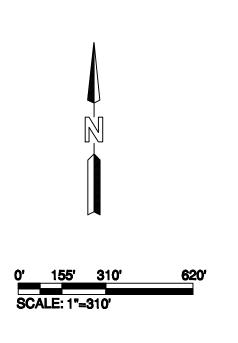PLACEMENT DATA

PL 390' OF AERIAL FIBER OPTIC CABLE




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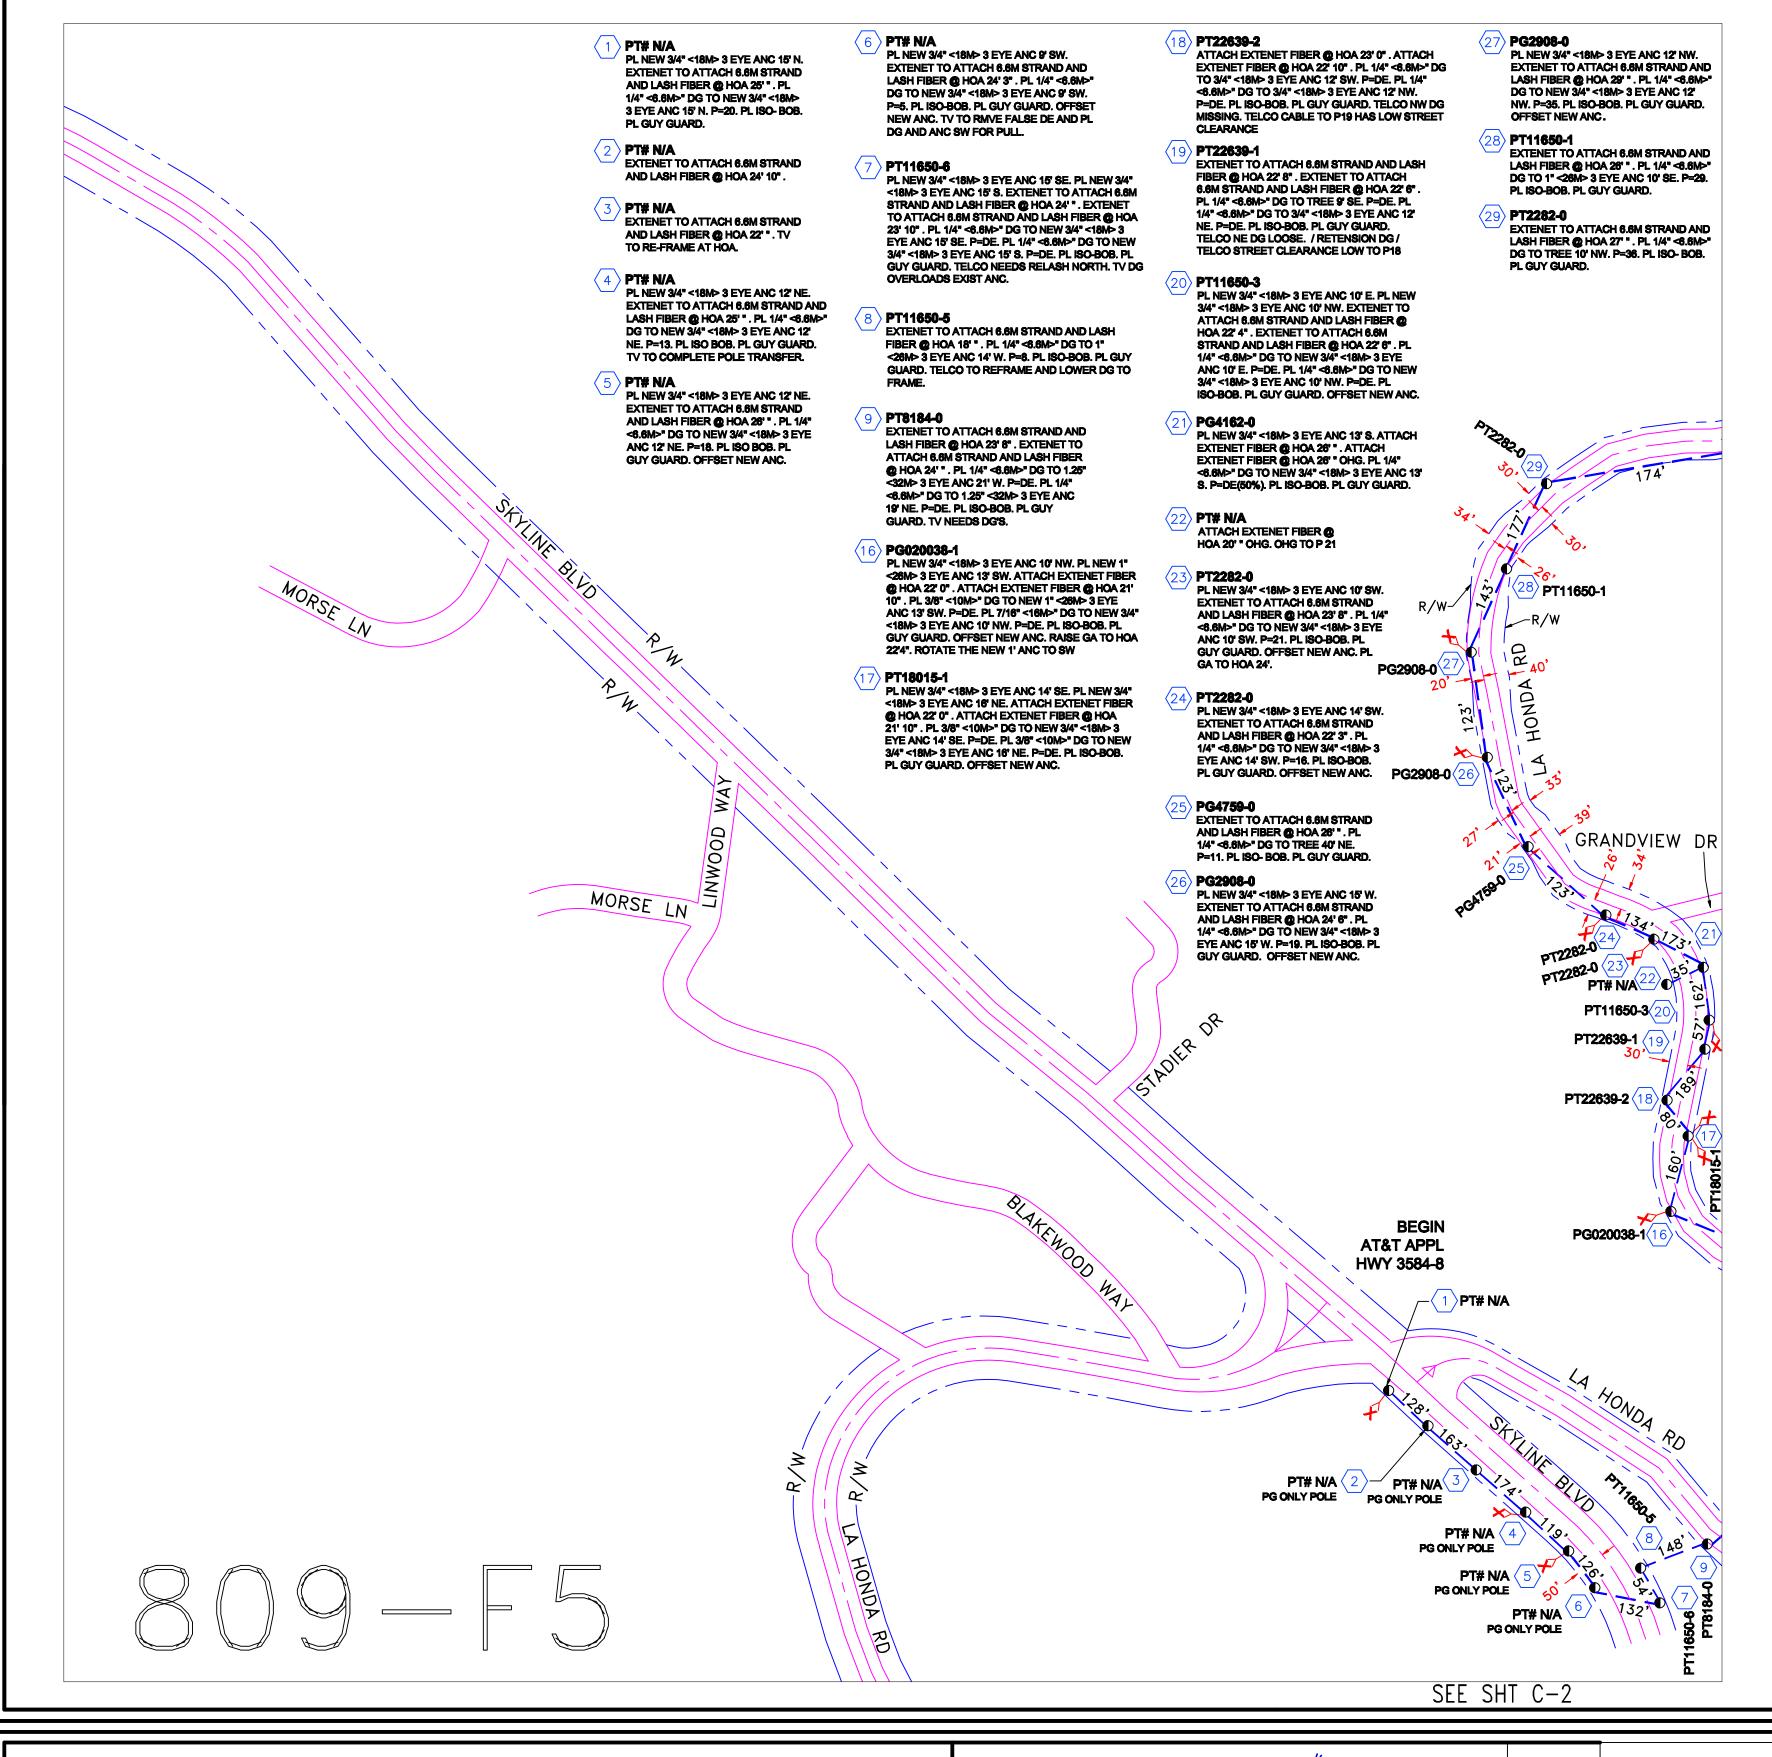
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extene	YOUR NETWORK FVFRYWHFRF
SYSTEMS	



REVISION	TOTAL FOOTAGE: 390'	PROJECT NO. : HWY 8435	
1. TRAFFIC CONTROL PLANS 08/10/09	ENGINEERED DATE:	PROJECT NAME : SKYLINE BLVD	
2.	DRAWN BY: ICS	TG PAGE: 829-F2	
3.	DRAFT DATE: 08/10/09	JURISDICTION : COUNTY OF SAN	MATEO
4.			
5.			
6.	SKYLINE BLVD	SHEET TITLE	SHEET
7.	SAN MATEO, CA	DI ANI	
8.	5. 4. t till (1 = 5, 5) (PLAN	C-22



PLACEMENT DATA

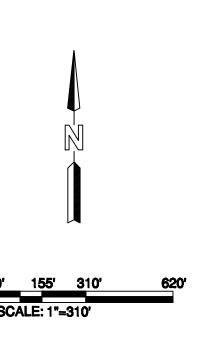PL 1144' OF AERIAL FIBER OPTIC CABLE


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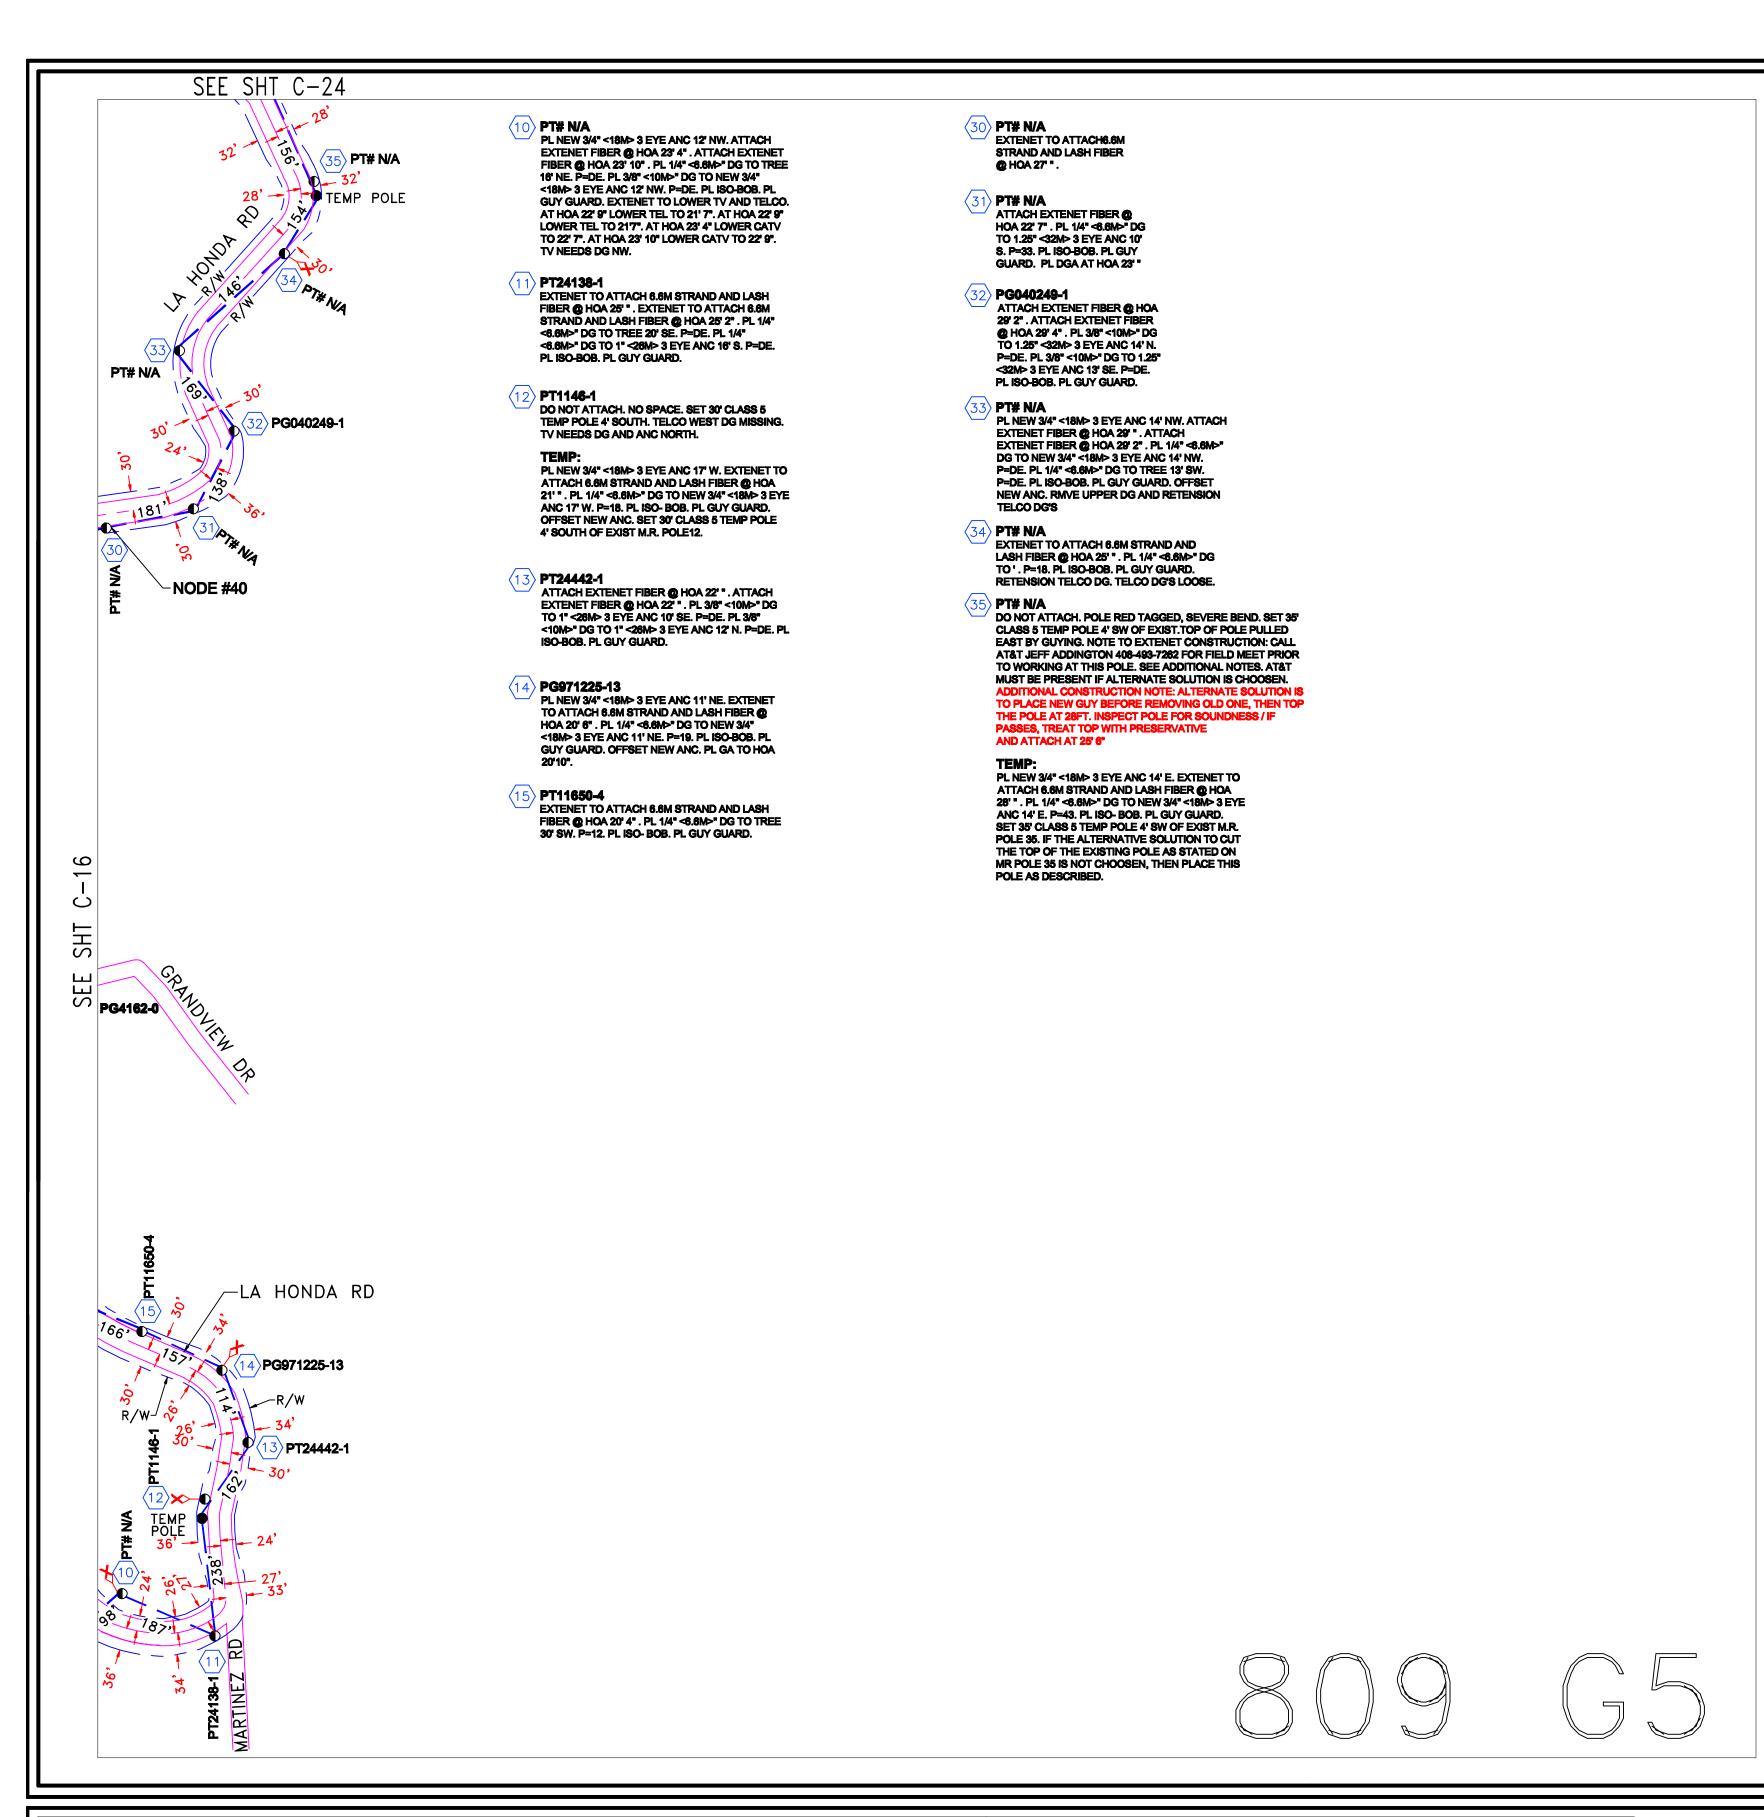






33490 Bailey Park Blvd, Menifee, CA 92584

REVISION	TOTAL FOOTAGE: 1144'	PROJECT NO. : HWY 8435	
1. TRAFFIC CONTROL PLANS 08/10/09	ENGINEERED DATE:	PROJECT NAME : SKYLINE BLVD	
2.	DRAWN BY: ICS	TG PAGE: 809-F5	
3.	DRAFT DATE: 08/10/09	JURISDICTION : COUNTY OF SAN MATI	EO
4.			
5.			
6.	SKYLINE BLVD	SHEET TITLE	SHEET
7.	SAN MATEO, CA	DLANI	C 16
8.		PLAN	C-16

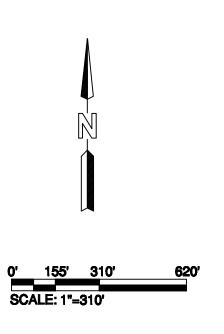

PLACEMENT DATA

PL 2066' OF AERIAL FIBER OPTIC CABLE

CONSTRUCTION NOTE:

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 BE CONTACTED MIN 48 HRS.
 PRIOR TO BEGINING CONSTRUCTION
- 2) ALL EX. UTILITIES BEING CROSSED MUST BE POTHOLED FOR DEPTH & LOCATION PRIOR TO CONSTRUCTION.


NOTES:

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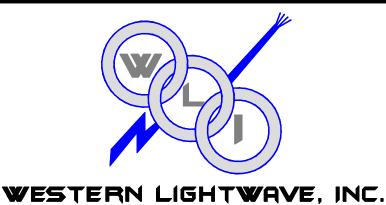
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CONTRACTOR TO LOCATE, PROTECT, AND REPAIR, IF DAMAGED.





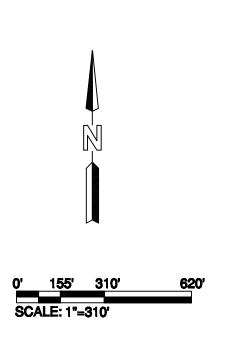

YOUR CONNECTION FOR TOMORROW....TODAY! 33490 Bailey Park Bivd, Menifee, CA 92584

REVISION	TOTAL FOOTAGE: 2066'	PROJECT NO.: HWY 8435	
1. TRAFFIC CONTROL PLANS 08/10/09	ENGINEERED DATE:	PROJECT NAME : SKYLINE BLVD	
2.	DRAWN BY: ICS	TG PAGE: 809-G5	
3.	DRAFT DATE: 08/10/09	JURISDICTION : COUNTY OF SAN MATI	≣ O
4.			
5.			
6.	SKYLINE BLVD	SHEET TITLE	SHEET
7.	SAN MATEO, CA	DLAN	
8.	<i>5,</i> 1, 1, 1, 2, 5, 6, 7, 1	PLAN	C-23




HWY 35 - PROJECT

HWY8435 - 001A

POST MILE MARKER 16.95

14040 SKYLINE BLVD (SOUTHEAST OF)

WOODSIDE, CA 94062

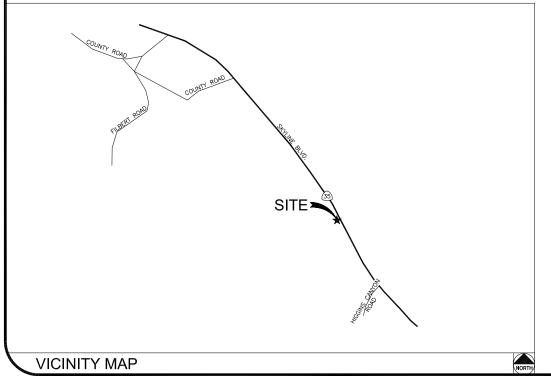

CLIENT

EXTENET SYSTEMS, INC. 3030 WARRENVILLE RD. SUITE 340 LISLE, IL 60532 CONTACT JEFF FRYE PHONE 480-626-1271 FAX 504-285-1603

POLE OWNER

EXTENET SYSTEMS, INC. 3030 WARRENVILLE RD. SUITE 340 LISLE, II. 60532 CONTACT JEFF FRYE PHONE 480-626-1271 FAX 504-285-1603

ENGINEERING FIRM/SURVEYING

MAXIMIZE COMMUNICATION GROUP, INC. 1351 POMONA ROAD SUITE 100 CORONA, CA 92882 CONTACT KELLI MCCABE PHONE 909-786-2170 FAX 909-992-3113

COORDINATES

LAT: 37.43164 LONG: -122.31490

CODE COMPLIANCE:

ALL WORK AND MATERIALS SHALL BE PERFORMED & INSTALLED IN ACCORDANCE WITH THE CURRENT EDITIONS OF THE FOLLOWING CODES AS ADOPTED BY LOCAL GOVERNING AUTHORITIES AND LOCAL/CITY/COUNTY ORDINANCES:

 CALIFORNIA ADMINISTRATIVE CODE (INCLUDING TITLE 24 & 25).

- 2. 2007 CALIFORNIA BUILDING CODE
- 2007 CALIFORNIA ELECTRICAL CODE.
- 3. BUILDING OFFICIALS AND CODE ADMINISTRATORS (BOCA)
- 4. UNIFORM PLUMBING & MECHANICAL CODES.
- 5. ANSI/EIA-222-F LIFE SAFETY CODE.
- 6. CALIFORNIA GENERAL ORDER 95, 128 & 165.

DESCRIPTION TITLE SHEET GENERAL CONSTRUCTION NOTE & ANTENNA CABLE SCHEDULE		
CENERAL CONSTRUCTION NOTE & ANTENNA CARLE SCHEDULE		
SENERAL CONSTRONGE WATERWAY OF DEL SOFTE SOFTE		
SITE PLAN		
PLAN AND PROFILE		
UTILITY POLE ELEVATIONS/RISER DETAILS		
ERIAL DETAILS		
UNDERGROUND DETAILS		



3030 WARRENVILLE RD. SUITE 340 LISLE, IL 60532 www.extenet.com

-480		No.
REV.	DATE	DESCRIPTION
3	04/26/10	REVISION PER CALTRANS COMMENTS
2	02/08/10	REVISION PER CALTRANS COMMENTS
	11/11/09	REVISION PER EXTENET REQUESTED RAD CENTER CHANGE

CURRENT ISSUE DATE:

04/26/10

PLANS PREPARED BY:



1351 POMONA ROAD SUITE 100 CORONA, CA 92882 OFFICE: (909) 786-2170 FAX: (909) 992-3113

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7 SIIL NO.:

HWY8435-001A

SITE NAME & ADDRESS:


HIGHWAY 84/35 NETWORK NODE

14040 SKYLINE BLVD (SOUTHEAST OF) WOODSIDE, CA 94062

SHEET 111

TITLE SHEET

DRAWN BY: CHECKED BY: APPROVED BY:
VG AF KM
SHEET NUMBER: T13

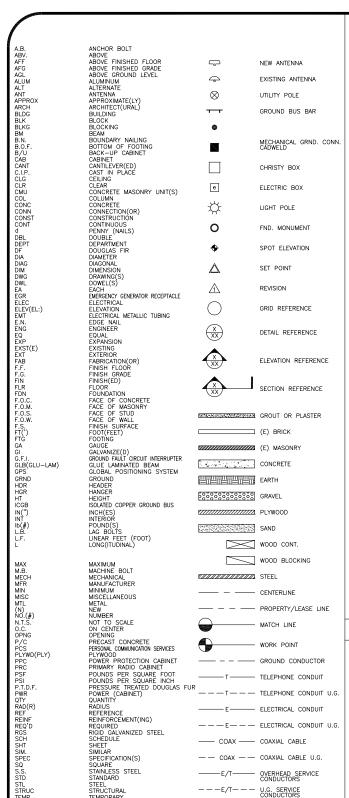

1. THE CONTRACTOR SHALL BE RESPONSIBLE FOR SURVEY MONUMENTS AND/OR VERTICAL CONTROL BENCHMARKS WHICH ARE DISTURBED OR DESTROYED BY CONSTRUCTION. A LAND SURVEYOR MUST FIELD LOCATE, REFERENCE, AND/OR PRESERVE ALL HISTORICAL OR CONTROLLING MONUMENTS PRIOR TO ANY EARTHMORK. IF DESTROYED, SUCH MONUMENTS SHALL BE REPLACED WITH APPROPRIATE MONUMENTS BY A LAND SURVEYOR. A CORNER RECORD OR RECORD OF SURVEY, AS APPROPRIATE, SHALL BE FILED AS REQUIRED BY THE PROPRESSIONAL LAND SURVEYOR.

NUMBER BE ISSUED BEFORE A "PERMT TO EXCAVATE" WILL BE VALID. FOR YOUR DIG ALERT I.D. NUMBER, CALL UNDERGROUND SERVICE ALERT, TOLL FREE 1-800-422-4133, TWO DAYS BEFORE YOU DIG.

CROSS THE PROPOSED TRENCH LINE AND MUST MAINTAIN A 1' MINIMUM VERTICAL CLEARANCE.

4. IF ANY EXISTING HARDSCAPE OR LANDSCAPE INDICATED ON THE APPROVE PLANS IS DAMAGED OR REMOVED DURING DEMOLITION OR CONSTRUCTION, IT SHALL BE REPAIRED AND/OR REPLACED IN KIND PER THE APPROVED

5. CONTRACTOR SHALL REPLACE OR REPAIR ALL TRAFFIC SIGNAL LOOPS, CONDUIT, AND LANE STRIPING DAMAGED DURING CONSTRUCTION.

6. THIS PROJECT WILL BE INSPECTED BY ENGINEERING AND FIELD ENGINEERING DIVISION

7. MANHOLES OR COVERS SHALL BE LABELED EXTENET

8. CONTRACTOR SHALL IMPLEMENT AN EROSION CONTROL PROGRAM DURING THE PROJECT CONSTRUCTION ACTIVITIES. THE PROGRAM SHALL MEET THE APPLICABLE REQUIREMENTS OF THE STATE WATER RESOURCE CONTROL

9. THE CONTRACTOR SHALL HAVE EMERGENCY MATERIALS AND EQUIPMENT ON HAND FOR UNFORESEEN SITUATIONS, SUCH AS DAMAGE TO UNDERGROUND WATER, SEWER, AND STORM DRAIN FACILITIES WHEREBY FLOWS MAY GENERATE EROSION AND SEDIMENT POLLUTION.

USA North

1. INDEMNIFICATION CLAUSE: THE CONTRACTOR AGREES AND SHALL:
ASSUME SOLE AND COMPLETE RESPONSIBILITY OF THE JOB SITE CONDITIONS DURING THE COURSE OF
CONSTRUCTION OF THIS PROJECT, INCLUDING THE SAFETY OF ALL PERSONS AND PROPERTIES. THAT THESE
REQUIREMENTS SHALL APPLY CONTINUOUSLY AND NOT BE LIMITED TO NORMAL WORKING HOURS AND CONDITIONS. ENGINEERS HARMLESS FROM ANY AND ALL LIABILITY, REAL OR ALLEGED IN CONNECTION WITH THE PERFORMANCE

2. PRIOR TO THE BEGINNING OF ANY CONSTRUCTION AND THROUGHOUT THE COURSE OF CONSTRUCTION WORK. THE CONTRACTOR SHALL FULLY COMPLY WITH "CALIFORNIA OCCUPATIONAL SAFETY AND HEALTH" ACT OF 1973 INCLUDING ALL REVISIONS AND AMENDMENTS THERETO.

3. ALL WORK SHALL CONFORM TO THE LATEST EDITIONS OF G095,128 AND THE STANDARD "SPECIFICATIONS FOR PUBLIC WORKS CONSTRUCTION" AS ADOPTED BY THE CITY, COUNTY OR STATE AS MODIFIED BY STANDARD PLANS

4. THE EXISTENCE AND LOCATION OF UTILITIES AND OTHER AGENCY'S FACILITIES AS SHOWN HERON ARE OBTAINED BY A SEARCH OF AVAILABLE RECORDS. OTHER FACILITIES MAY SOSTS. THE CONTRACTOR SHALL VERIFY PRINCE TO THE START OF CONSTRUCTION AND SHALL USE EXTREME CAREE AND PROTECTIVE MEASURES TO PREVENT DAMAGE TO THESE FACILITIES. THE CONTRACTOR IS RESPONSIBLE FOR THE PROTECTION OF ALL UTILITY OR AGENCY FACILITIES WITHIN THE LIMITS OF WORK, WHETHER THEY ARE SHOWN ON THIS PLAN OR NOT.

5. THE CONTRACTOR SHALL NOTIFY THE CITY, COUNTY OR STATE ENGINEER INSPECTION DEPARTMENT, AT LEAST TWO DAYS BEFORE START OF ANY WORK REQUIRING THEIR INVOLVEMENT.

6. THE CITY, COUNTY OR STATE SHALL SPECIFY THE EXPIRATION PERIOD OF THE PERMIT FOR THIS CONSTRUCTION PROJECT.

7. The minimum cover for all conduits placed underground shall be 36 inches to the finished grade at all times.

8. THE CONTRACTOR SHALL TUNNEL ALL CURB AND GUTTERS AND BORE ALL CONCRETE DRIVEWAYS AND WALKWAYS AT THE DIRECTION OF THE CITY, COUNTY OR STATE ENGINEER.

ALL A.C AND/OR CONCRETE PAVEMENT SHALL BE REPLACED AT THE DIRECTION OF THE CITY, COUNTY OR STATE ENGINEERS.

WORK, SHALL BE REPLANTED AND/OR REPLACED SO AS TO RESTORE THE WORK SITE TO ITS ORIGINAL CONDITION

11. THE CONTRACTOR WILL BE RESPONSIBLE FOR THE PROCESSING OF ALL APPLICANT PERMIT FORMS ALONG WITH THE REQUIRED LIABILITY INSURANCE FORMS. CLEARLY DEMONSTRATING THAT EXTENET, THE CITY, COUNTY OR STATE IS ALSO INSURED WITH THE REQUIRED LIABILITY INSURANCE IN THE AMOUNT OF \$1,000,000.00 FOR THIS

12. VAULTS, PEDESTALS, CONDUITS AND OTHER TYPES OF SUBSTRUCTURE ARE EITHER SPECIFIED ON THIS PLAN OR WILL BE SPECIFIED BY THE CONSTRUCTION ENGINEER. ANY AND ALL DEVIATIONS FROM THE SPECIFIED TYPES OF MATERIAL MUST BE APPROVED BY THE SYSTEM ENGINEER, IN WRITING BEFORE INSTALLATION THEREOF.

13. THE CONTRACTOR SHALL VERIFY THE LOCATION OF ALL EXISTING UTILITIES IN INCLUDING SEWER LATERALS & WATER SERVICES TO INDIVIDUAL LOTS BOTH VERTICAL AND HORIZONTAL PRIOR TO COMMENCING IMPROVEMENT

14. CONTRACTOR SHALL MAKE EXPLORATION EXCAVATIONS AND LOCATE EXISTING FACILITIES SUFFICIENTLY AHEAD OF CONSTRUCTION TO PERMIT REVISIONS TO PLANS IF REVISION IS NECESSARY BECAUSE OF LOCATION OF

15. THE LOCATIONS OF ALL EXISTING UTILITIES SHOWN ON THESE PLANS ARE FROM EXISTING RECORDS AND CORROBORATED, WHERE POSSIBLE, WITH FIELD TIES. THE CONTRACTOR IS RESPONSIBLE FOR CONFIRMINT LOCATIONS SHOWN, BOTH HORIZONIAL AND VERTICALLY. PRIOR TO CONSTRUCTION, IF EXISTING LOCATIONS WAR SUBSTANTIALLY FROM THE PLANS. THE ENGINEER SHOULD BE NOTIFIED TO MAKE ANY CONSTRUCTION CHANGES

EROSION AND SEDIMENT CONTROL NOTES

TEMPORARY EROSION/SEDIMENT CONTROL PRIOR TO COMPLETION OF FINAL IMPROVEMENTS, SHALL BE PERFORMED BY THE CONTRACTOR OR QUALIFIED PERSON AS INDICATED BELOW:

1. ALL REQUIREMENTS OF THE CITY, COUNTY AND STATE "STORM WATER STANDARDS" MUST BE INCORPORATED INTO THE DESIGN AND CONSTRUCTION OF THE PROPOSED GRADING/IMPROVMENTS CONSISTENT WITH THE APPROVED STORM WATER POLLUTION PREVENTION PLAN (SWPPP), WATER QUALITY TECHNICAL REPORT (WQTR), AND/OR WATER POLLUTION CONTROL PLAN (WPCP).

2. FOR STORM DRAIN INLETS, PROVIDE A GRAVEL BAG SILT BASIN IMMEDIATELY UPSTREAM OF INLET AS INDICATED ON DETAILS.

3. FOR INLETS LOCATED AT SUMPS ADJACENT TO TOP OF SLOPES. THE CONTRACTOR SHALL ENSURE THAT WATER PORNING TO THE SUMP IS DIRECTED INTO THE INLET AND THAT A MINIMUM OF 1.00' FREEBOARD EXISTS AND IS MAINTAINED ABOVE THE TOP OF THE INLET. IF FREEBOARD IS NOT PROVIDED BY GRADIOS SHOWN ON THESE PLANS THE CONTRACTOR SHALL PROVIDE IT VIA TEMPORARY MEASURES, I.E. GRAVEL BAGS OR DIKES.

4. THE CONTRACTOR OR QUALIFIED PERSON SHALL BE RESPONSIBLE FOR CLEANUP OF SILT AND MUD ON ADJACENT STREET(S) AND STORM DRAIN SYSTEM DUE TO CONSTRUCTION ACTIVITY.

5. THE CONTRACTOR OR QUALIFIED PERSON SHALL CHECK AND MAINTAIN ALL LINED AND UNLINED DITCHES AFTER EACH RAINFALL.

6. THE CONTRACTOR SHALL REMOVE SILT AND DEBRIS AFTER EACH MAJOR RAINFALL

B. THE CONTRACTOR SHALL RESTORE ALL EROSION/SEDIMENT CONTROL DEVICES TO WORKING ORDER TO THE SATISFACTION OF THE CITY ENGINEER OF RESIDENT ENGINEER AFTER EACH RUN-OFF PRODUCING RAINFALL.

9. THE CONTRACTOR SHALL INSTALL ADDITIONAL EROSION/SEDIMENT CONTROL MEASURES AS MAY BE REQUIRED BY THE RESIDENT ENGINEER DUE TO UNCOMPLETED GRADING OPERATIONS OR UNFORESEEN CIRCUMSTANCES,

10. THE CONTRACTOR SHALL BE RESPONSIBLE AND SHALL TAKE NECESSARY PRECAUTIONS TO PREVENT PUBLIC TRESPASS ONTO AREAS WHERE IMPOUNDED WATERS CREATE A HAZARDOUS CONDITION.

11. ALL EROSION/SEDIMENT CONTROL MEASURES PROVIDED PER THE APPROVED GRADING PLAN SHALL BE INCORPORATED HERON, ALL EROSION/SEDIMENT CONTROL FOR INTERIM CONDITIONS SHALL BE DONE TO THE SATISFACTION OF THE RESIDENT ENGINEER.

12. GRADED AREAS AROUND THE PROJECT PERIMETER MUST DRAIN AWAY FROM THE FACE OF THE SLOPE AT THE CONCLUSION OF EACH WORKING DAY.

13. ALL REMOVABLE PROTECTIVE DEVICES SHOWN SHALL BE IN PLACE AT THE END OF EACH WORKING DAY WHEN RAIN IS IMMINENT.

14. THE CONTRACTOR SHALL ONLY GRADE, INCLUDING CLEARING AND GRUBBING FOR THE AREAS FOR WHICH THE CONTRACTOR OR QUALIFIED PERSON CAN PROVIDE EROSION/SEDIMENT CONTROL MEASURES.

15. THE CONTRACTOR SHALL ARRANGE FOR WEEKLY MEETINGS DURING OCTOBER 1ST TO APRIL 30TH FOR PROJECT TEAM (GENERAL CONTRACTOR, QUALIFIED PERSON, EROSION CONTROL SUBCONTRACTOR IF AN, ENGINEER OF WORK, OWNER/DEVELOPER AND THE RESIDENT ENGINEER) TO EVALUATE THE ADEQUACY OF THE EROSION/SEDIMENT CONTROL MEASURE AND OTHER RELATED CONSTRUCTION ACTIVITIES.

ANTENNA & CABLE SCHEDULE

MAKE / MODEL

840 21410

KATHREIN

3030 WARRENVILLE RD. SUITE 340 LISLE, IL 60532 www.extenet.com

	REV.	DATE	DESCRIPTION
	3	04/26/10	REVISION PER CALTRANS COMMENTS
	2	02/08/10	REVISION PER CALTRANS COMMENTS
1		11/11/09	REVISION PER EXTENET REQUESTED RAD CENTER CHANGE

CURRENT ISSUE DATE

26,



1351 POMONA ROAD SUITE 100 CORONA, CA 92882 OFFICE: (909) 786-2170 FAX: (909) 992-3113

2

CABLE SIZE

1/2"

1/2"

2

2

24'-7'

HWY8435-001A

SITE NAME & ADDRESS:

HIGHWAY 84/35 NETWORK NODE I

14040 SKYLINE BLVD (SOUTHEAST OF) WOODSIDE, CA 94062

IENERAL NOTES & SCHEDULE

SHEET NUMBER:	T2	3
DRAWN BY:	CHECKEP BY:	APPROVED BY
VG	AF	KM

Call Before you Dlg! 1-800-227-2600

GENERAL NOTES

1. 120/240 POWER REQUIRED FOR 3-WIRE SERVICE.
2. GC TO REMOVE/CLEAN ALL DEBRIS, NAILS, STAPLES, OR NON-USED VERTICALS OFF THE POLE.
3. ALL CONSTRUCTION SHALL BE IN ACCORDANCE WITH MUNICIPAL, COUNTY, STATE, FEDERAL, GO95 AND G012B STANDARDS AND REQUILATIONS.
4. CALL USA 48 HOURS PRIOR TO EXCAVATING AT (800) 422-4133.
5. ALL LANDSCAPING TO BE RESTORED TO ORIGINAL CONDITION OR BETTER.
6. ALL EQUIPMENT TO BE BONDED.

7. METERING CABINET REQUIRES 3'[.914M] CLEARANCE AT DOOR OPENING. 8. CAULK CABINET BASE AT PAD.

STANDARD GROUNDING NOTES:

5/8"x8'[.016x2.44M] ROD, CAD WELD BELOW GRADE #6 GROUND AND BOND WIRE

. WOOD MOLDING, STAPLED EVERY 3'[.914M] AND AT EACH END . GROUNDS 3'[.914M] FROM POLE.

6. PLACE 3 #10GA WIRES FROM BREAKER TO METER BOX.

STANDARD CONDUIT NOTES:

. FOR UNDERGROUND USE SCHEDULE 40. . FOR RISERS USE SCHEDULE 80.

2. FUN KIDSLINS USE SCHEDULE 80.

3. PLACE 2",051M] GALVANIZED STEEL CONDUIT FOR ANY CONDUIT UNDER 3"[.076M], STUB UP 10"[3.04M] THEN CONVERT 10 SCHEDULE 80.

4. CONVERT 4"[.102M] CARRIER CONDUIT TO 3"[.076M] AT BASE OF POLE.

5. GC TO STUB UP POLE 10"[3.04M] W/3" POWER CONDUIT, POWER CO. 10 CONVERT FROM 3"[.076M] SCH. 80 TO 2"[.051M] SCH. 80 FROM 10P 0F STUB UP.

6. ALL CONDUIT WILL BE MAN DRILLED AND EQUIPPED WITH 3/8"[.010M] PULL ROPE.

MAINTAIN 40"[1.02M] MINIMUM COVER FOR ELECTRICAL CONDUIT.
 MAINTAIN 30"[1.762M] MINIMUM COVER FOR COMMUNICATIONS CONDUIT.
 SADD SHADDING MINIMUM 1"[.025M] UNDER CONDUITS, AND 6"[.152M] COVERING ON TOP REQUIRED.
 ALL ELECTRICAL SERVICE CONDUITS FROM POWER COMPANY, WHETHER FROM POLES, TRANSFORMERS, OR OTHER LOCATIONS; WILL BE SLURRY BACKET LOCATIONS.

5. IN STREET SLURRY TO GRADE AND MILL DOWN 1-1/2"[.038M] FOR AC CAP. 6. IN DIRT SLURRY 18"[.457M] FROM GRADE, AND FILL WITH 95% COMPACTION NATIVE SOIL FOR BALANCE.

PLACE WARNING TAPE IN TRENCH 12"[.305M] ABOVE ALL CONDUITS AND #18 WARNING TAPE ABOVE GROUND RING.

. NO BOLT THREADS TO PROTRUDE MORE THAN 1-1/2"[.038M]. . FILL ALL HOLES LEFT IN POLE FROM REARRANGEMENT OF CLIMBERS.

ALL CLIMB STEPS NEXT TO CONDUIT SHALL HAVE EXTENDED STEPS.

4. CABLE NOT TO IMPEDE 15"[.381M] CLEAR SPACE OFF POLE FACE

4. CABLE NOT TO IMPEDE 151_ASTIM] CLEAR SPACE OFF POLE FACE (12:00).
5. 90' SHORT SWEEPS UNDER ANTENNA ARM. ALL CABLES MUST ONLY TRANSITION ON THE INSIDE OR BOTTOM OF ARMS (NO CABLE ON TOP OF ARMS).
6. USE CABLE CLAMPS TO SECURE CABLE TO ARMS; PLACE 2"[0.51 M] CARRIER CABLE ID TAGS ON BOTH SIDES OF ARMS.
7. USE 90' CONNECTOR AT CABLE CONNECTION TO ANTENNAS.
8. PLACE GPS ON ARM WITH SOUTHERN SYLEXPOSURE AT MINIMUM.

S'[1.83M] FROM TRANSMIT ANTENNA, WHICH IS 24"[.61M] AWAY FROM CENTER OF POLE.

9. USE 1/2"[.013M] CABLE ON ANTENNAS UNLESS OTHERWISE

10. FILL VOID AROUND CABLES AT CONDUIT OPENING WITH FOAM SEALANT TO PREVENT WATER INTRUSION.

ANTENNA/WOOD ARM AREA TOTAL	77.48 SQ. FT.	
TOP GRADE	37'-7"	
BOTTOM GRADE	33'-4"	
METER/BREAKER AREA TOTAL	4.33 SQ. FT.	
TOP GRADE	8'-0"	
BOTTOM GRADE	7'-0"	
BATTERY BACK-UP AREA TOTAL	16.25 SQ. FT.	
TOP GRADE	11'-8"	
BOTTOM GRADE	9'-6"	
DELTA DECK AREA TOTAL	10.74 SQ. FT.	
TOP GRADE	14'-7"	
BOTTOM GRADE	12'-5"	
DELTA DECK (FUT.) AREA TOTAL	10.74 SQ. FT.	
TOP GRADE	17'-6"	
BOTTOM GRADE	15'-4"	
EXT. RISER SIZE	2"ø	
EXT. RISER LENGTH	27'-10"	
EXT. RISER BTM GRADE	14'-8"	
PWR RISER SIZE	1"ø	
PWR RISER LENGTH	8'-0"	
PWR RISER BTM GRADE	0'-0"	

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LOADING AND ANTENNA CABLE SCHEDULES

ANTENNA SECTOR

AI PHA

SECTOR


AZIMUTH

THICK(NESS)

WOOD

TOP OF PLATE (PARAPET)
TOP OF STEEL (SLAB)
TOP OF WALL

TOP OF WALL
TYPICAL
UNDER GROUND
UNDERWRITERS LABORATORY
UNLESS NOTED OTHERWISE
VERIFY IN FIELD
WIDE(WIDTH)
WITH

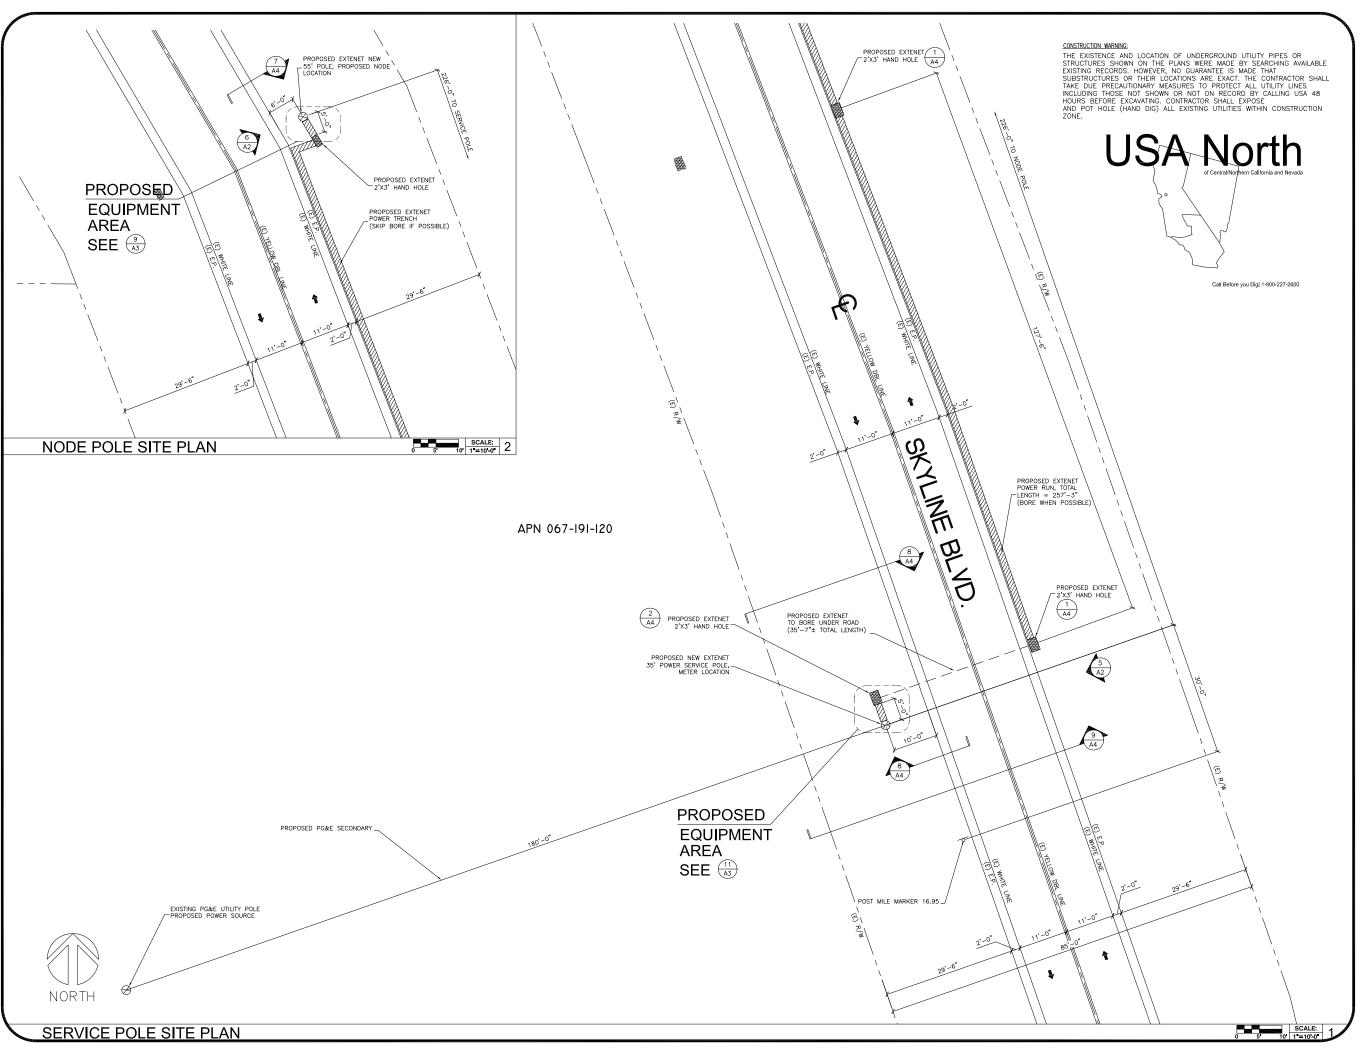



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CURRENT ISSUE DATE:

04/26/10

PLANS PREPARED BY:



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LICENSURE

1 SILL NO

HWY8435-001A

SITE NAME & ADDRESS:

HIGHWAY 84/35 NETWORK NODE I

14040 SKYLINE BLVD (SOUTHEAST OF) WOODSIDE, CA 94062

SEFT 11

SITE PLAN

DRAWN BY: CHECKED BY: APPROVED BY:
VG AF KM
SHEET NUMBER:
A 1 REVISION:


CONSTRUCTION WARNING:


CONSINUCION WARNING:

THE EXISTENCE AND LOCATION OF UNDERGROUND UTILITY PIPES OR STRUCTURES SHOWN ON THE PLANS WERE MADE BY SEARCHING AVAILABLE EXISTING RECORDS. HOWEVER, NO GUARANTEE IS MADE THAT SUBSTRUCTURES OR THEIR LOCATIONS ARE EXACT. THE CONTRACTOR SHALL TAKE DUE PRECAUTIONARY MEASURES TO PROTECT ALL UTILITY LINES INCLUDING THOSE NOT SHOWN OR NOT ON RECORD BY CALLING USA 48 HOURS BEFORE EXCAVATING, CONTRACTOR SHALL EXPOSE AND POT HOLE (HAND DIG) ALL EXISTING UTILITIES WITHIN CONSTRUCTION ZONE.

EXTENET NEW FACILITIES PROFILE



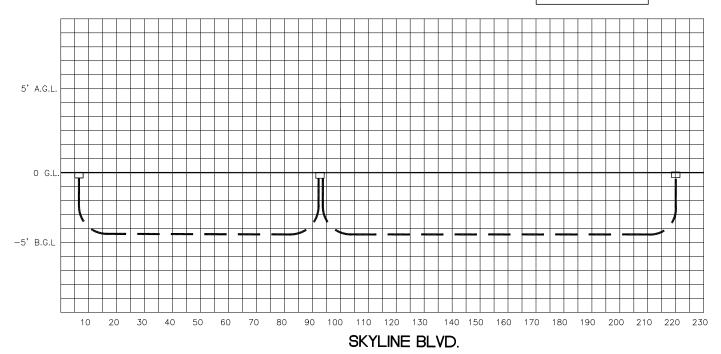

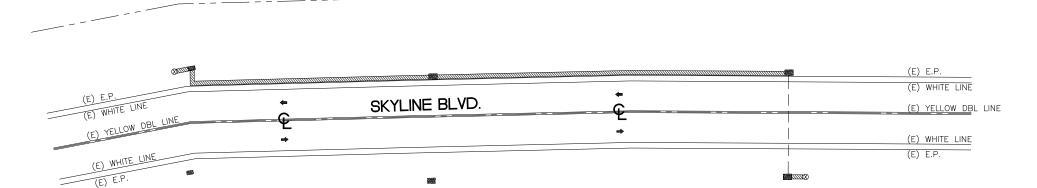

(E) R/W

__(E)_R/W_

APN 067-191-120

USA North

Call Before you Dig! 1-800-227-2600

NORTH

_ _(E) R/W_ _ _

(E) R/W - -

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LICENSURE:	
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Water Company	

SITE NO.:

HWY8435-001A

SITE NAME & ADDRESS:


HIGHWAY 84/35 NETWORK NODE I

14040 SKYLINE BLVD (SOUTHEAST OF) WOODSIDE, CA 94062

PLAN AND PROFILE

DRAWN BY: CHECKED BY: KM REVISION: 3

PLAN AND PROFILE

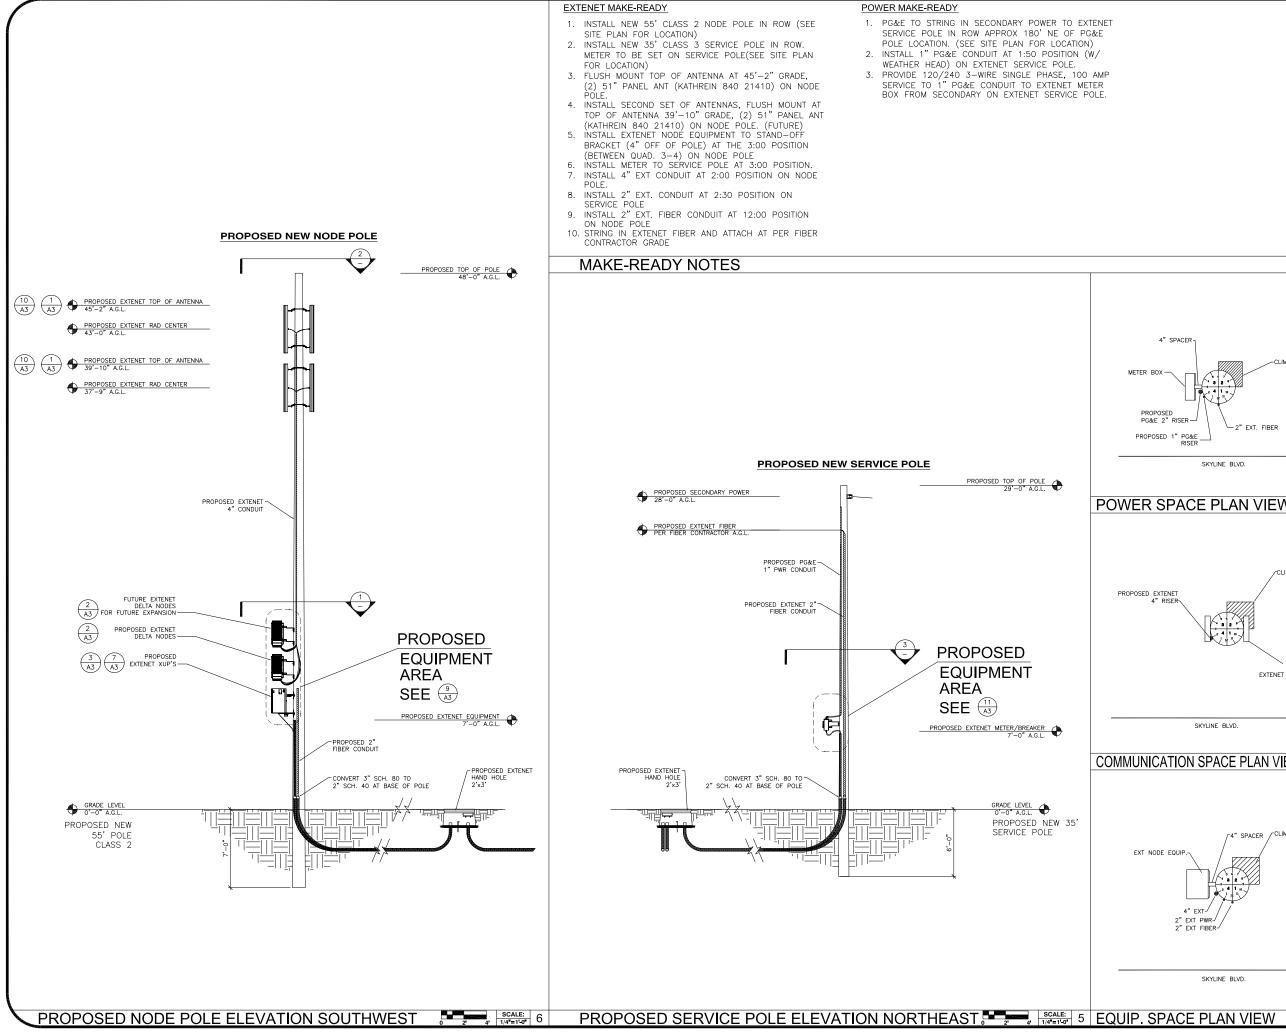

EXTENET MAKE-READY

- 1. INSTALL NEW 55' CLASS 2 NODE POLE IN ROW (SEE SITE PLAN FOR LOCATION)
- 2. INSTALL NEW 35' CLASS 3 SERVICE POLE IN ROW. METER TO BE SET ON SERVICE POLE(SEE SITE PLAN FOR LOCATION)
- 3. FLUSH MOUNT TOP OF ANTENNA AT 45'-2" GRADE,
 (2) 51" PANEL ANT (KATHREIN 840 21410) ON NODE
- POLE.

 INSTALL SECOND SET OF ANTENNAS, FLUSH MOUNT AT TOP OF ANTENNA 39'-10" GRADE, (2) 51" PANEL ANT (KATHREIN 840 21410) ON NODE POLE. (FUTURE)

 INSTALL EXTENET NODE EQUIPMENT TO STAND-OFF
- BRACKET (4" OFF OF POLE) AT THE 3:00 POSITION (BETWEEN QUAD. 3-4) ON NODE POLE INSTALL METER TO SERVICE POLE AT 3:00 POSITION.
- 8. INSTALL 2" EXT. CONDUIT AT 2:30 POSITION ON
- INSTALL 2" EXT. FIBER CONDUIT AT 12:00 POSITION ON NODE POLE
- 10. STRING IN EXTENET FIBER AND ATTACH AT PER FIBER CONTRACTOR GRADE

POWER MAKE-READY


- PG&E TO STRING IN SECONDARY POWER TO EXTENET SERVICE POLE IN ROW APPROX 180' NE OF PG&E POLE LOCATION. (SEE SITE PLAN FOR LOCATION)
- 2. INSTALL 1" PG&E CONDUIT AT 1:50 POSITION (W/ WEATHER HEAD) ON EXTENET SERVICE POLE.
- 3. PROVIDE 120/240 3-WIRE SINGLE PHASE, 100 AMP SERVICE TO 1" PG&E CONDUIT TO EXTENET METER BOX FROM SECONDARY ON EXTENET SERVICE POLE.



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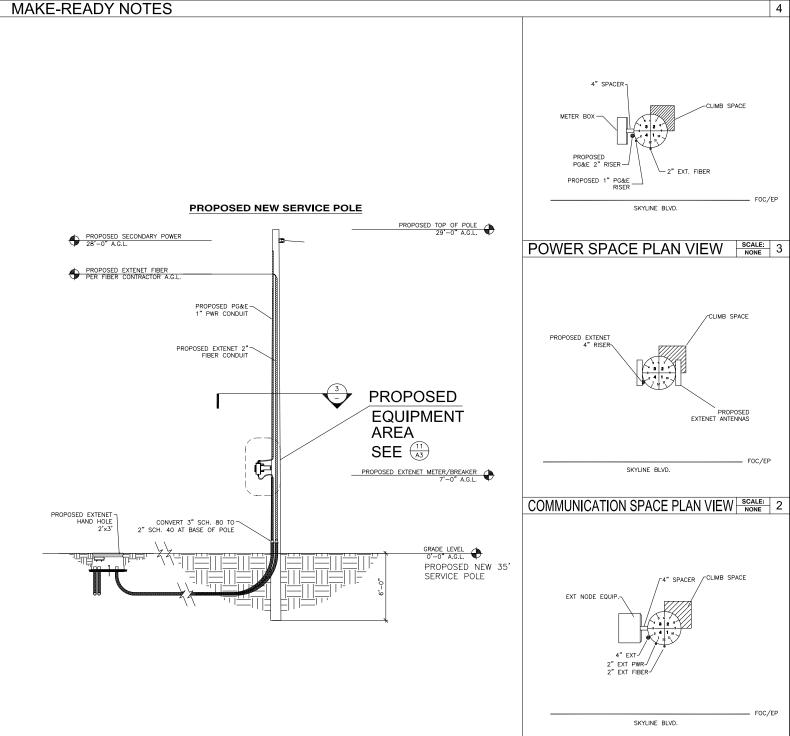
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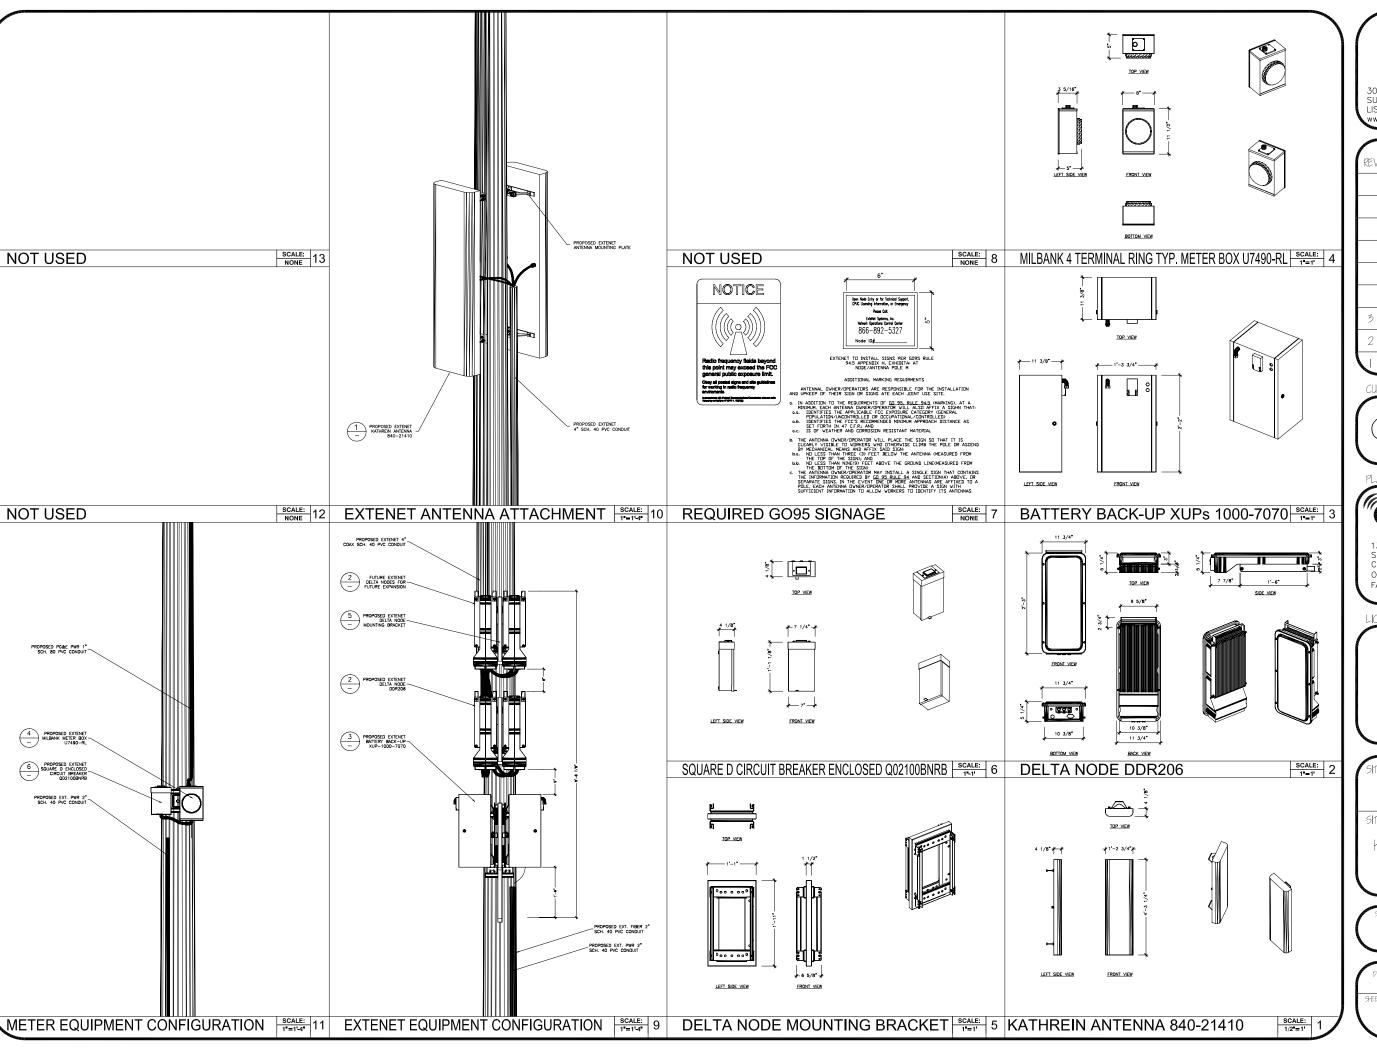
HIGHWAY 84/35 NETWORK NODE I

14040 SKYLINE BLVD (SOUTHEAST OF) WOODSIDE, CA 94062

LEVATIONS & RISER DETAIL:

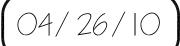SHEET NUMBER EVISION: 3







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		1
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7 SITE NO .:

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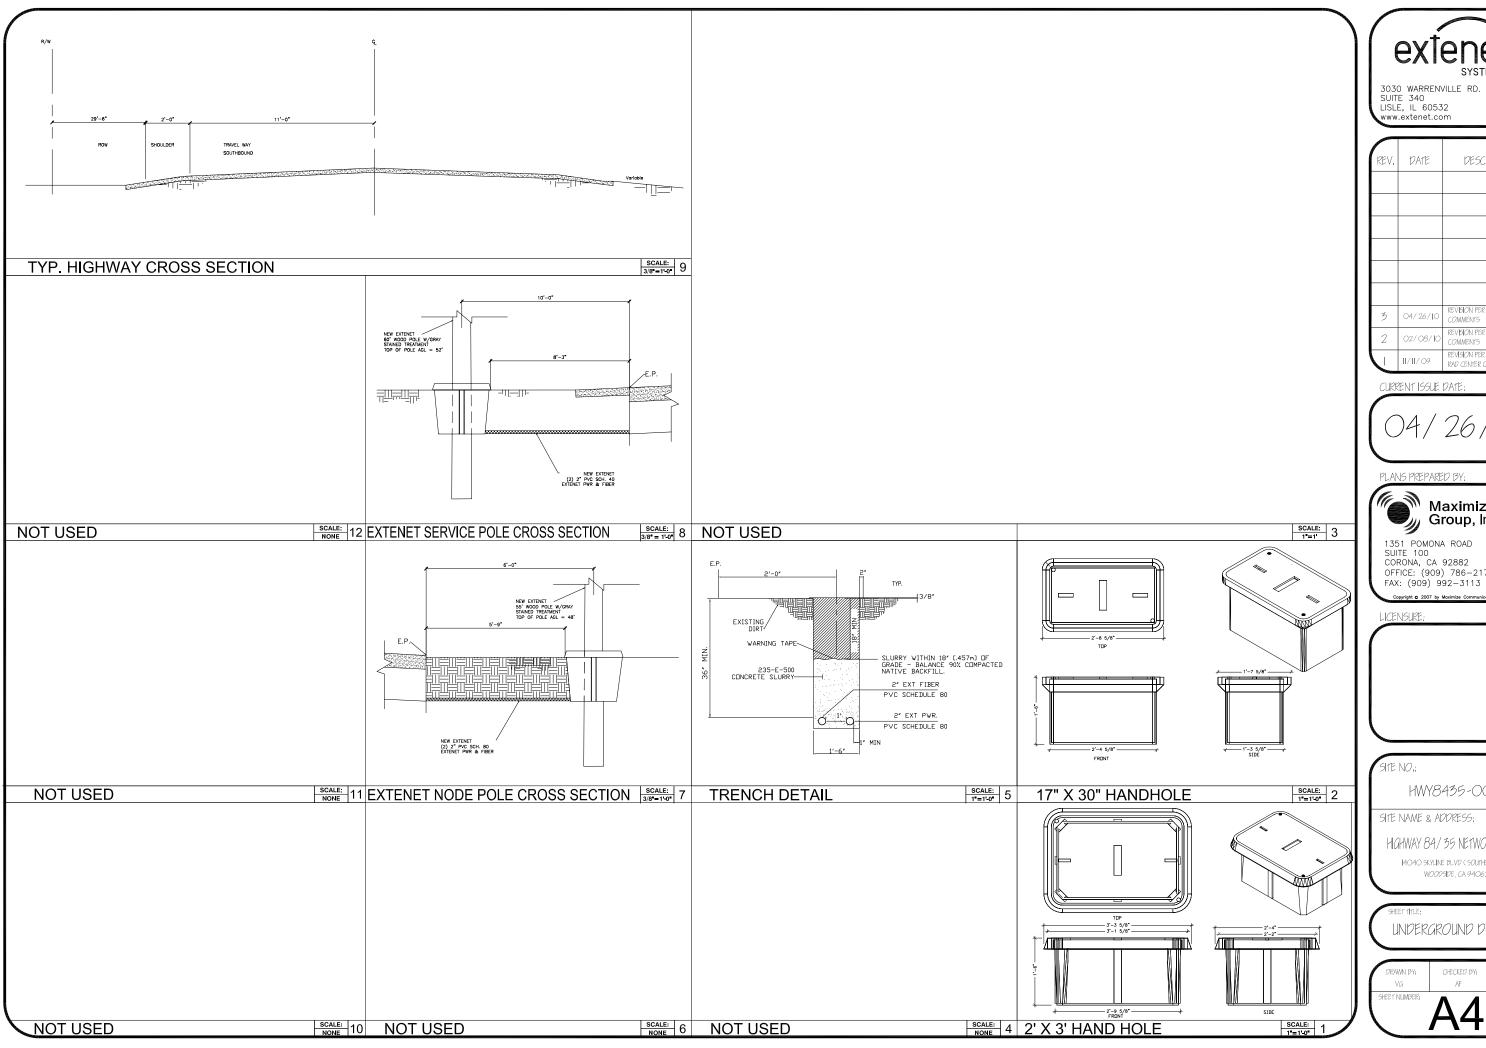
HIGHWAY 84/35 NETWORK NODE I

14040 SKYLINE BLVD (SOUTHEAST OF) WOODSIDE, CA 94062

SHEET 111

AERIAL DETAILS

VG AF KM SHEET NUMBER: A REVISION:	DRAWN BY:	CHECKED BY:	APPROVED BY:
		A*	





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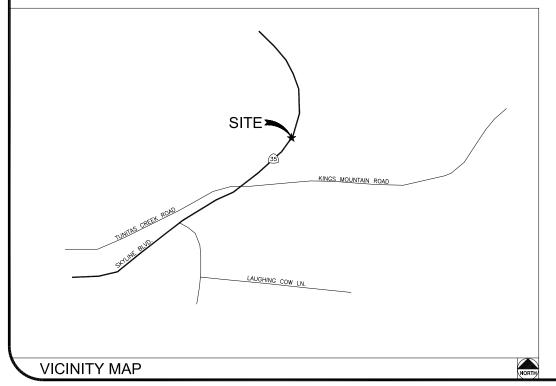
14040 SKYLINE BLVD (SOUTHEAST OF) WOODSIDE, CA 94062

UNDERGROUND DETAILS

DRAWN BY:	CHECKED BY:	APPROVED BY:
VG	AF	KM
SHEET NUMBER:	A4	REVISION:



HWY 35 - PROJECT
HWY8435 - 002A
POST MILE MARKER 16.26
14442 SKYLINE BLVD.
WOODSIDE, CA 94062



CLIENT

EXTENET SYSTEMS, INC. 3030 WARRENVILLE RD. SUITE 340 LISLE, IL 60532 CONTACT JEFF FRYE PHONE 480-626-1271 FAX 504-285-1603

POLE OWNER

EXTENET SYSTEMS, INC. 3030 WARRENVILLE RD. SUITE 340 LISLE, IL 60532 CONTACT JEFF FRYE PHONE 480-626-1271 FAX 504-285-1603

ENGINEERING FIRM/SURVEYING

MAXIMIZE COMMUNICATION GROUP, INC. 1351 POMONA ROAD SUITE 100 CORONA, CA 92882 CONTACT KELLI McCABE PHONE 909-786-2170 FAX 909-992-3113

COORDINATES

LAT: 37.42665 LONG: -122.3109

CODE COMPLIANCE:

ALL WORK AND MATERIALS SHALL BE PERFORMED & INSTALLED IN ACCORDANCE WITH THE CURRENT EDITIONS OF THE FOLLOWING CODES AS ADOPTED BY LOCAL GOVERNING AUTHORITIES AND LOCAL/CITY/COUNTY ORDINANCES:

 CALIFORNIA ADMINISTRATIVE CODE (INCLUDING TITLE 24 & 25).

- 2. 2007 CALIFORNIA BUILDING CODE.
- 2007 CALIFORNIA ELECTRICAL CODE.
- 3. BUILDING OFFICIALS AND CODE ADMINISTRATORS (BOCA).
- 4. UNIFORM PLUMBING & MECHANICAL CODES.
- 5. ANSI/EIA-222-F LIFE SAFETY CODE.
- 6. CALIFORNIA GENERAL ORDER 95, 128 & 165.

		OHEET INDEX			
	SHEET	DESCRIPTION			
	T1	TITLE SHEET			
	T2	GENERAL CONSTRUCTION NOTE & ANTENNA CABLE SCHEDULE			
	A1	SITE PLAN			
	A1.2	PLAN AND PROFILE			
	A2	UTILITY POLE ELEVATIONS/RISER DETAILS			
	А3	AERIAL DETAILS			
	A4	UNDERGROUND DETAILS			
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SHEET INDEX



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PLANS PREPARED BY:



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4	No.	
7	SITE	MO
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	2111	INC.

HWY8435-002A

SITE NAME & ADDRESS:


HIGHWAY 84/35 NETWORK NODE 2

14442 SKYLINE BLVD (ACROSS STREET) WOODSIDE CA 94062

SHEET 111

TITLE SHEET

IKED BY: APPROVED BY AF KM
ı ⊿ KEVISION:
1 0

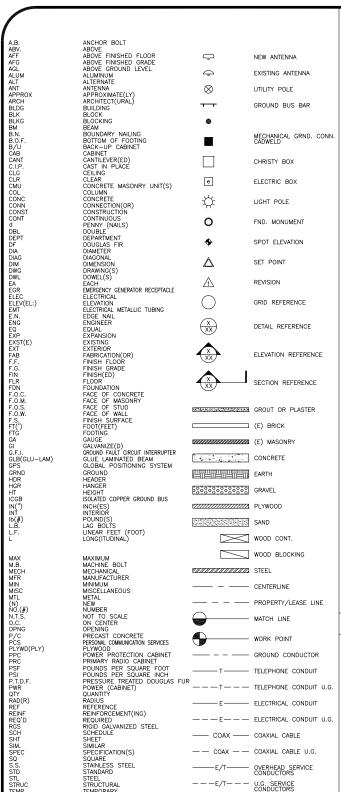

- 1. THE CONTRACTOR SHALL BE RESPONSIBLE FOR SURVEY MONUMENTS AND/OR VERTICAL CONTROL BENCHMARKS WHICH ARE DISTURBED OR DESTROYED BY CONSTRUCTION. A LAND SURVEYOR MUST FIELD LOCATE, REFERENCE, AND/OR PRESERVE ALL HISTORICAL OR CONTROLLING MONUMENTS PRIOR TO ANY EARTHWORK. IF DESTROYED, SUCH MONUMENTS SHALL BE REPLACED WITH APPROPRIATE MONUMENTS BY A LAND SURVEYOR. A CORNER RECORD OR RECORD OF SURVEY, AS APPROPRIATE, SHALL BE FILED AS REQUIRED BY THE PROPRESSIONAL LAIDS SURVEYOR.
- APORTANT NOTICE: SECTION 4215 OF THE GOVERNMENT CODE REQUIRES A DIG ALERT IDENTIFICATIO NUMBER BE ISSUED BEFORE A "PERMT TO EXCAVATE" WILL BE VALID. FOR YOUR DIG ALERT I.D. NUMBER, CALL UNDERGROUND SERVICE ALERT, TOLL FREE 1-800-422-4133, TWO DAYS BEFORE YOU DIG.
- CROSS THE PROPOSED TRENCH LINE AND MUST MAINTAIN A 1' MINIMUM VERTICAL CLEARANCE.
- 4. IF ANY EXISTING HARDSCAPE OR LANDSCAPE INDICATED ON THE APPROVE PLANS IS DAMAGED OR REMOVED DURING DEMOLITION OR CONSTRUCTION, IT SHALL BE REPAIRED AND/OR REPLACED IN KIND PER THE APPROVED PLANS.
- 5. CONTRACTOR SHALL REPLACE OR REPAIR ALL TRAFFIC SIGNAL LOOPS, CONDUIT, AND LANE STRIPING DAMAGED DURING CONSTRUCTION.
- 6. THIS PROJECT WILL BE INSPECTED BY ENGINEERING AND FIELD ENGINEERING DIVISION
- 7. MANHOLES OR COVERS SHALL BE LABELED EXTENET
- 8. CONTRACTOR SHALL IMPLEMENT AN EROSION CONTROL PROGRAM DURING THE PROJECT CONSTRUCTION ACTIVITIES. THE PROGRAM SHALL MEET THE APPLICABLE REQUIREMENTS OF THE STATE WATER RESOURCE CONTROL
- 9. THE CONTRACTOR SHALL HAVE EMERGENCY MATERIALS AND EQUIPMENT ON HAND FOR UNFORESEEN SITUATIONS, SUCH AS DAMAGE TO UNDERGROUND WATER, SEWER, AND STORM DRAIN FACILITIES WHEREBY FLOWS MAY GENERATE EROSION AND SEDIMENT POLLUTION.

USA North

Call Before you Dlg! 1-800-227-2600

- INDEMNIFICATION CLAUSE: THE CONTRACTOR AGREES AND SHALL: ASSUME SOLE AND COMPLETE RESPONSIBILITY OF THE JOB SITE CONDITIONS DURING THE COURSE OF CONSTRUCTION OF THIS PROJECT, INCLUDING THE EAFETY OF ALL PERSONS AND PROPERTIES. THAT THESE REQUIREMENTS SHALL APPLY CONTINUOUSLY AND NOT BE LIMITED TO NORMAL WORKING HOURS AND CONDITIONS. ENGINEERS HARMLESS FROM ANY AND ALL LIABILITY, REAL OR ALLEGED IN CONNECTION WITH THE PERFORMANCE
- 2. PRIOR TO THE BEGINNING OF ANY CONSTRUCTION AND THROUGHOUT THE COURSE OF CONSTRUCTION WORK. THE CONTRACTOR SHALL FULLY COMPLY WITH "CALIFORNIA OCCUPATIONAL SAFETY AND HEALTH" ACT OF 1973 INCLUDING ALL REVISIONS AND AMENDMENTS THERETO.
- 3. ALL WORK SHALL CONFORM TO THE LATEST EDITIONS OF G095,128 AND THE STANDARD "SPECIFICATIONS FOR PUBLIC WORKS CONSTRUCTION" AS ADOPTED BY THE CITY, COUNTY OR STATE AS MODIFIED BY STANDARD PLANS
- 4. THE EXISTENCE AND LOCATION OF UTILITIES AND OTHER AGENCY'S FACILITIES AS SHOWN HERON ARE OBJECT OF AVAILABLE RECORDS. OTHER FACILITIES MAY SUSTE. THE CONTRACTOR SHALL VERIFY PRIOR TO THE START OF CONSTRUCTION AND SHALL USE EXTREME CARE AND PROTOCTIVE MEASURES TO OR AGENCY FACILITIES WITHIN THE LIMITS OF WORK, WHETHER THEY ARE SHOWN ON THIS PLAN OR NOT.
- 5. THE CONTRACTOR SHALL NOTIFY THE CITY, COUNTY OR STATE ENGINEER INSPECTION DEPARTMENT, AT LEAST TWO DAYS BEFORE START OF ANY WORK REQUIRING THEIR INVOLVEMENT.
- 6. THE CITY, COUNTY OR STATE SHALL SPECIFY THE EXPIRATION PERIOD OF THE PERMIT FOR THIS CONSTRUCTION PROJECT.
- 7. THE MINIMUM COVER FOR ALL CONDUITS PLACED UNDERGROUND SHALL BE 36 INCHES TO THE FINISHED GRADE AT ALL TIMES.
- 8. THE CONTRACTOR SHALL TUNNEL ALL CURB AND GUTTERS AND BORE ALL CONCRETE DRIVEWAYS AND WALKWAYS AT THE DIRECTION OF THE CITY, COUNTY OR STATE ENGINEER.
- ALL A.C AND/OR CONCRETE PAVEMENT SHALL BE REPLACED AT THE DIRECTION OF THE CITY, COUNTY OR STATE ENGINEERS.
- WORK, SHALL BE REPLANTED AND/OR REPLACED SO AS TO RESTORE THE WORK SITE TO ITS ORIGINAL CONDITION
- 11. THE CONTRACTOR WILL BE RESPONSIBLE FOR THE PROCESSING OF ALL APPLICANT PERMIT FORMS ALONG WITH THE REQUIRED LIABILITY INSURANCE FORMS. CLEARLY DEMONSTRATING THAT EXTENET, THE CITY, COUNTY OR STATE IS ALSO INSURED WITH THE REQUIRED LIABILITY INSURANCE IN THE AMOUNT OF \$1,000,000.00 FOR THIS
- 12. VAULTS, PEDESTALS, CONDUITS AND OTHER TYPES OF SUBSTRUCTURE ARE EITHER SPECIFIED ON THIS PLAN OR WILL BE SPECIFIED BY THE CONSTRUCTION ENGINEER. ANY AND ALL DEVIATIONS FROM THE SPECIFIED TYPES OF MATERIAL MUST BE APPROVED BY THE SYSTEM ENGINEER, IN WRITING BEFORE INSTALLATION THEREOF.
- 13. THE CONTRACTOR SHALL VERIFY THE LOCATION OF ALL EXISTING UTILITIES IN INCLUDING SEWER LATERALS & WATER SERVICES TO INDIVIDUAL LOTS BOTH VERTICAL AND HORIZONTAL PRIOR TO COMMENCING IMPROVEMENT
- 14. CONTRACTOR SHALL MAKE EXPLORATION EXCAVATIONS AND LOCATE EXISTING FACILITIES SUFFICIENTLY AHEAD OF CONSTRUCTION TO PERMIT REVISIONS TO PLANS IF REVISION IS NECESSARY BECAUSE OF LOCATION OF
- 15. THE LOCATIONS OF ALL EXISTING UTILITIES SHOWN ON THESE PLANS ARE FROM EXISTING RECORDS AND CORROBORATED, WHERE POSSIBLE, WITH FIELD TIES. THE CONTRACTOR IS RESPONSIBLE FOR CONFIRMINT LOCATIONS SHOWN, BOTH HORIZONIAL AND VERTICALLY. PRIOR TO CONSTRUCTION, IF EXISTING LOCATIONS WAR SUBSTANTIALLY FROM THE PLANS. THE ENGINEER SHOULD BE NOTIFIED TO MAKE ANY CONSTRUCTION CHANGES

EROSION AND SEDIMENT CONTROL NOTES

TEMPORARY EROSION/SEDIMENT CONTROL PRIOR TO COMPLETION OF FINAL IMPROVEMENTS, SHALL BE PERFORMED BY THE CONTRACTOR OR QUALIFIED PERSON AS INDICATED BELOW:

- 1. ALL REQUIREMENTS OF THE CITY, COUNTY AND STATE "STORM WATER STANDARDS" MUST BE INCORPORATED INTO THE DESIGN AND CONSTRUCTION OF THE PROPOSED GRADING/IMPROVMENTS CONSISTENT WITH THE APPROVED STORM WATER POLLUTION PREVENTION PLAN (SWPPP), WATER QUALITY TECHNICAL REPORT (WQTR), AND/OR WATER POLLUTION CONTROL PLAN (WPCP).
- 2. FOR STORM DRAIN INLETS, PROVIDE A GRAVEL BAG SILT BASIN IMMEDIATELY UPSTREAM OF INLET AS INDICATED ON DETAILS.
- 3. FOR INLETS LOCATED AT SUMPS ADJACENT TO TOP OF SLOPES. THE CONTRACTOR SHALL ENSURE THAT WATER PORNING TO THE SUMP IS DIRECTED INTO THE INLET AND THAT A MINIMUM OF 1.00' FREEBOARD EXISTS AND IS MAINTAINED ABOVE THE TOP OF THE INLET. IF FREEBOARD IS NOT PROVIDED BY GRADIOS SHOWN ON THESE PLANS THE CONTRACTOR SHALL PROVIDE IT VIA TEMPORARY MEASURES, I.E. GRAVEL BAGS OR DIKES.
- THE CONTRACTOR OR QUALIFIED PERSON SHALL BE RESPONSIBLE FOR CLEANUP OF SILT AND MUD ON ADJACENT STREET(S) AND STORM DRAIN SYSTEM DUE TO CONSTRUCTION ACTIVITY.
- 5. THE CONTRACTOR OR QUALIFIED PERSON SHALL CHECK AND MAINTAIN ALL LINED AND UNLINED DITCHES AFTER EACH RAINFALL.
- 6. THE CONTRACTOR SHALL REMOVE SILT AND DEBRIS AFTER EACH MAJOR RAINFALL
- B. THE CONTRACTOR SHALL RESTORE ALL EROSION/SEDIMENT CONTROL DEVICES TO WORKING ORDER TO THE SATISFACTION OF THE CITY ENGINEER OF RESIDENT ENGINEER AFTER EACH RUN-OFF PRODUCING RAINFALL.
- 9. THE CONTRACTOR SHALL INSTALL ADDITIONAL EROSION/SEDIMENT CONTROL MEASURES AS MAY BE REQUIRED BY THE RESIDENT ENGINEER DUE TO UNCOMPLETED GRADING OPERATIONS OR UNFORESEEN CIRCUMSTANCES,
- 10. THE CONTRACTOR SHALL BE RESPONSIBLE AND SHALL TAKE NECESSARY PRECAUTIONS TO PREVENT PUBLIC TRESPASS ONTO AREAS WHERE IMPOUNDED WATERS CREATE A HAZARDOUS CONDITION.
- 11. ALL EROSION/SEDIMENT CONTROL MEASURES PROVIDED PER THE APPROVED GRADING PLAN SHALL BE INCORPORATED HERON. ALL EROSION/SEDIMENT CONTROL FOR INTERIM CONDITIONS SHALL BE DONE TO THE SATISFACTION OF THE RESIDENT ENGINEER.
- 12. GRADED AREAS AROUND THE PROJECT PERIMETER MUST DRAIN AWAY FROM THE FACE OF THE SLOPE AT THE CONCLUSION OF EACH WORKING DAY.
- 13. ALL REMOVABLE PROTECTIVE DEVICES SHOWN SHALL BE IN PLACE AT THE END OF EACH WORKING DAY WHEN RAIN IS IMMINENT.
- 14. THE CONTRACTOR SHALL ONLY GRADE, INCLUDING CLEARING AND GRUBBING FOR THE AREAS FOR WHICH THE CONTRACTOR OR QUALIFIED PERSON CAN PROVIDE EROSION/SEDIMENT CONTROL MEASURES.
- 15. THE CONTRACTOR SHALL ARRANGE FOR WEEKLY MEETINGS DURING OCTOBER 1ST TO APRIL 30TH FOR PROJECT FEAM (GENERAL CONTRACTOR, QUALIFIED PERSON, EROSION CONTROL SUBCONTRACTOR IF AN, ENGINEER OF WORK, OWNER/DEVELOPER AND THE RESIDENT ENGINEER) TO EVALUATE THE ADEQUACY OF THE EROSION/SEDIMENT CONTROL MEASURE AND OTHER RELATED CONSTRUCTION ACTIVITIES.

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ı	-400		1975



1351 POMONA ROAD CORONA, CA 92882 OFFICE: (909) 786-2170 FAX: (909) 992-3113

2

CABLE SIZE

1/2"

1/2"

HWY8435-002A

SITE NAME & ADDRESS:

HIGHWAY 84/35 NETWORK NODE 2

14442 SKYLINE BLVD (ACROSS STREET) WOODSDE, CA 94062

IENERAL NOTES & SCHEDULE

KM SHEET NUMBER: EVISION: 3

GENERAL NOTES

- 1. 120/240 POWER REQUIRED FOR 3-WIRE SERVICE.
 2. GC TO REMOVE/CLEAN ALL DEBRIS, NAILS, STAPLES, OR NON-USED VERTICALS OFF THE POLE.
 3. ALL CONSTRUCTION SHALL BE IN ACCORDANCE WITH MUNICIPAL, COUNTY, STATE, FEDERAL, GO95 AND G0128 STANDARDS AND REQUILATIONS.
 4. CALL USA 48 HOURS PRIOR TO EXCAVATING AT (800) 422-4133.
 5. ALL LANDSCAPING TO BE RESTORED TO ORIGINAL CONDITION OR BETTER.
 6. ALL EQUIPMENT TO BE BONDED.

- 7. METERING CABINET REQUIRES 3'[.914M] CLEARANCE AT DOOR OPENING. 8. CAULK CABINET BASE AT PAD.
- STANDARD GROUNDING NOTES:
- 5/8"x8'[.016x2.44M] ROD, CAD WELD BELOW GRADE
- #6 GROUND AND BOND WIRE . WOOD MOLDING, STAPLED EVERY 3'[.914M] AND AT EACH END
- 3. PLACE 3 #10GA WIRES FROM BREAKER TO METER BOX.

STANDARD CONDUIT NOTES:

- 1. FOR UNDERGROUND USE SCHEDULE 40.
 2. FOR RISERS USE SCHEDULE 80.
 3. PLACE 2"[.051M] GALVANIZED STEEL CONDUIT FOR ANY CONDUIT UNDER 3"[.076M], STUB UP 10"[3.04M] THEN CONVERT TO SCHEDULE 80.
 4. CONVERT 4"[.102M] CARRIER CONDUIT TO 3"[.076M] AT BASE OF POLE.
 5. GC TO STUB UP POLE 10"[3.04M] w/3" POWER CONDUIT, POWER CO. TO CONVERT TROM 3"[.076M] SCH. 80 TO 2"[.051M] SCH. 80 FROM TOP OF STUB UP.
- 6. ALL CONDUIT WILL BE MAN DRILLED AND EQUIPPED WITH 3/8"[.010M] PULL ROPE.

- MAINTAIN 40"[1.02M] MINIMUM COVER FOR ELECTRICAL CONDUIT.
 MAINTAIN 30"[7.52M] MINIMUM COVER FOR COMMUNICATIONS CONDUIT.
 SAND SHADNIG MINIMUM 1"[0.25M] UNDER CONDUITS, AND 6"[1.152M] COVERING ON TOP REQUIRED.
 ALL ELECTRICAL SERVICE CONDUITS FROM POWER COMPANY, WHETHER FROM POLES, TRANSFORMERS, OR OTHER LOCATIONS; WILL BE SLURRY BACKFILLED.
- 5. IN STREET SLURRY TO GRADE AND MILL DOWN 1-1/2"[.038M] FOR AC CAP.
 6. IN DIRT SLURRY 18"[.457M] FROM GRADE, AND FILL WITH 95% COMPACTION NATIVE SOLI FOR BALANCE.
- PLACE WARNING TAPE IN TRENCH 12"[.305M] ABOVE ALL CONDUITS AND #18 WARNING TAPE ABOVE GROUND RING.

- NO BOLT THREADS TO PROTRUDE MORE THAN 1-1/2"[.038M]. FILL ALL HOLES LEFT IN POLE FROM REARRANGEMENT OF CLIMBERS.
- ALL CLIMB STEPS NEXT TO CONDUIT SHALL HAVE EXTENDED STEPS.
- 4. CABLE NOT TO IMPEDE 15"[.381M] CLEAR SPACE OFF POLE FACE
- 4. CABLE NOT IMPEDE TS [_381M] CLEAR SPACE OF POLE FACE (12:00).

 5. 90° SHORT SWEEPS UNDER ANTENNA ARM. ALL CABLES MUST ONLY TRANSITION ON THE INSIDE OR BOTTOM OF ARMS (NO CABLE ON TOP OF ARMS).

 6. USE CABLE CLAMPS TO SECURE CABLE TO ARMS; PLACE 2"[_051M] CARRIER CABLE ID TAGS ON BOTH SIDES OF ARMS.

 7. USE 90° CONNECTOR AT CABLE CONNECTION TO ANTENNAS.

 8. PLACE GPS ON ARM WITH SOUTHERN SKY EXPOSURE AT MINIMUM.
- S'[1.83M] FROM TRANSMIT ANTENNA, WHICH IS 24"[.61M] AWAY FROM CENTER OF POLE. 9. USE 1/2"[.013M] CABLE ON ANTENNAS UNLESS OTHERWISE
- 10. FILL VOID AROUND CABLES AT CONDUIT OPENING WITH FOAM SEALANT TO PREVENT WATER INTRUSION.

ANTENNA/WOOD ARM AREA TOTAL	77.48 SQ. FT.
TOP GRADE	38'-0"
BOTTOM GRADE	33'-8"
METER/BREAKER AREA TOTAL	4.33 SQ. FT.
TOP GRADE	8'-0"
BOTTOM GRADE	7'-0"
BATTERY BACK-UP AREA TOTAL	16.25 SQ. FT.
TOP GRADE	11'-8"
BOTTOM GRADE	9'-6"
DELTA DECK AREA TOTAL	10.74 SQ. FT.
TOP GRADE	14'-7"
BOTTOM GRADE	12'-5"
DELTA DECK (FUT.) AREA TOTAL	10.74 SQ. FT.
TOP GRADE	17'-6"
BOTTOM GRADE	15'-4"
EXT. RISER SIZE	2"ø
EXT. RISER LENGTH	18'-5"
EXT. RISER BTM GRADE	11'-1"
PWR RISER SIZE	1"ø
PWR RISER LENGTH	8'-0"
PWR RISER BTM GRADE	0'-0"

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WIND LOADING INFORMATION

ANTENNA & CABLE SCHEDULE

24

25'

2

MAKE / MODEL

840 21410

KATHREIN

THICK(NESS)

WOOD

TOP OF PLATE (PARAPET)
TOP OF STEEL (SLAB)
TOP OF WALL

TOP OF WALL
TYPICAL
UNDER GROUND
UNDERWRITERS LABORATOR'
UNLESS NOTED OTHERWISE
VERIFY IN FIELD
WIDE(WIDTH)
WITH


ANTENNA SECTOR

SECTOR ALPHA

SECTOR

AZIMUTH

227

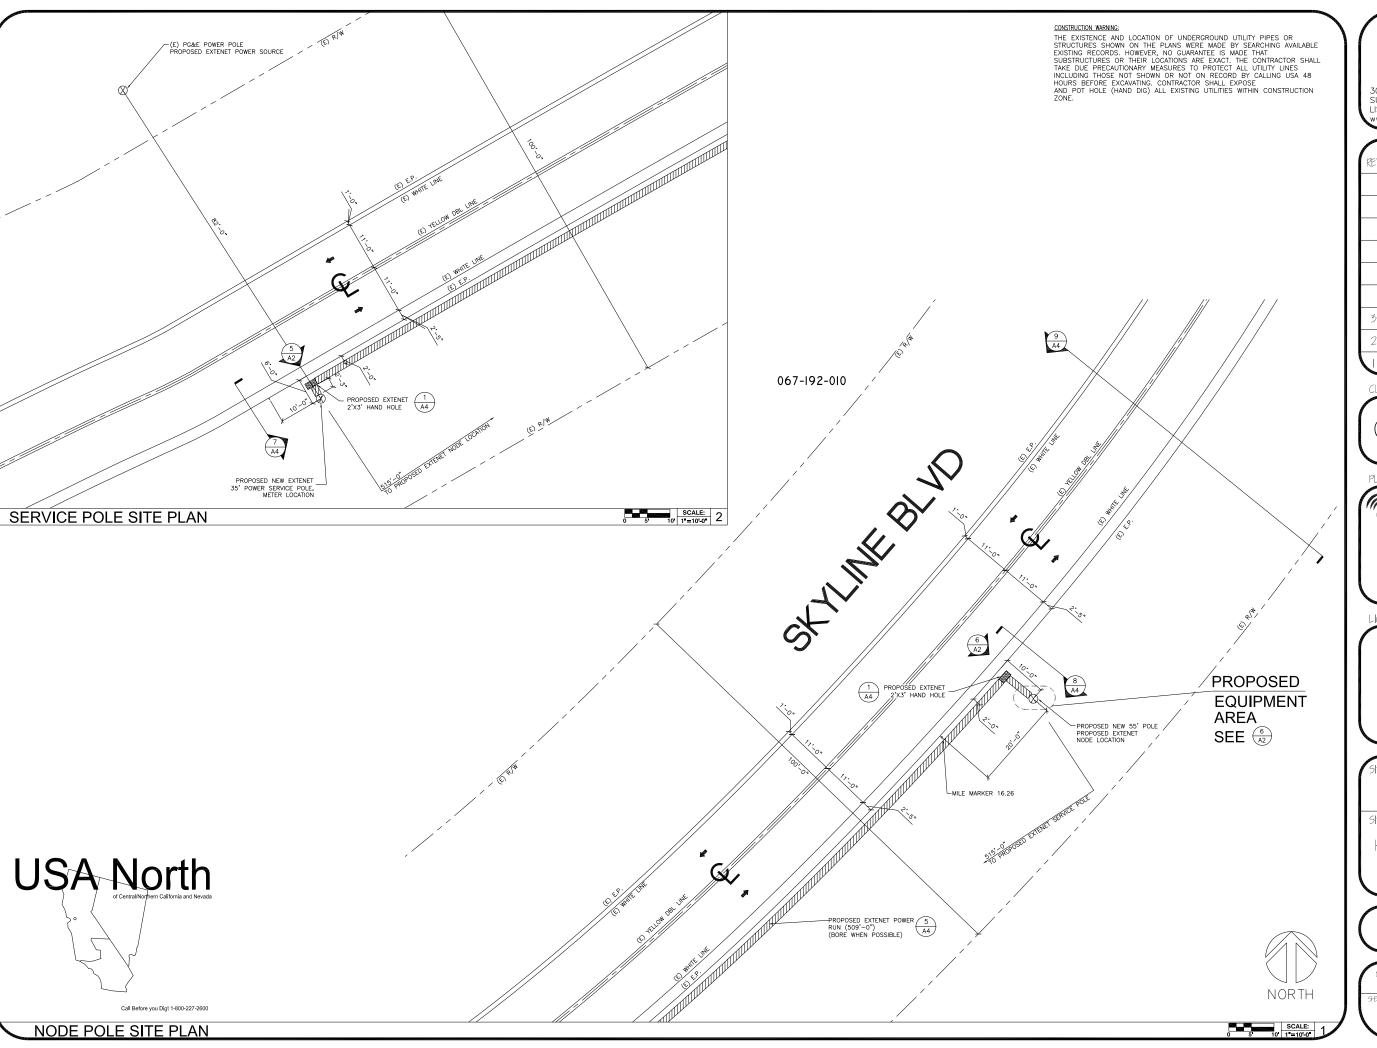



REV.	DATE	DESCRIPTION
3	04/26/10	REVISION PER CALTRANS COMMENTS
2	02/08/10	REVISION PER CALTRANS COMMENTS
	11/11/09	REVISION PER EXTENET REQUESTED RAD CENTER CHANGE

CURRENT ISSUE DATE:

04/26/10

PLANS PREPARED BY:



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SITE NO.:

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SITE NAME & ADDRESS:

HIGHWAY 84/35 NETWORK NODE 2

14442 SKYLINE BLVD (ACROSS STREET) WOODSIDE, CA 94062

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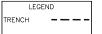
SITE PLAN

DRAWN BY:	CHECKED BY:	APPROVED BY
VG	AF	KM
SHEET NUMBER:		REVISION:


CONSINCULION WARNING:
THE EXISTENCE AND LOCATION OF UNDERGROUND UTILITY PIPES OR
STRUCTURES SHOWN ON THE PLANS WERE MADE BY SEARCHING AVAILABLE
EXISTING RECORDS. HOWEVER, NO GUARANTEE IS MADE THAT
SUBSTRUCTURES OR THEIR LOCATIONS ARE EXACT. THE CONTRACTOR SHALL
TAKE DUE PRECAUTIONARY MEASURES TO PROTECT ALL UTILITY LINES
INCLUDING THOSE NOT SHOWN OR NOT ON RECORD BY CALLING USA 48
HOURS BEFORE EXCAVATING. CONTRACTOR SHALL EXPOSE
AND POT HOLE (HAND DIG) ALL EXISTING UTILITIES WITHIN CONSTRUCTION
ZONE.



EXTENET NEW FACILITIES PROFILE





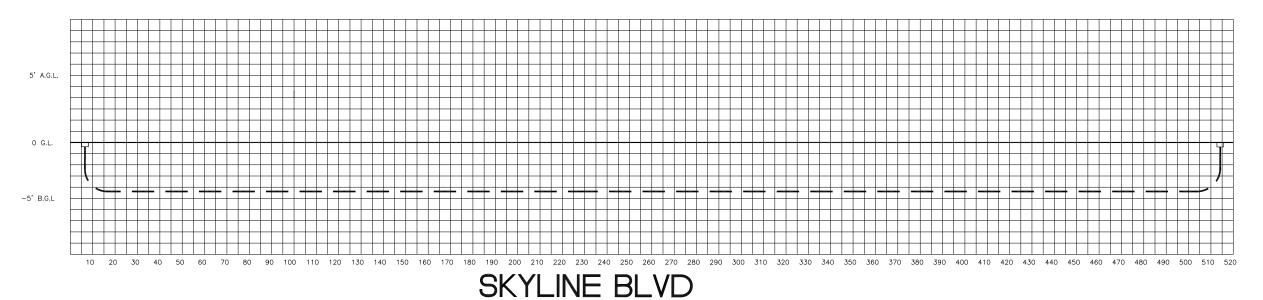

067-192-010

SKYLINE BLVD


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14442 SKYLINE BLVD (ACROSS STREET) WOODSIDE, CA 94062

PLAN AND PROFILE

DRAWN BY: VG	CHECKED BY: AF	APPROVED BY:
SHEET NUMBER	11.2	REVISION:

PLAN AND PROFILE

(E) R/W

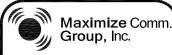(E) YELLOW DBL LIN

(E) WHITE LINE

(E) R/W _

MAKE-READY NOTES PROPOSED NEW NODE POLE PROPOSED TOP OF POLE 34'-0" A.G.L. PROPOSED EXTENET TOP OF ANTENNA 32'-2" A.G.L. PROPOSED EXTENET RADCENTER 30'-0" A.G.L. PROPOSED EXTENET TOP OF ANTENNA 26'-10" A.G.L. PROPOSED EXTENET RADCENTER 24'-9" A.G.L. FUTURE EXTENET DELTA NODES A3 FOR FUTURE EXPANSION-(2) (A3) PROPOSED EXTENET XUP'S-PROPOSED EXTENET EQUIPMENT 7'-0" A.G.L. **PROPOSED**

CONVERT 3" SCH. 80 TO

2" SCH. 40 AT BASE OF POLE

EQUIPMENT

PROPOSED ELEVATION NORTH WEST

PROPOSED EXTENET-

AREA

PROPOSED NEW 40' POLE CLASS 2 SEE $\frac{9}{A3}$

EXTENET MAKE-READY

- 1. INSTALL NEW 40' CLASS 2 NODE POLE IN ROW (SEE
- SITE PLAN FOR LOCATION)
 2. INSTALL NEW 35' CLASS 3 SERVICE POLE IN ROW. METER TO BE SET ON SERVICE POLE(SEE SITE PLAN FOR LOCATION)
- 3. FLUSH MOUNT TOP OF ANTENNA AT 32'-2" GRADE, (2) 51" PANEL ANT. (KATHREIN 840 21410) 4. FLUSH MOUNT TOP OF ANTENNA AT 26'-10" GRADE,
- (2) 51" PANEL ANT. (KATHREIN 840 21410) 5. INSTALL EXTENET NODE EQUIPMENT TO STAND-OFF
- BRACKET (4" OFF OF POLE) AT THE 3:00 POSITION (BETWEEN QUAD. 3-4) 6. INSTALL METER TO STAND-OFF BRACKET (4" OFF OF THE POLE) TO SERVICE POLE AT 6:00 POSITION.(

- BETWEEN QUAD 3-4)

 7. INSTALL 4" EXT CONDUIT AT 2:00 POSITION.

 8. INSTALL 2" EXT CONDUIT AT 7:50 ON SERVICE POLE.

 9. INSTALL 2" EXT PWR CONDUIT AT 1:00 ON NODE
- 10. INSTALL 2" EXT FIBER CONDUIT AT 12:00 ON NODE
- 11. STRING IN EXTENET FIBER AND ATTACH PER FIBER CONTRACTOR GRADE.

EXISTING ELEVATION WEST

POWER MAKE-READY

- 1. PG&E TO STRING IN SECONDARY POWER TO EXTENET SERVICE POLE IN ROW APPROX 82' SW OF PG&E
- POLE LOCATION. (SEE SITE PLAN FOR LOCATION)

 2. INSTALL 1" PG&E CONDUIT AT 8:50 POSITION (WITH WEATHER HEAD) ON SERVICE POLE.
- 3. PROVIDE 120/240 3-WIRE SINGLE PHASE, 100 AMP SERVICE TO 1" PG&E CONDUIT TO EXTENET METER BOX FROM SECONDARY.



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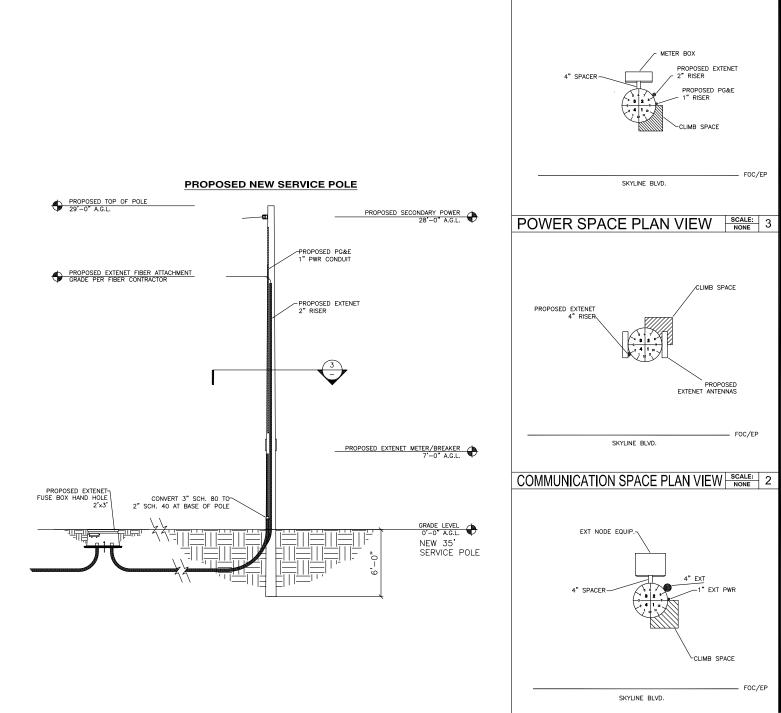
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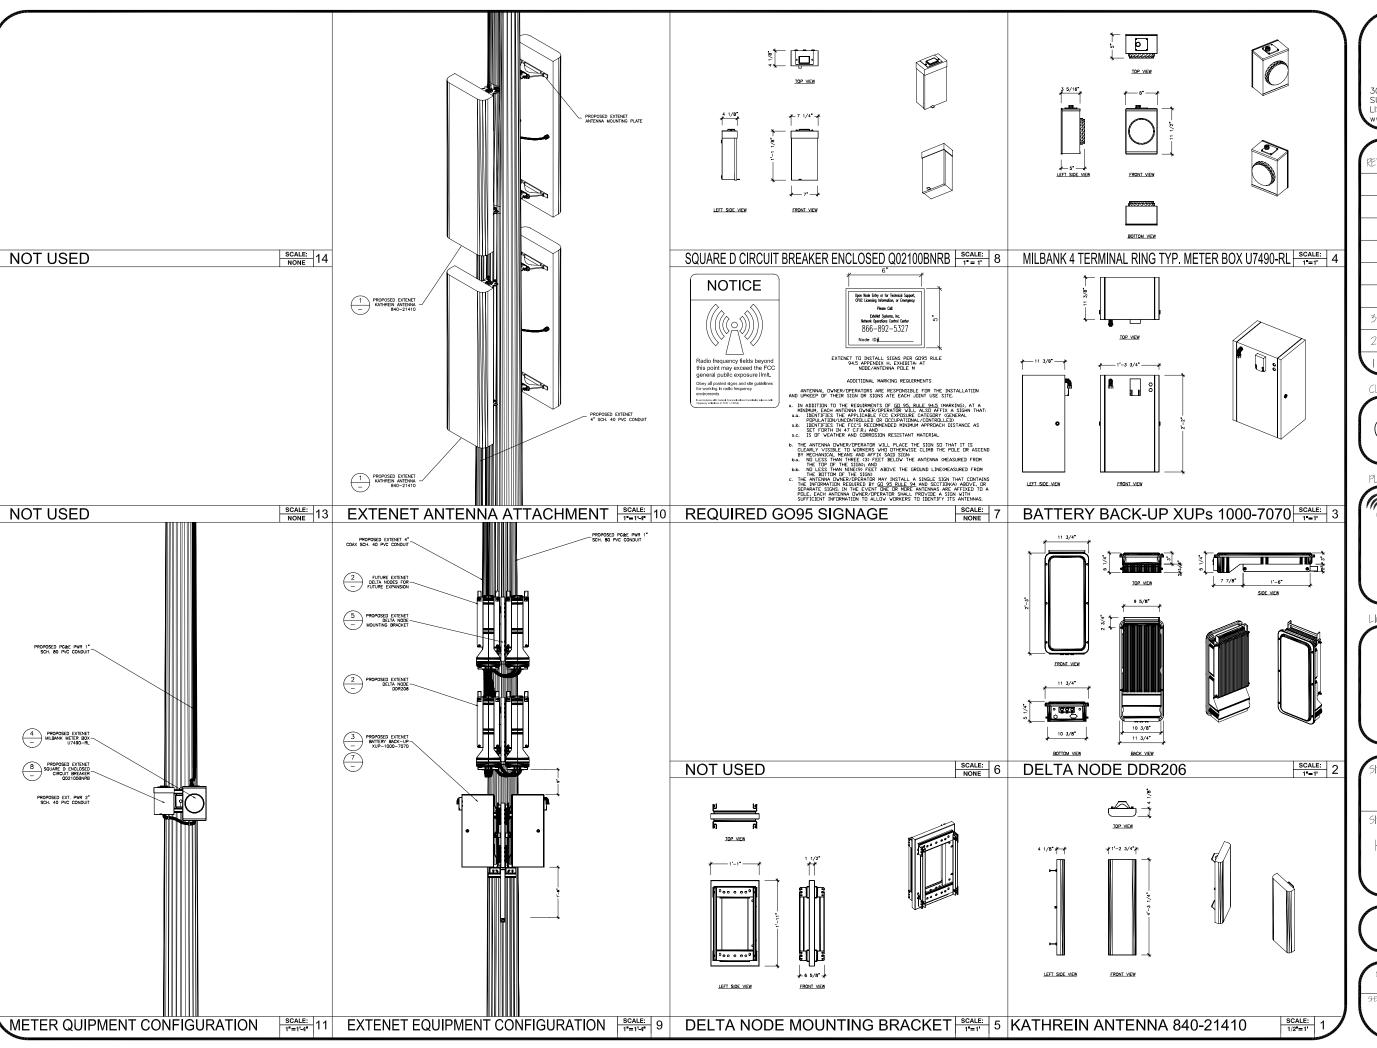
14442 SKYLINE BLVD (ACROSS STREET) WOODSIDE, CA 94062

LEVATIONS & RISER DETAIL'

EVISION: 3



SCALE: SCALE: NONE NONE





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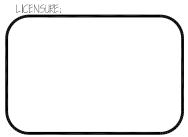
PLANS PREPARED BY:



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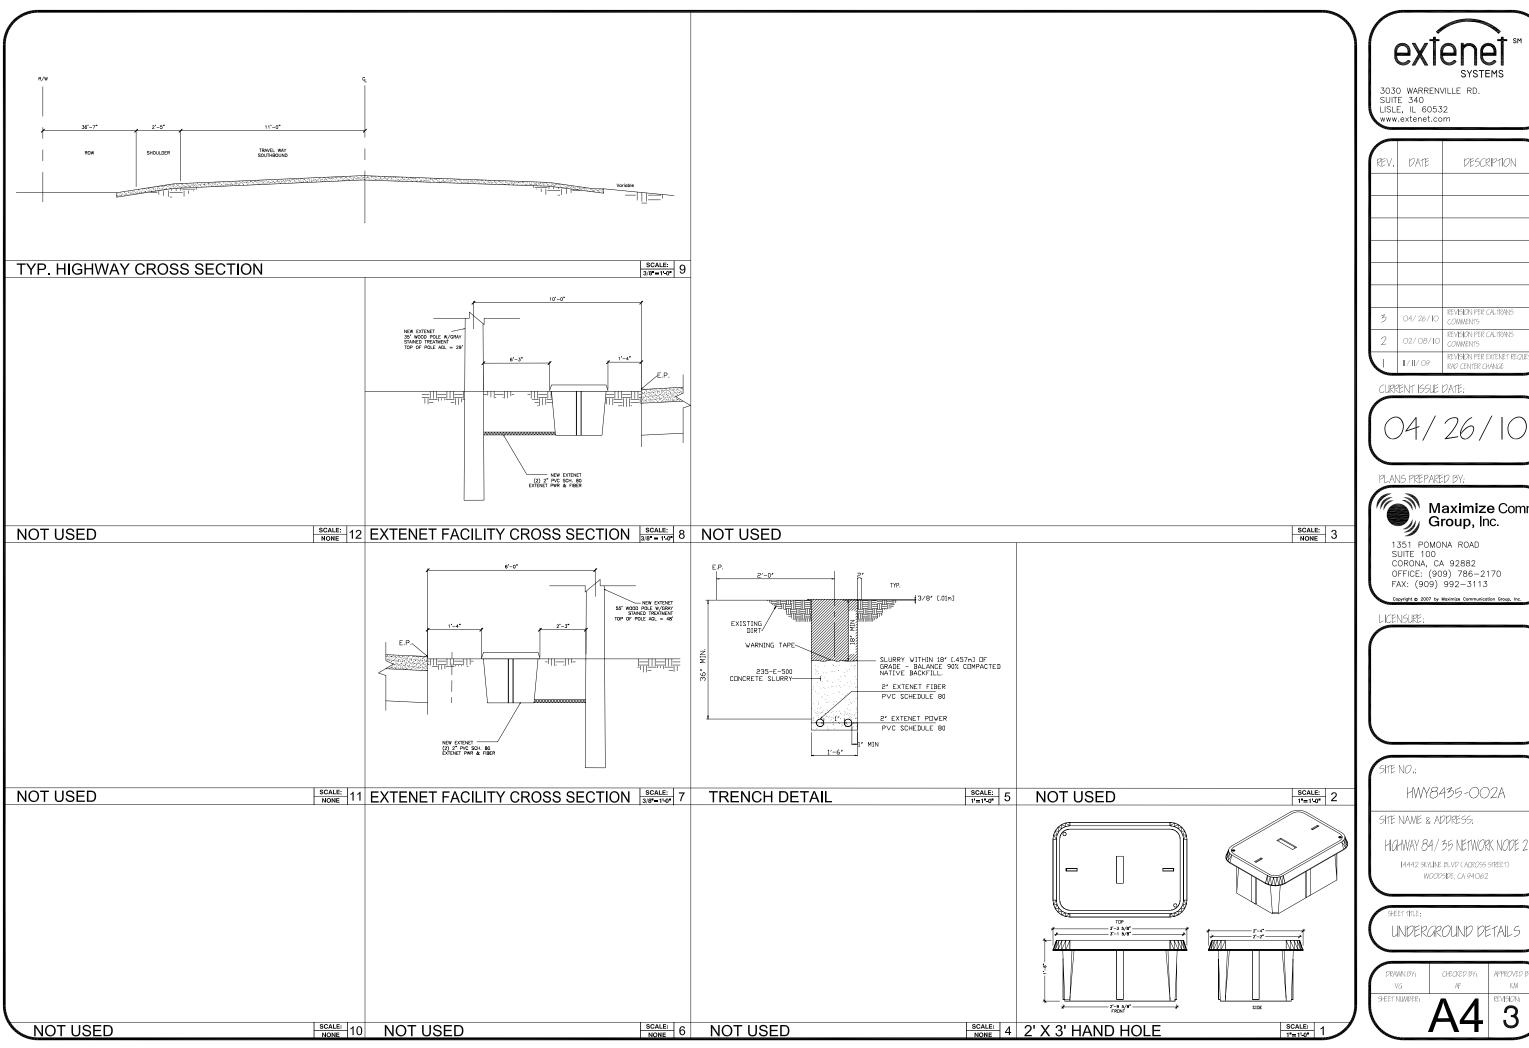
HIGHWAY 84/35 NETWORK NODE 2

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AERIAL DETAILS

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L	DRAWN BY: VG	CHECKED BY: AF	APPROVED BY





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UNDERGROUND DETAILS

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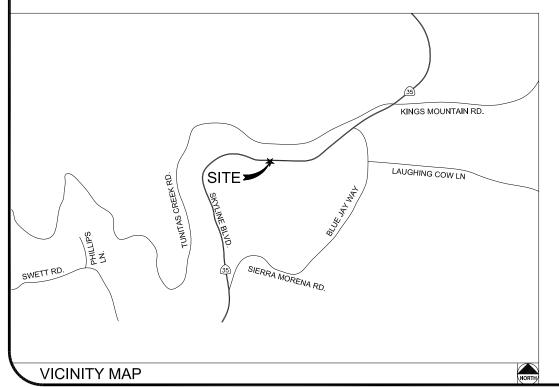


HWY 35- PROJECT

HWY8435 - 003A

POST MILE MARKER 15.91

14600 SKYLINE BLVD. (ACROSS STREET) WOODSIDE, CA 94062



CLIENT

EXTENET SYSTEMS, INC. 3030 WARRENVILLE RD. SUITE 340 LISLE, IL 60532 CONTACT JEFF FRYE PHONE 480-626-1271 FAX 504-285-1603

ENGINEERING FIRM/SURVEYING

MAXIMIZE COMMUNICATION GROUP, INC. 1351 POMONA ROAD SUITE 100 CORONA, CA 92882 CONTACT KELLI MCCABE PHONE 909-786-2170 FAX 909-992-3113

COORDINATES

CODE COMPLIANCE:

ALL WORK AND MATERIALS SHALL BE PERFORMED & INSTALLED IN ACCORDANCE WITH THE CURRENT EDITIONS OF THE FOLLOWING CODES AS ADOPTED BY LOCAL GOVERNING AUTHORITIES AND LOCAL/CITY/COUNTY ORDINANCES:

1. CALIFORNIA ADMINISTRATIVE CODE (INCLUDING TITLE 24 &

- 3. 2007 CALIFORNIA ELECTRICAL CODE.
- 3. BUILDING OFFICIALS AND CODE ADMINISTRATORS (BOCA).
- 4. UNIFORM PLUMBING & MECHANICAL CODES.
- 5. ANSI/EIA-222-F LIFE SAFETY CODE
- 6. CALIFORNIA GENERAL ORDER 95, 128 & 165.

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SHEET	DESCRIPTION
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3030 WARRENVILLE RD. SUITE 340 LISLE, IL 60532 www.extenet.com

		Stra-
REV.	DATE	DESCRIPTION
2	02/08/10	REVISION PER CALTRANS COMMENTS
	11/11/09	REVISION PER EXTENET REQUESTED RAD CENTER CHANGE

CURRENT ISSUE DATE:





CORONA, CA 92882 OFFICE: (909) 786-2170 FAX: (909) 992-3113

LICENSURE:	100
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HWY8435-003A


SITE NAME & ADDRESS:

HIGHWAY 84/35 NETWORK NODE 003

14600 SKYLINE BLVD. WOODSIDE CA 94062

TITLE SHEET

DRAWN BY:	CHECKED BY:	APPROVED BY
MG	AF	KM
SHEET NUMBER:		REVISION:

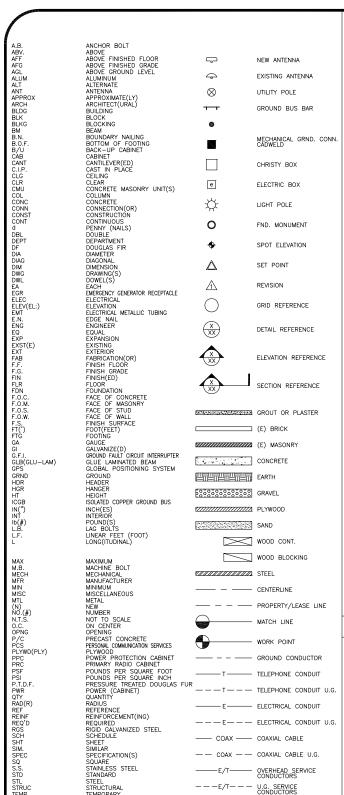

1. THE CONTRACTOR SHALL BE RESPONSIBLE FOR SURVEY MONUMENTS AND/OR VERTICAL CONTROL BENCHMARKS WHICH ARE DISTURBED OR DESTROYED BY CONSTRUCTION. A LAND SURVEYOR MUST FIELD LOCATE, REFERENCE, AND/OR PRESERVE ALL HISTORICAL OR CONTROLLING MONUMENTS PROR TO ANY EARTHWORK. IF DESTROYED, SUCH MONUMENTS SHALL BE REPLACED WITH APPROPRIATE MONUMENTS BY A LAND SURVEYOR. A CORNER RECORD OR RECORD OF SURVEY, AS APPROPRIATE, SHALL BE FILED AS REQUIRED BY THE PROPERSYMMENT AUMS SURVEYOR.

PORTANT NOTICE: SECTION 4215 OF THE GOVERNMENT CODE REQUIRES A DIG ALERT IDENTIFICATIO NUMBER BE ISSUED BEFORE A "PERMT TO EXCAVATE" WILL BE VALID. FOR YOUR DIG ALERT I.D. NUMBER, CALL UNDERGROUND SERVICE ALERT, TOLL FREE 1-800-422-4133, TWO DAYS BEFORE YOU DIG.

CROSS THE PROPOSED TRENCH LINE AND MUST MAINTAIN A 1' MINIMUM VERTICAL CLEARANCE.

4. IF ANY EXISTING HARDSCAPE OR LANDSCAPE INDICATED ON THE APPROVE PLANS IS DAMAGED OR REMOVED DURING DEMOLITION OR CONSTRUCTION, IT SHALL BE REPAIRED AND/OR REPLACED IN KIND PER THE APPROVED PLANS.

5. CONTRACTOR SHALL REPLACE OR REPAIR ALL TRAFFIC SIGNAL LOOPS, CONDUIT, AND LANE STRIPING DAMAGED DURING CONSTRUCTION.

6. THIS PROJECT WILL BE INSPECTED BY ENGINEERING AND FIELD ENGINEERING DIVISION

7. MANHOLES OR COVERS SHALL BE LABELED EXTENET

8. CONTRACTOR SHALL IMPLEMENT AN EROSION CONTROL PROGRAM DURING THE PROJECT CONSTRUCTION ACTIVITIES. THE PROGRAM SHALL MEET THE APPLICABLE REQUIREMENTS OF THE STATE WATER RESOURCE CONTROL

9. THE CONTRACTOR SHALL HAVE EMERGENCY MATERIALS AND EQUIPMENT ON HAND FOR UNFORESEEN SITUATIONS, SUCH AS DAMAGE TO UNDERGROUND WATER, SEWER, AND STORM DRAIN FACILITIES WHEREBY FLOWS MAY GENERATE EROSION AND SEDIMENT POLLUTION.

USA North

 INDEMNIFICATION CLAUSE: THE CONTRACTOR AGREES AND SHALL:
 ASSUME SOLE AND COMPLETE RESPONSIBILITY OF THE JOB SITE CONDITIONS DURING THE COURSE OF
 CONSTRUCTION OF THIS PROJECT, INCLUDING THE SAFETY OF ALL PERSONS AND PROPERTIES. THAT THESE
 REQUIREMENTS SHALL APPLY CONTINUOUSLY AND NOT BE LIMITED TO NORMAL WORKING HOURS AND CONDITIONS.
 THE CONTRACTOR FURTHER AGREES TO DETEND INDEMNITY AND HOLD EXTENT, REPRESENTATIVES, AND ENGINEERS HARMLESS FROM ANY AND ALL LIABILITY, REAL OR ALLEGED IN CONNECTION WITH THE PERFORMANCE

2. PRIOR TO THE BEGINNING OF ANY CONSTRUCTION AND THROUGHOUT THE COURSE OF CONSTRUCTION WORK. THE CONTRACTOR SHALL FULLY COMPLY WITH "CALIFORNIA OCCUPATIONAL SAFETY AND HEALTH" ACT OF 1973 INCLUDING ALL REVISIONS AND AMENDMENTS THERETO.

3. ALL WORK SHALL CONFORM TO THE LATEST EDITIONS OF G095,128 AND THE STANDARD "SPECIFICATIONS FOR PUBLIC WORKS CONSTRUCTION" AS ADOPTED BY THE CITY, COUNTY OR STATE AS MODIFIED BY STANDARD PLANS

4. THE EXISTENCE AND LOCATION OF UTILITIES AND OTHER AGENCY'S FACILITIES AS SHOWN HERON ARE OBJUSTED BY A SEARCH OF AVAILABLE RECORDS. OTHER FACILITIES MAY EXIST. THE CONTRACTOR SHALL VERIFY PRIOR TO THE START OF CONSTRUCTION AND SHALL USE EXTREME, CARE AND PROTICETIVE MEASURES TO PREVENT DAMAGE TO THESE FACILITIES. THE CONTRACTOR IS RESPONSIBLE FOR THE PROTECTION OF ALL UTILITY OR AGENCY FACILITIES WITHIN THE LIMITS OF WORK, WHETHER THEY ARE SHOWN ON THIS PLAN OR NOT.

5. THE CONTRACTOR SHALL NOTIFY THE CITY, COUNTY OR STATE ENGINEER INSPECTION DEPARTMENT, AT LEAST TWO DAYS BEFORE START OF ANY WORK REQUIRING THEIR INVOLVEMENT.

 $6.\,$ The City, county or state shall specify the expiration period of the permit for this construction project.

7. THE MINIMUM COVER FOR ALL CONDUITS PLACED UNDERGROUND SHALL BE 36 INCHES TO THE FINISHED GRADE AT ALL TIMES.

8. THE CONTRACTOR SHALL TUNNEL ALL CURB AND GUTTERS AND BORE ALL CONCRETE DRIVEWAYS AND WALKWAYS AT THE DIRECTION OF THE CITY, COUNTY OR STATE ENGINEER.

9. ALL A.C AND/OR CONCRETE PAVEMENT SHALL BE REPLACED AT THE DIRECTION OF THE CITY, COUNTY OR STATE ENGINEERS.

WORK, SHALL BE REPLANTED AND/OR REPLACED SO AS TO RESTORE THE WORK SITE TO ITS ORIGINAL CONDITION

11. THE CONTRACTOR WILL BE RESPONSIBLE FOR THE PROCESSING OF ALL APPLICANT PERMIT FORMS ALONG WITH THE REQUIRED LIABILITY INSURANCE FORMS. CLEARLY DEMONSTRATING THAT EXTENET, THE CITY, COUNTY OR STATE IS ALSO INSURED WITH THE REQUIRED LIABILITY INSURANCE IN THE AMOUNT OF \$1,000,000.00 FOR THIS

VAULTS, PEDESTALS, CONDUITS AND OTHER TYPES OF SUBSTRUCTURE ARE EITHER SPECIFIED ON THIS PLAN OR WILL BE SPECIFIED BY THE CONSTRUCTION ENGINEER, ANY AND ALL DEVIATIONS FROM THE SPECIFIED TYPES OF MATERIAL MUST BE APPROVED BY THE SYSTEM ENGINEER, IN WRITING BEFORE INSTALLATION THEREOF.

13. THE CONTRACTOR SHALL VERIFY THE LOCATION OF ALL EXISTING UTILITIES IN INCLUDING SEWER LATERALS & WATER SERVICES TO INDIVIDUAL LOTS BOTH VERTICAL AND HORIZONTAL PRIOR TO COMMENCING IMPROVEMENT

14. CONTRACTOR SHALL MAKE EXPLORATION EXCAVATIONS AND LOCATE EXISTING FACILITIES SUFFICIENTLY AHEAD OF CONSTRUCTION TO PERMIT REVISIONS TO PLANS IF REVISION IS NECESSARY BECAUSE OF LOCATION OF

15. THE LOCATIONS OF ALL EXISTING UTILITIES SHOWN ON THESE PLANS ARE FROM EXISTING RECORDS AND CORROBORATED, WHERE POSSIBLE, WITH FIELD TIES. THE CONTRACTOR IS RESPONSIBLE FOR CONFIRMING THE LOCATIONS SHOWN, BOTH HORIZONIAL AND VERTICALLY. PRIOR TO CONSTRUCTION, IF EXISTING LOCATIONS VAR SUBSTANTIALLY FROM THE PLANS. THE ENGINEER SHOULD BE NOTIFIED TO MAKE ANY CONSTRUCTION CHANGES

EROSION AND SEDIMENT CONTROL NOTES

TEMPORARY EROSION/SEDIMENT CONTROL PRIOR TO COMPLETION OF FINAL IMPROVEMENTS, SHALL BE PERFORMED BY THE CONTRACTOR OR QUALIFIED PERSON AS INDICATED BELOW:

1. ALL REQUIREMENTS OF THE CITY, COUNTY AND STATE "STORM WATER STANDARDS" MUST BE INCORPORATED INTO THE DESIGN AND CONSTRUCTION OF THE PROPOSED GRADING/IMPROVMENTS CONSISTENT WITH THE APPROVED STORM WATER POLLUTION PREVENTION PLAN (SWPPP), WATER QUALITY TECHNICAL REPORT (WQTR), AND/OR WATER POLLUTION CONTROL PLAN (WPCP).

2. FOR STORM DRAIN INLETS, PROVIDE A GRAVEL BAG SILT BASIN IMMEDIATELY UPSTREAM OF INLET AS INDICATED ON DETAILS.

3. FOR INLETS LOCATED AT SUMPS ADJACENT TO TOP OF SLOPES, THE CONTRACTOR SHALL ENSURE THAT WATER DRAINING TO THE SUMP IS DIRECTED INTO THE INLET AND THAT A MINIMUM OF 1.00' FREEBOARD EXISTS AND IS MAINTAINED ABOVE THE TOP OF THE INLET. IF FREEBOARD IS NOT PROVIDED BY GRADIOS SHOWN ON THESE PLANS THE CONTRACTOR SHALL PROVIDE IT VIA TEMPORARY MEASURES, I.E. GRAVEL BAGS OR DIKES.

4. THE CONTRACTOR OR QUALIFIED PERSON SHALL BE RESPONSIBLE FOR CLEANUP OF SILT AND MUD ON ADJACENT STREET(S) AND STORM DRAIN SYSTEM DUE TO CONSTRUCTION ACTIVITY.

5. THE CONTRACTOR OR QUALIFIED PERSON SHALL CHECK AND MAINTAIN ALL LINED AND UNLINED DITCHES AFTER EACH RAINFALL.

6. THE CONTRACTOR SHALL REMOVE SILT AND DEBRIS AFTER EACH MAJOR RAINFALL

B. THE CONTRACTOR SHALL RESTORE ALL EROSION/SEDIMENT CONTROL DEVICES TO WORKING ORDER TO THE SATISFACTION OF THE CITY ENGINEER OF RESIDENT ENGINEER AFTER EACH RUN-OFF PRODUCING RAINFALL.

9. THE CONTRACTOR SHALL INSTALL ADDITIONAL EROSION/SEDIMENT CONTROL MEASURES AS MAY BE REQUIRED BY THE RESIDENT ENGINEER DUE TO UNCOMPLETED GRADING OPERATIONS OR UNFORESEEN CIRCUMSTANCES,

10. THE CONTRACTOR SHALL BE RESPONSIBLE AND SHALL TAKE NECESSARY PRECAUTIONS TO PREVENT PUBLIC TRESPASS ONTO AREAS WHERE IMPOUNDED WATERS CREATE A HAZARDOUS CONDITION.

11. ALL EROSION/SEDIMENT CONTROL MEASURES PROVIDED PER THE APPROVED GRADING PLAN SHALL BE INCORPORATED HERON. ALL EROSION/SEDIMENT CONTROL FOR INTERIM CONDITIONS SHALL BE DONE TO THE SATISFACTION OF THE RESIDENT ENGINEER.

12. GRADED AREAS AROUND THE PROJECT PERIMETER MUST DRAIN AWAY FROM THE FACE OF THE SLOPE AT THE CONCLUSION OF EACH WORKING DAY.

13. ALL REMOVABLE PROTECTIVE DEVICES SHOWN SHALL BE IN PLACE AT THE END OF EACH WORKING DAY WHEN RAIN IS IMMINENT.

14. THE CONTRACTOR SHALL ONLY GRADE, INCLUDING CLEARING AND GRUBBING FOR THE AREAS FOR WHICH THE CONTRACTOR OR QUALIFIED PERSON CAN PROVIDE EROSION/SEDIMENT CONTROL MEASURES.

15. THE CONTRACTOR SHALL ARRANGE FOR WEEKLY MEETINGS DURING OCTOBER 1ST TO APRIL 30TH FOR PROJECT FEAM (GENERAL CONTRACTOR, QUALIFIED PERSON, EROSION CONTROL SUBCONTRACTOR IF AN, ENGINEER OF WORK, OWNER/DEVELOPER AND THE RESIDENT ENGINEER) TO EVALUATE THE ADEQUACY OF THE EROSION/SEDIMENT CONTROL MEASURE AND OTHER RELATED CONSTRUCTION ACTIVITIES.

ANTENNA & CABLE SCHEDULE

MAKE / MODEL

840 21410

KATHREIN

3030 WARRENVILLE RD. LISLE, IL 60532 www.extenet.com

A SECOND		
REV.	DATE	DESCRIPTION
2	02/08/10	REVISION PER CALTRANS COMMENTS
	11/11/09	REVISION PER EXTENET REQUESTED RAD CENTER CHANGE
		2 02/08/10



1351 POMONA ROAD SUITE 100 CORONA, CA 92882 OFFICE: (909) 786-2170 FAX: (909) 992-3113

2

CABLE SIZE

1/2"

1/2"

2

2

32'-11

HWY8435-003A

SITE NAME & ADDRESS:

11GHWAY 84/35 NE1WORK NODE 003*F*

14600 SKYLINE BLVD. WOODSIDE CA 94062

IENERAL NOTES & SCHEDULE

KM SHEET NUMBER EVISION: 2

Call Before you Dlg! 1-800-227-2600

GENERAL NOTES

1. 120/240 POWER REQUIRED FOR 3-WIRE SERVICE.
 2. GC TO REMOVE/CLEAN ALL DEBRIS, NAILS, STAPLES, OR NON-USED VERTICALS OFF THE POLE.

HE POLE.
ALL CONSTRUCTION SHALL BE IN ACCORDANCE WITH MUNICIPAL, COUNTY, STATE,
FEDERAL, GOSS AND GO128 STANDARDS AND REGULATIONS.
CALL USA 48 HOURS PRIOR TO EXCAVATING AT (80) 422-4133.
ALL LANDSCAPING TO BE RESTORED TO ORIGINAL CONDITION OR BETTER.
ALL EQUIPMENT TO BE BONDED.

7. METERING CABINET REQUIRES 3'[.914M] CLEARANCE AT DOOR OPENING. 8. CAULK CABINET BASE AT PAD.

STANDARD GROUNDING NOTES:

5/8"x8"[.016x2.44M] ROD, CAD WELD BELOW GRADE

#6 GROUND AND BOND WIRE . WOOD MOLDING, STAPLED EVERY 3'[.914M] AND AT EACH END

3. PLACE 3 #10GA WIRES FROM BREAKER TO METER BOX.

STANDARD CONDUIT NOTES:

1. FOR UNDERGROUND USE SCHEDULE 40.
2. FOR RISERS USE SCHEDULE 80.
3. PLACE 2"[.051M] GALVANIZED STEEL CONDUIT FOR ANY CONDUIT UNDER 3"[.076M], STUB UP 10"[3.04M] THEN CONVERT TO SCHEDULE 80.
4. CONVERT 4"[.102M] CARRIER CONDUIT TO 3"[.076M] AT BASE OF POLE.
5. GC TO STUB UP POLE 10"[3.04M] w/3" POWER CONDUIT, POWER CO. TO CONVERT TROM 3"[.076M] SCH. 80 TO 2"[.051M] SCH. 80 FROM TOP OF STUB UP.

ALL CONDUIT WILL BE MAN DRILLED AND EQUIPPED WITH 3/8"[.010M] PULL ROPE.

MAINTAIN 40"[1.02M] MINIMUM COVER FOR ELECTRICAL CONDUIT.
 MAINTAIN 30"[1.762M] MINIMUM COVER FOR COMMUNICATIONS CONDUIT.
 SAND SHADING MINIMUM 1"[0.025M] UNDER CONDUITS, AND 6"[1.152M] COVERING ON TOP REQUIRED.
 ALL ELECTRICAL SERVICE CONDUITS FROM POWER COMPANY, WHETHER FROM POLES, TRANSFORMERS, OR OTHER LOCATIONS; WILL BE SLURRY BACKFILLED.

5. IN STREET SLURRY TO GRADE AND MILL DOWN 1-1/2"[.038M] FOR AC CAP.
6. IN DIRT SLURRY 18"[.457M] FROM GRADE, AND FILL WITH 95% COMPACTION NATIVE SOLI FOR BALANCE.

PLACE WARNING TAPE IN TRENCH 12"[.305M] ABOVE ALL CONDUITS AND #18 WARNING TAPE ABOVE GROUND RING.

. NO BOLT THREADS TO PROTRUDE MORE THAN 1-1/2"[.038M]. . FILL ALL HOLES LEFT IN POLE FROM REARRANGEMENT OF CLIMBERS.

 ALL CLIMB STEPS NEXT TO CONDUIT SHALL HAVE EXTENDED STEPS. 4. CABLE NOT TO IMPEDE 15"[.381M] CLEAR SPACE OFF POLE FACE

4. CABLE NOT TO IMPEDE 151_ASTM] CLEAR SPACE OFF POLE FACE (12:00).
5. 90' SHORT SWEEPS UNDER ANTENNA ARM. ALL CABLES MUST ONLY TRANSITION ON THE INSIDE OR BOTTOM OF ARMS (NO CABLE ON TOP OF ARMS).
6. USE CABLE CLAMPS TO SECURE CABLE TO ARMS; PLACE 2"[0.51 M] CARRIER CABLE ID TAGS ON BOTH SIDES OF ARMS.
7. USE 90' CONNECTOR AT CABLE CONNECTION TO ANTENNAS.
8. PLACE GPS ON ARM WITH SOUTHERN SYE EXPOSURE AT MINIMUM. S'[1.83M] FROM TRANSMIT ANTENNA, WHICH IS 24"[.61M] AWAY FROM CENTER OF POLE.

USE 1/2"[.013M] CABLE ON ANTENNAS UNLESS OTHERWISE
 SPECIFIED

FILL VOID AROUND CABLES AT CONDUIT OPENING WITH FOAM SEALANT TO PREVENT WATER INTRUSION.

1ST ANTENNA/WOOD ARM AREA TOTAL	77.48 SQ. FT.	
TOP GRADE	45'-4"	
BOTTOM GRADE	41'-0"	
2ND ANTENNA/WOOD ARM AREA TOTAL	77.48 SQ. FT.	
TOP GRADE	38'-0"	
BOTTOM GRADE	33'-8"	
METER/BREAKER AREA TOTAL	4.33 SQ. FT.	
TOP GRADE	8'-0"	
BOTTOM GRADE	7'-0*	
BATTERY BACK-UP AREA TOTAL	16.25 SQ. FT.	
TOP GRADE	11'-8"	
BOTTOM GRADE	9'-6"	
DELTA DECK AREA TOTAL	10.74 SQ. FT.	
TOP GRADE	14'-7"	
BOTTOM GRADE	12'-5"	
DELTA DECK (FUT.) AREA TOTAL	10.74 SQ. FT.	
TOP GRADE	17'-6"	
BOTTOM GRADE	15'-4"	
EXT. RISER SIZE	4 " ø	
EXT. RISER LENGTH	13'-11"	
EXT. RISER BTM GRADE	15'-8"	
PWR RISER SIZE	1 " ø	
PWR RISER LENGTH	28'-4"	
PWR RISER BTM GRADE	8'-7"	

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WIND LOADING INFORMATION

LOADING AND ANTENNA CABLE SCHEDULES

ANTENNA SECTOR

AI PHA


SECTOR

AZIMUTH

THICK(NESS)

WOOD

TOP OF FOOTING
TOP OF PLATE (PARAPET)
TOP OF STEEL (SLAB)
TOP OF WALL
TYPICAL
UNDER GROUND
UNDERWRITERS LABORATORY
UNLESS NOTED OTHERWISE
VERIFY IN FIELD
WITH
WITH
WOOD

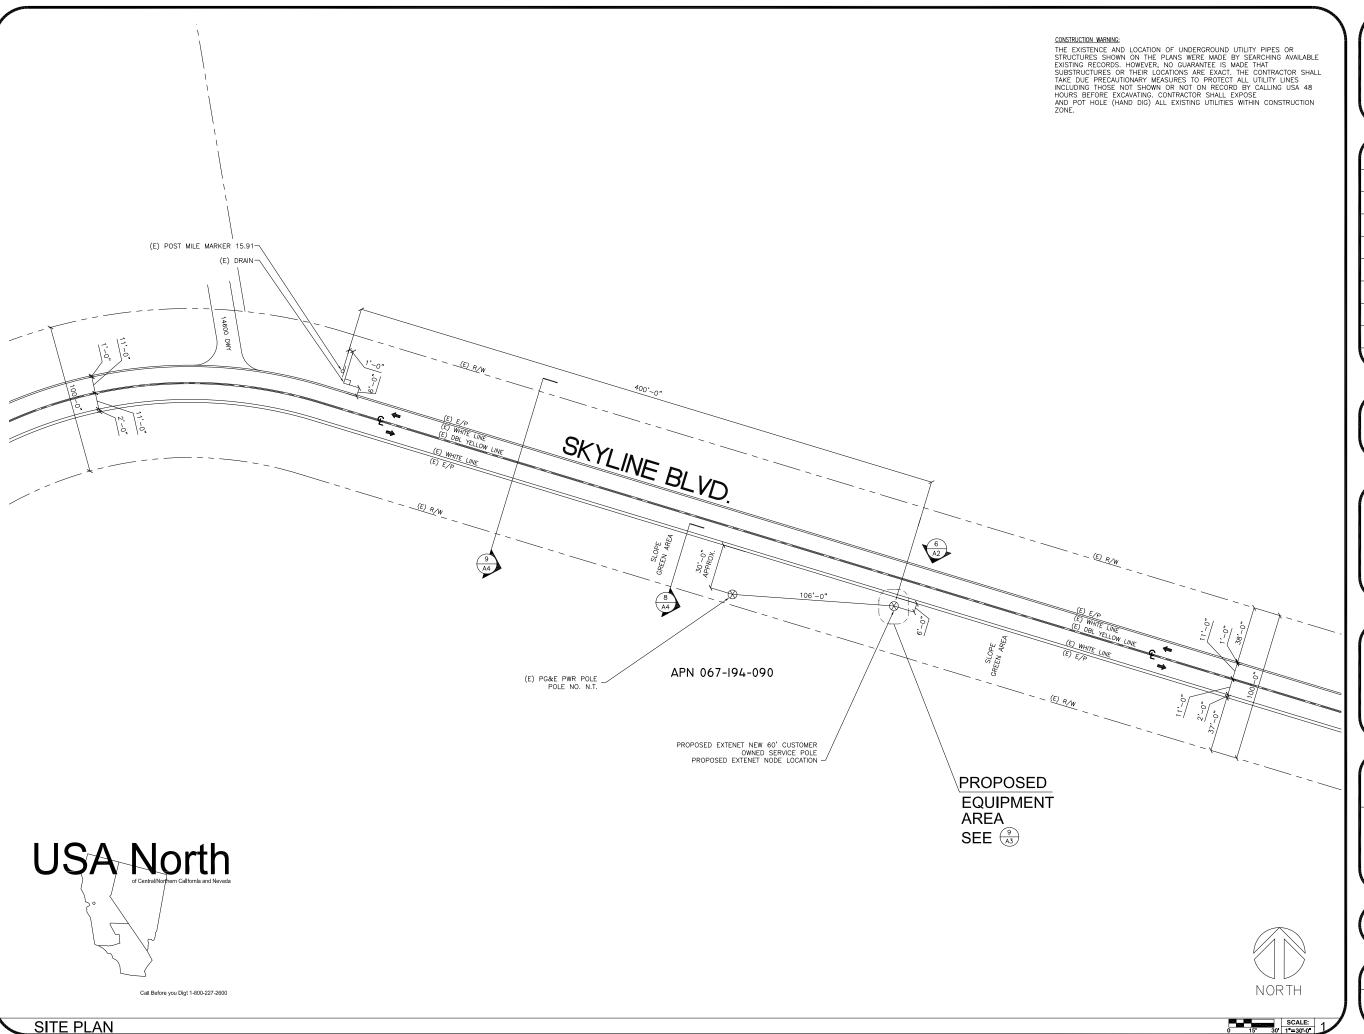



REV.	DATE	DESCRIPTION
2	02/08/10	REVISION PER CALTRANS COMMENTS
	11/11/09	REVISION PER EXTENET REQUESTED RAD CENTER CHANGE

CURRENT ISSUE DATE:

02/08/10

PLANS PREPARED BY:



1351 POMONA ROAD SUITE 100 CORONA, CA 92882 OFFICE: (909) 786-2170 FAX: (909) 992-3113

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LICENSURE:

LIGENDURE:

1 SILL NO

HWY8435-003A

SITE NAME & ADDRESS:

HIGHWAY 84/35 NETWORK NODE 003A

14600 SKYLINE BLVD. WOODSIDE, CA 94062

SHEET 111

SITE PLAN

PRAWN BY: CHECKED BY: APPROVED BY: KM
SHEET NUMBER: AT REVISION: 2

EXTENET MAKE-READY

- 1. INSTALL NEW 45' CLASS 2 NODE POLE IN ROW (SEE SITE PLAN FOR LOCATION) POLE IS CUSTOMER OWNED POLE.
- 2. FLUSH MOUNT TOP OF ANTENNA AT 32'-2" GRADE, (2) 51" PANEL ANT. (KATHREIN 742 222) 3. FLUSH MOUNT (2ND) TOP OF ANTENNA AT 26'-10"
- (2) 51' PANEL ANTÉNNA (KATHREIN 840 21410)
- 4. INSTALL EXTENET NODE EQUIPMENT AND METER/BREAKER TO STAND-OFF BRACKET (4" OFF OF POLE) AT THE 3:00 POSITION

MAKE-READY NOTES

(BETWEEN QUAD. 3-4)
5. INSTALL 4" EXT CONDUIT AT 2:00 POSITION
6. STRING IN EXTENET FIBER AND ATTACH PER FIBER

POWER MAKE-READY

- 1. PG&E TO STRING IN SECONDARY POWER AT 51'-0" GRADE TO EXTENET NODE POLE IN ROW APPROX 106' EAST OF PG&E POLE LOCATION. (SEE SITE PLAN FOR
- LOCATION)
 2. INSTALL 1" PG&E SCH. 80 CONDUIT AT 1:00 (QUAD
- 4) POSITION (WITH WEATHER HEAD)

 3. PROVIDE 120/240 3-WIRE SINGLE PHASE, 100 AMP SERVICE TO 1" PG&E CONDUIT TO EXTENET METER BOX FROM SECONDARY AT 51'-0" GRADE.




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FOC/EF

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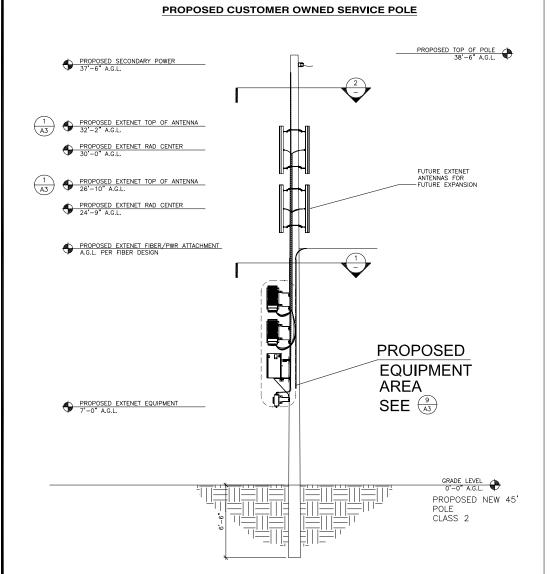
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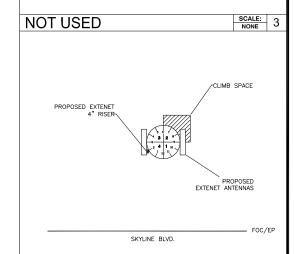
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WOODSIDE, CA 94062


LEVATIONS & RISER DETAIL

DRAWN BY: MG	CHECKED BY: AF	APPROVED BY
SHEET NUMBER:	A 0	REVISION:



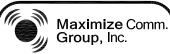

COMMUNICATION SPACE PLAN VIEW SCALE: 2

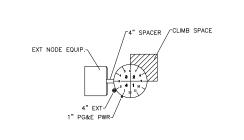


SKYLINE BLVD.

SCALE: 5 EQUIP. SPACE PLAN VIEW SCALE: 1

NOT USED

PROPOSED ELEVATION NORTH

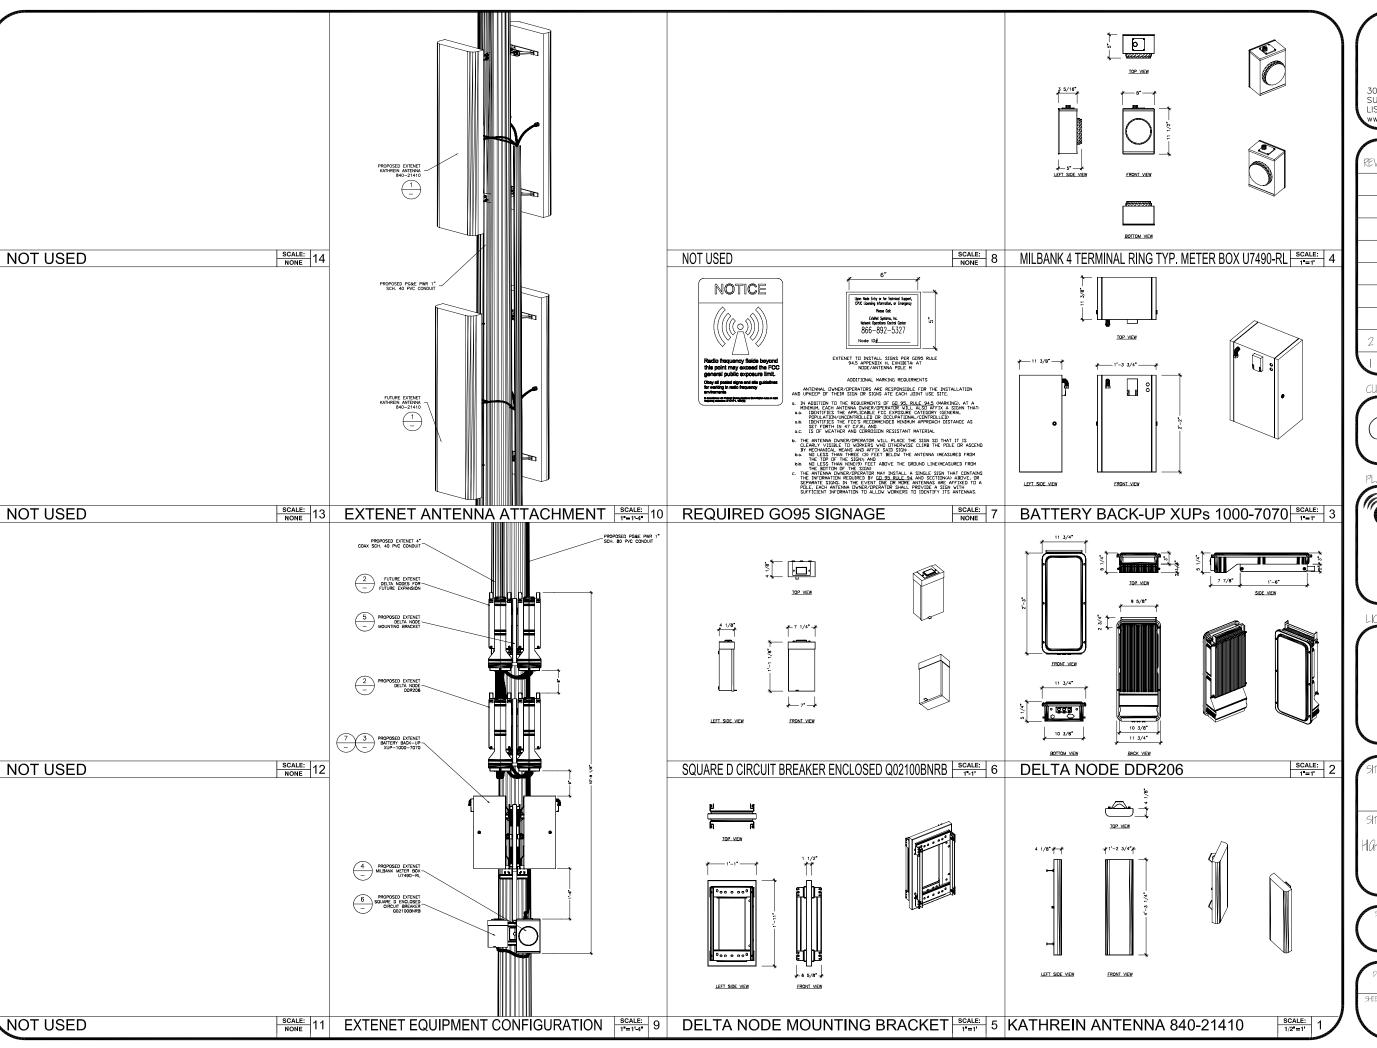



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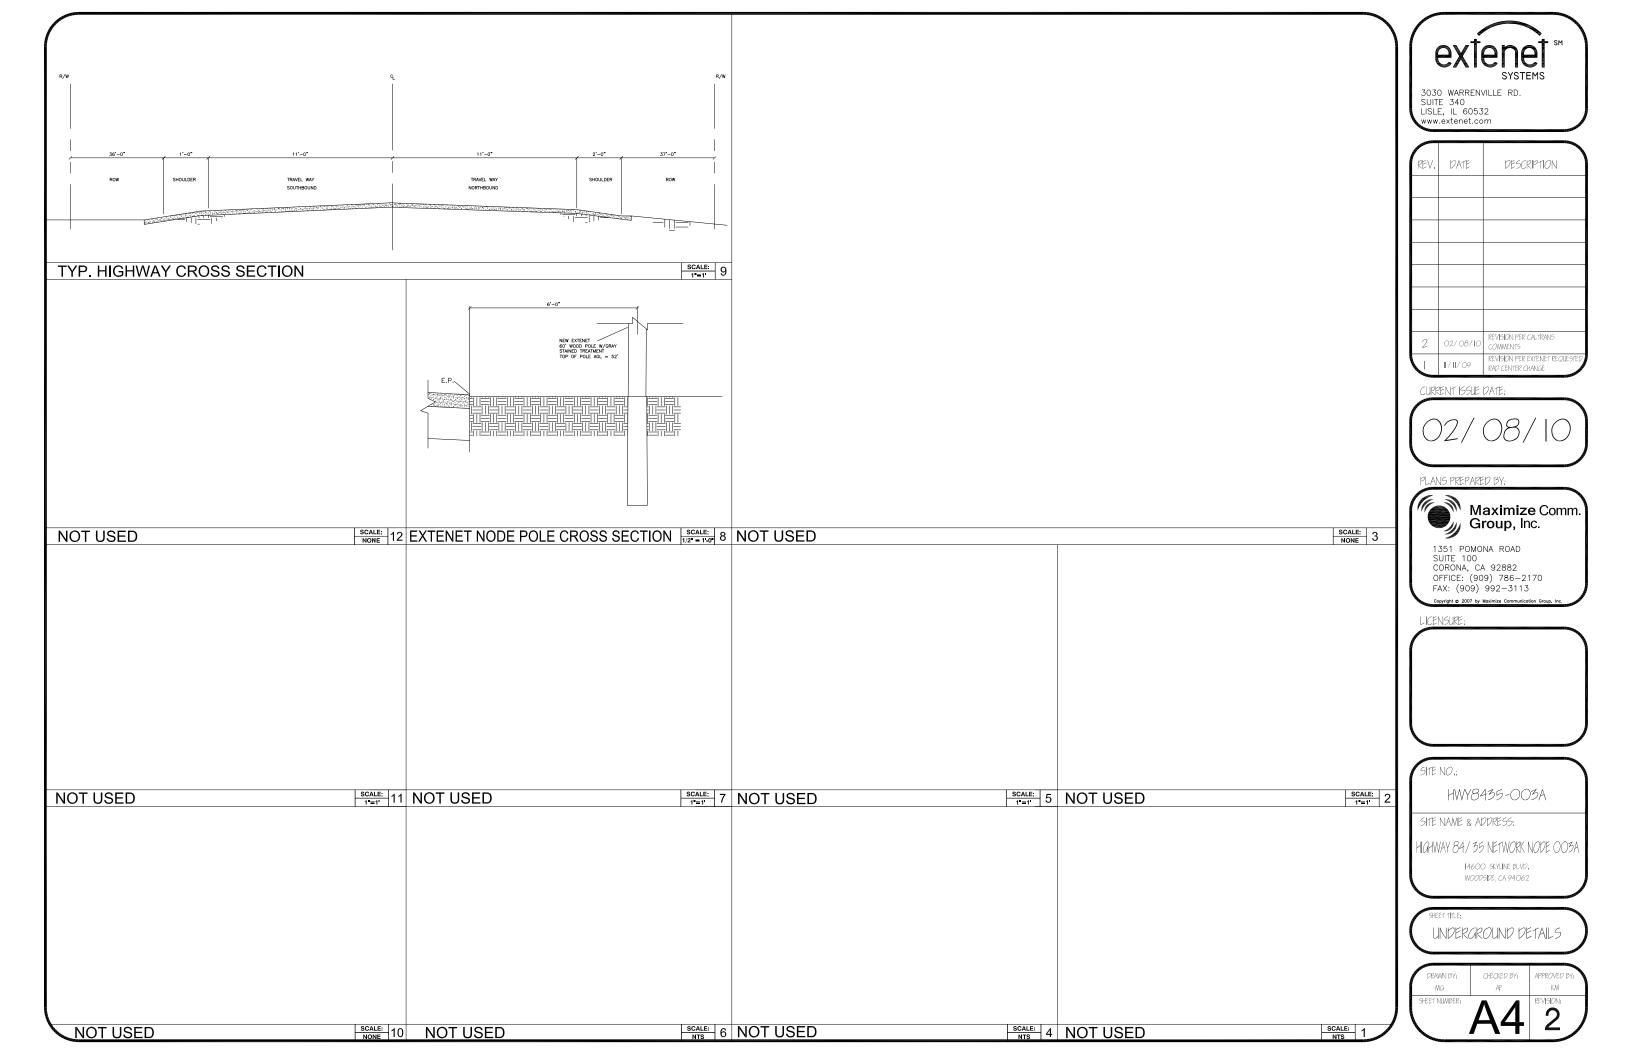
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SHEET 11T


AERIAL DETAILS

DRAWN BY: MG	CHECKED BY: AF	APPROVED BY:
SHEET NUMBER:	^	REVISION:





HWY 35 - PROJECT HWY8435 - 004A POST MILE MARKER 15.52 14730 SKYLINE BLVD. WOODSIDE, CA 94062

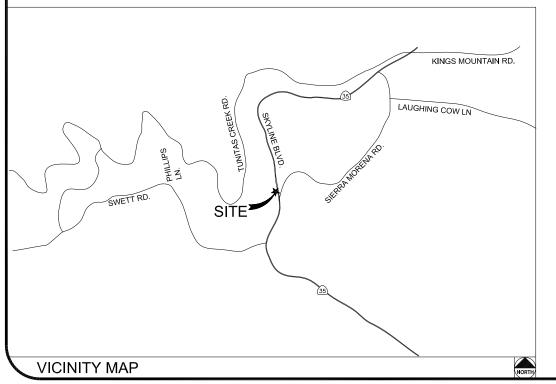

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CHEET INDEX



3030 WARRENVILLE RD. SUITE 340 LISLE, IL 60532 www.extenet.com

REV.	DATE	DESCRIPTION
2	2/08/10	REVISION PER EXTENET REQUESTED RAD CENTER CHANGE
	11/11/09	REVISION PER EXTENET REQUESTED RAD CENTER CHANGE

CURRENT ISSUE DATE:

PLANS PREPARED BY



1351 POMONA ROAD SUITE 100 CORONA, CA 92882 OFFICE: (909) 786-2170 FAX: (909) 992-3113

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No.	

HWY8435-004A

SITE NAME & ADDRESS:

11GHWAY 84/35 NETWORK NODE 004/

WOODSIDE CA 94062

111LE SHEET

	CHECKED BY:	APPROVED BY
MG	AF	KM
SHEET NUMBER		REVISION:



TOP OF FOOTING
TOP OF PLATE (PARAPET)
TOP OF STEEL (SLAB)
TOP OF WALL
TYPICAL
UNDER GROUND
UNDERWRITERS LABORATORY
UNLESS NOTED OTHERWISE
VERIFY IN FIELD
WITH
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WOOD

WOOD

1. THE CONTRACTOR SHALL BE RESPONSIBLE FOR SURVEY MONUMENTS AND/OR VERTICAL CONTROL BENCHMARKS WHICH ARE DISTURBED OR DESTROYED BY CONSTRUCTION. A LAND SURVEYOR MUST FIELD LOCATE, REFERENCE, AND/OR PRESERVE ALL HISTORICAL OR CONTROLLING MONUMENTS PROR TO ANY EARTHWORK. IF DESTROYED, SUCH MONUMENTS SHALL BE REPLACED WITH APPROPRIATE MONUMENTS BY A LAND SURVEYOR. A CORNER RECORD OR RECORD OF SURVEY, AS APPROPRIATE, SHALL BE FILED AS REQUIRED BY THE PROPERSYMMENT AUMS SURVEYOR.

PORTANT NOTICE: SECTION 4215 OF THE GOVERNMENT CODE REQUIRES A DIG ALERT IDENTIFICATIO NUMBER BE ISSUED BEFORE A "PERMT TO EXCAVATE" WILL BE VALID. FOR YOUR DIG ALERT I.D. NUMBER, CALL UNDERGROUND SERVICE ALERT, TOLL FREE 1-800-422-4133, TWO DAYS BEFORE YOU DIG.

CROSS THE PROPOSED TRENCH LINE AND MUST MAINTAIN A 1' MINIMUM VERTICAL CLEARANCE.

4. IF ANY EXISTING HARDSCAPE OR LANDSCAPE INDICATED ON THE APPROVE PLANS IS DAMAGED OR REMOVED DURING DEMOLITION OR CONSTRUCTION, IT SHALL BE REPAIRED AND/OR REPLACED IN KIND PER THE APPROVED PLANS.

5. CONTRACTOR SHALL REPLACE OR REPAIR ALL TRAFFIC SIGNAL LOOPS, CONDUIT, AND LANE STRIPING DAMAGED DURING CONSTRUCTION.

6. THIS PROJECT WILL BE INSPECTED BY ENGINEERING AND FIELD ENGINEERING DIVISION

7. MANHOLES OR COVERS SHALL BE LABELED EXTENET

8. CONTRACTOR SHALL IMPLEMENT AN EROSION CONTROL PROGRAM DURING THE PROJECT CONSTRUCTION ACTIVITIES. THE PROGRAM SHALL MEET THE APPLICABLE REQUIREMENTS OF THE STATE WATER RESOURCE CONTROL

9. THE CONTRACTOR SHALL HAVE EMERGENCY MATERIALS AND EQUIPMENT ON HAND FOR UNFORESEEN SITUATIONS, SUCH AS DAMAGE TO UNDERGROUND WATER, SEWER, AND STORM DRAIN FACILITIES WHEREBY FLOWS MAY GENERATE EROSION AND SEDIMENT POLLUTION.

 INDEMNIFICATION CLAUSE: THE CONTRACTOR AGREES AND SHALL:
 ASSUME SOLE AND COMPLETE RESPONSIBILITY OF THE JOB SITE CONDITIONS DURING THE COURSE OF
 CONSTRUCTION OF THIS PROJECT, INCLUDING THE SAFETY OF ALL PERSONS AND PROPERTIES. THAT THESE
 REQUIREMENTS SHALL APPLY CONTINUOUSLY AND NOT BE LIMITED TO NORMAL WORKING HOURS AND CONDITIONS.
 THE CONTRACTOR FURTHER AGREES TO DETEND INDEMNITY AND HOLD EXTENT, REPRESENTATIVES, AND ENGINEERS HARMLESS FROM ANY AND ALL LIABILITY, REAL OR ALLEGED IN CONNECTION WITH THE PERFORMANCE

2. PRIOR TO THE BEGINNING OF ANY CONSTRUCTION AND THROUGHOUT THE COURSE OF CONSTRUCTION WORK. THE CONTRACTOR SHALL FULLY COMPLY WITH "CALIFORNIA OCCUPATIONAL SAFETY AND HEALTH" ACT OF 1973 INCLUDING ALL REVISIONS AND AMENDMENTS THERETO.

3. ALL WORK SHALL CONFORM TO THE LATEST EDITIONS OF G095,128 AND THE STANDARD "SPECIFICATIONS FOR PUBLIC WORKS CONSTRUCTION" AS ADOPTED BY THE CITY, COUNTY OR STATE AS MODIFIED BY STANDARD PLANS

4. THE EXISTENCE AND LOCATION OF UTILITIES AND OTHER AGENCY'S FACILITIES AS SHOWN HERON ARE OBTAINED BY A SEARCH OF AVAILABLE RECORDS. OTHER FACILITIES MAY SUSTE. THE CONTRACTOR SHALL VERIFY PRIOR TO THE START OF CONSTRUCTION AND SHALL USE EXTREME CARE AND PROTOCTIVE MEASURES TO PREVENT DAMAGE TO THESE FACILITIES. THE CONTRACTOR IS RESPONSIBLE FOR THE PROTECTION OF ALL UTILITY OR AGENCY FACILITIES WITHIN THE LIMITS OF WORK, WHETHER THEY ARE SHOWN ON THIS PLAN OR NOT.

5. THE CONTRACTOR SHALL NOTIFY THE CITY, COUNTY OR STATE ENGINEER INSPECTION DEPARTMENT, AT LEAST TWO DAYS BEFORE START OF ANY WORK REQUIRING THEIR INVOLVEMENT.

 $6.\,$ The City, county or state shall specify the expiration period of the permit for this construction project.

7. THE MINIMUM COVER FOR ALL CONDUITS PLACED UNDERGROUND SHALL BE 36 INCHES TO THE FINISHED GRADE AT ALL TIMES.

8. THE CONTRACTOR SHALL TUNNEL ALL CURB AND GUTTERS AND BORE ALL CONCRETE DRIVEWAYS AND WALKWAYS AT THE DIRECTION OF THE CITY, COUNTY OR STATE ENGINEER.

9. ALL A.C AND/OR CONCRETE PAVEMENT SHALL BE REPLACED AT THE DIRECTION OF THE CITY, COUNTY OR STATE ENGINEERS.

WORK, SHALL BE REPLANTED AND/OR REPLACED SO AS TO RESTORE THE WORK SITE TO ITS ORIGINAL CONDITION

11. THE CONTRACTOR WILL BE RESPONSIBLE FOR THE PROCESSING OF ALL APPLICANT PERMIT FORMS ALONG WITH THE REQUIRED LIABILITY INSURANCE FORMS. CLEARLY DEMONSTRATING THAT EXTENET, THE CITY, COUNTY OR STATE IS ALSO INSURED WITH THE REQUIRED LIABILITY INSURANCE IN THE AMOUNT OF \$1,000,000.00 FOR THIS

VAULTS, PEDESTALS, CONDUITS AND OTHER TYPES OF SUBSTRUCTURE ARE EITHER SPECIFIED ON THIS PLAN OR WILL BE SPECIFIED BY THE CONSTRUCTION ENGINEER, ANY AND ALL DEVIATIONS FROM THE SPECIFIED TYPES OF MATERIAL MUST BE APPROVED BY THE SYSTEM ENGINEER, IN WRITING BEFORE INSTALLATION THEREOF.

13. THE CONTRACTOR SHALL VERIFY THE LOCATION OF ALL EXISTING UTILITIES IN INCLUDING SEWER LATERALS & WATER SERVICES TO INDIVIDUAL LOTS BOTH VERTICAL AND HORIZONTAL PRIOR TO COMMENCING IMPROVEMENT

14. CONTRACTOR SHALL MAKE EXPLORATION EXCAVATIONS AND LOCATE EXISTING FACILITIES SUFFICIENTLY AHEAD OF CONSTRUCTION TO PERMIT REVISIONS TO PLANS IF REVISION IS NECESSARY BECAUSE OF LOCATION OF

15. THE LOCATIONS OF ALL EXISTING UTILITIES SHOWN ON THESE PLANS ARE FROM EXISTING RECORDS AND CORROBORATED, WHERE POSSIBLE, WITH FIELD TIES. THE CONTRACTOR IS RESPONSIBLE FOR CONFIRMING THE LOCATIONS SHOWN, BOTH HORIZONIAL AND VERTICALLY. PRIOR TO CONSTRUCTION, IF EXISTING LOCATIONS VAR SUBSTANTIALLY FROM THE PLANS. THE ENGINEER SHOULD BE NOTIFIED TO MAKE ANY CONSTRUCTION CHANGES

EROSION AND SEDIMENT CONTROL NOTES

TEMPORARY EROSION/SEDIMENT CONTROL PRIOR TO COMPLETION OF FINAL IMPROVEMENTS, SHALL BE PERFORMED BY THE CONTRACTOR OR QUALIFIED PERSON AS INDICATED BELOW:

1. ALL REQUIREMENTS OF THE CITY, COUNTY AND STATE "STORM WATER STANDARDS" MUST BE INCORPORATED INTO THE DESIGN AND CONSTRUCTION OF THE PROPOSED GRADING/IMPROVMENTS CONSISTENT WITH THE APPROVED STORM WATER POLLUTION PREVENTION PLAN (SWPPP), WATER QUALITY TECHNICAL REPORT (WQTR), AND/OR WATER POLLUTION CONTROL PLAN (WPCP).

2. FOR STORM DRAIN INLETS, PROVIDE A GRAVEL BAG SILT BASIN IMMEDIATELY UPSTREAM OF INLET AS INDICATED ON DETAILS.

3. FOR INLETS LOCATED AT SUMPS ADJACENT TO TOP OF SLOPES, THE CONTRACTOR SHALL ENSURE THAT WATER DRAINING TO THE SUMP IS DIRECTED INTO THE INLET AND THAT A MINIMUM OF 1.00' FREEBOARD EXISTS AND IS MAINTAINED ABOVE THE TOP OF THE INLET. IF FREEBOARD IS NOT PROVIDED BY GRADIOS SHOWN ON THESE PLANS THE CONTRACTOR SHALL PROVIDE IT VIA TEMPORARY MEASURES, I.E. GRAVEL BAGS OR DIKES.

4. THE CONTRACTOR OR QUALIFIED PERSON SHALL BE RESPONSIBLE FOR CLEANUP OF SILT AND MUD ON ADJACENT STREET(S) AND STORM DRAIN SYSTEM DUE TO CONSTRUCTION ACTIVITY.

5. THE CONTRACTOR OR QUALIFIED PERSON SHALL CHECK AND MAINTAIN ALL LINED AND UNLINED DITCHES AFTER EACH RAINFALL.

6. THE CONTRACTOR SHALL REMOVE SILT AND DEBRIS AFTER EACH MAJOR RAINFALL

B. THE CONTRACTOR SHALL RESTORE ALL EROSION/SEDIMENT CONTROL DEVICES TO WORKING ORDER TO THE SATISFACTION OF THE CITY ENGINEER OF RESIDENT ENGINEER AFTER EACH RUN-OFF PRODUCING RAINFALL.

9. THE CONTRACTOR SHALL INSTALL ADDITIONAL EROSION/SEDIMENT CONTROL MEASURES AS MAY BE REQUIRED BY THE RESIDENT ENGINEER DUE TO UNCOMPLETED GRADING OPERATIONS OR UNFORESEEN CIRCUMSTANCES,

10. THE CONTRACTOR SHALL BE RESPONSIBLE AND SHALL TAKE NECESSARY PRECAUTIONS TO PREVENT PUBLIC TRESPASS ONTO AREAS WHERE IMPOUNDED WATERS CREATE A HAZARDOUS CONDITION.

11. ALL EROSION/SEDIMENT CONTROL MEASURES PROVIDED PER THE APPROVED GRADING PLAN SHALL BE INCORPORATED HERON. ALL EROSION/SEDIMENT CONTROL FOR INTERIM CONDITIONS SHALL BE DONE TO THE SATISFACTION OF THE RESIDENT ENGINEER.

12. GRADED AREAS AROUND THE PROJECT PERIMETER MUST DRAIN AWAY FROM THE FACE OF THE SLOPE AT THE CONCLUSION OF EACH WORKING DAY.

13. ALL REMOVABLE PROTECTIVE DEVICES SHOWN SHALL BE IN PLACE AT THE END OF EACH WORKING DAY WHEN RAIN IS IMMINENT.

14. THE CONTRACTOR SHALL ONLY GRADE, INCLUDING CLEARING AND GRUBBING FOR THE AREAS FOR WHICH THE CONTRACTOR OR QUALIFIED PERSON CAN PROVIDE EROSION/SEDIMENT CONTROL MEASURES.

15. THE CONTRACTOR SHALL ARRANGE FOR WEEKLY MEETINGS DURING OCTOBER 1ST TO APRIL 30TH FOR PROJECT FEAM (GENERAL CONTRACTOR, QUALIFIED PERSON, EROSION CONTROL SUBCONTRACTOR IF AN, ENGINEER OF WORK, OWNER/DEVELOPER AND THE RESIDENT ENGINEER) TO EVALUATE THE ADEQUACY OF THE EROSION/SEDIMENT CONTROL MEASURE AND OTHER RELATED CONSTRUCTION ACTIVITIES.

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2

GENERAL NOTES

1. 120/240 POWER REQUIRED FOR 3-WIRE SERVICE.
 2. GC TO REMOVE/CLEAN ALL DEBRIS, NAILS, STAPLES, OR NON-USED VERTICALS OFF THE POLE.

Call Before you Dlg! 1-800-227-2600

USA North

THE POLE.

ALL CONSTRUCTION SHALL BE IN ACCORDANCE WITH MUNICIPAL, COUNTY, STATE, FEDERAL, GOS AND GO128 STANDARDS AND REGULATIONS.

CALL USA 48 HOURS PRIOR TO EXCAVATING AT (800) 422-4133.

ALL LANDSCAPING TO BE RESTORED TO ORIGINAL CONDITION OR BETTER.

ALL EQUIPMENT TO BE BONDED.

7. METERING CABINET REQUIRES 3'[.914M] CLEARANCE AT DOOR OPENING. 8. CAULK CABINET BASE AT PAD.

STANDARD GROUNDING NOTES:

5/8"x8"[.016x2.44M] ROD, CAD WELD BELOW GRADE #6 GROUND AND BOND WIRE

. WOOD MOLDING, STAPLED EVERY 3'[.914M] AND AT EACH END

3. PLACE 3 #10GA WIRES FROM BREAKER TO METER BOX.

STANDARD CONDUIT NOTES:

1. FOR UNDERGROUND USE SCHEDULE 40.
2. FOR RISERS USE SCHEDULE 80.
3. PLACE 2"[.051M] GALVANIZED STEEL CONDUIT FOR ANY CONDUIT UNDER 3"[.076M], STUB UP 10"[3.04M] THEN CONVERT TO SCHEDULE 80.
4. CONVERT 4"[.102M] CARRIER CONDUIT TO 3"[.076M] AT BASE OF POLE.
5. GC TO STUB UP POLE 10"[3.04M] w/3" POWER CONDUIT, POWER CO. TO CONVERT TROM 3"[.076M] SCH. 80 TO 2"[.051M] SCH. 80 FROM TOP OF STUB UP.

ALL CONDUIT WILL BE MAN DRILLED AND EQUIPPED WITH 3/8"[.010M] PULL ROPE.

MAINTAIN 40"[1.02M] MINIMUM COVER FOR ELECTRICAL CONDUIT.
 MAINTAIN 30"[1.762M] MINIMUM COVER FOR COMMUNICATIONS CONDUIT.
 SAND SHADING MINIMUM 1"[0.025M] UNDER CONDUITS, AND 6"[1.152M] COVERING ON TOP REQUIRED.
 ALL ELECTRICAL SERVICE CONDUITS FROM POWER COMPANY, WHETHER FROM POLES, TRANSFORMERS, OR OTHER LOCATIONS; WILL BE SLURRY BACKFILLED.

5. IN STREET SLURRY TO GRADE AND MILL DOWN 1-1/2"[.038M] FOR AC CAP.
6. IN DIRT SLURRY 18"[.457M] FROM GRADE, AND FILL WITH 95% COMPACTION NATIVE SOLI FOR BALANCE.

PLACE WARNING TAPE IN TRENCH 12"[.305M] ABOVE ALL CONDUITS AND #18 WARNING TAPE ABOVE GROUND RING.

. NO BOLT THREADS TO PROTRUDE MORE THAN 1-1/2"[.038M]. . FILL ALL HOLES LEFT IN POLE FROM REARRANGEMENT OF CLIMBERS.

ALL CLIMB STEPS NEXT TO CONDUIT SHALL HAVE EXTENDED STEPS.

4. CABLE NOT TO IMPEDE 15"[.381M] CLEAR SPACE OFF POLE FACE

4. CABLE NOT TO IMPEDE 151_ASTM] CLEAR SPACE OFF POLE FACE (12:00).
5. 90' SHORT SWEEPS UNDER ANTENNA ARM. ALL CABLES MUST ONLY TRANSITION ON THE INSIDE OR BOTTOM OF ARMS (NO CABLE ON TOP OF ARMS).
6. USE CABLE CLAMPS TO SECURE CABLE TO ARMS; PLACE 2"[0.51 M] CARRIER CABLE ID TAGS ON BOTH SIDES OF ARMS.
7. USE 90' CONNECTOR AT CABLE CONNECTION TO ANTENNAS.
8. PLACE GPS ON ARM WITH SOUTHERN SYE EXPOSURE AT MINIMUM.

S'[1.83M] FROM TRANSMIT ANTENNA, WHICH IS 24"[.61M] AWAY FROM CENTER OF POLE.

USE 1/2"[.013M] CABLE ON ANTENNAS UNLESS OTHERWISE
 SPECIFIED

FILL VOID AROUND CABLES AT CONDUIT OPENING WITH FOAM SEALANT TO PREVENT WATER INTRUSION.

ANTENNA/WOOD ARM AREA TOTAL	77.48 SQ. FT.
TOP GRADE	32'-3"
BOTTOM GRADE	28'-0"
METER/BREAKER AREA TOTAL	4.33 SQ. FT.
TOP GRADE	8'-0"
BOTTOM GRADE	7'-0"
BATTERY BACK-UP AREA TOTAL	16.25 SQ. FT.
TOP GRADE	11'-8"
BOTTOM GRADE	9'-6"
DELTA DECK AREA TOTAL	10.74 SQ. FT.
TOP GRADE	14'-7"
BOTTOM GRADE	12'-5"
DELTA DECK (FUT.) AREA TOTAL	10.74 SQ. FT.
TOP GRADE	17'-6"
BOTTOM GRADE	15'-4"
EXT. RISER SIZE	4"ø
EXT. RISER LENGTH	14'-0"
EXT. RISER BTM GRADE	15'-8"
PWR RISER SIZE	1"ø
PWR RISER LENGTH	28'-8"
PWR RISER BTM GRADE	8'-7"

WIND LOADING INFORMATION

		ANTENNA & CABLE	: SCHEDULE		
antenna Sector	AZIMUTH	ANTENNA MAKE / MODEL	COAXIAL CABLE LENGTH	CABLES PER SECTOR	CABLE SIZE
SECTOR ALPHA	349*	KATHREIN 840 21410	18'-5"	2	1/2"
SECTOR BETA	180*	KATHREIN 840 21410	18'-5"	2	1/2"
SECTOR GAMMA					

NOTE: CONTRACTOR TO FIELD VERIFY CABLE LENGTHS PRIOR TO ORDERING, FABRICATION, OR INSTALLATION OF CABLES

HWY8435-004A SITE NAME & ADDRESS:

11GHWAY 84/35 NETWORK NODE OO4A 14730 SKYLINE BLVD.


WOODSIDE CA 94062

IENERAL NOTES & SCHEDULE

KM SHEET NUMBER EVISION: 2

ROW CONSTRUCTION GENERAL NOTES ABBREVIATION AND LEGEND

LOADING AND ANTENNA CABLE SCHEDULES

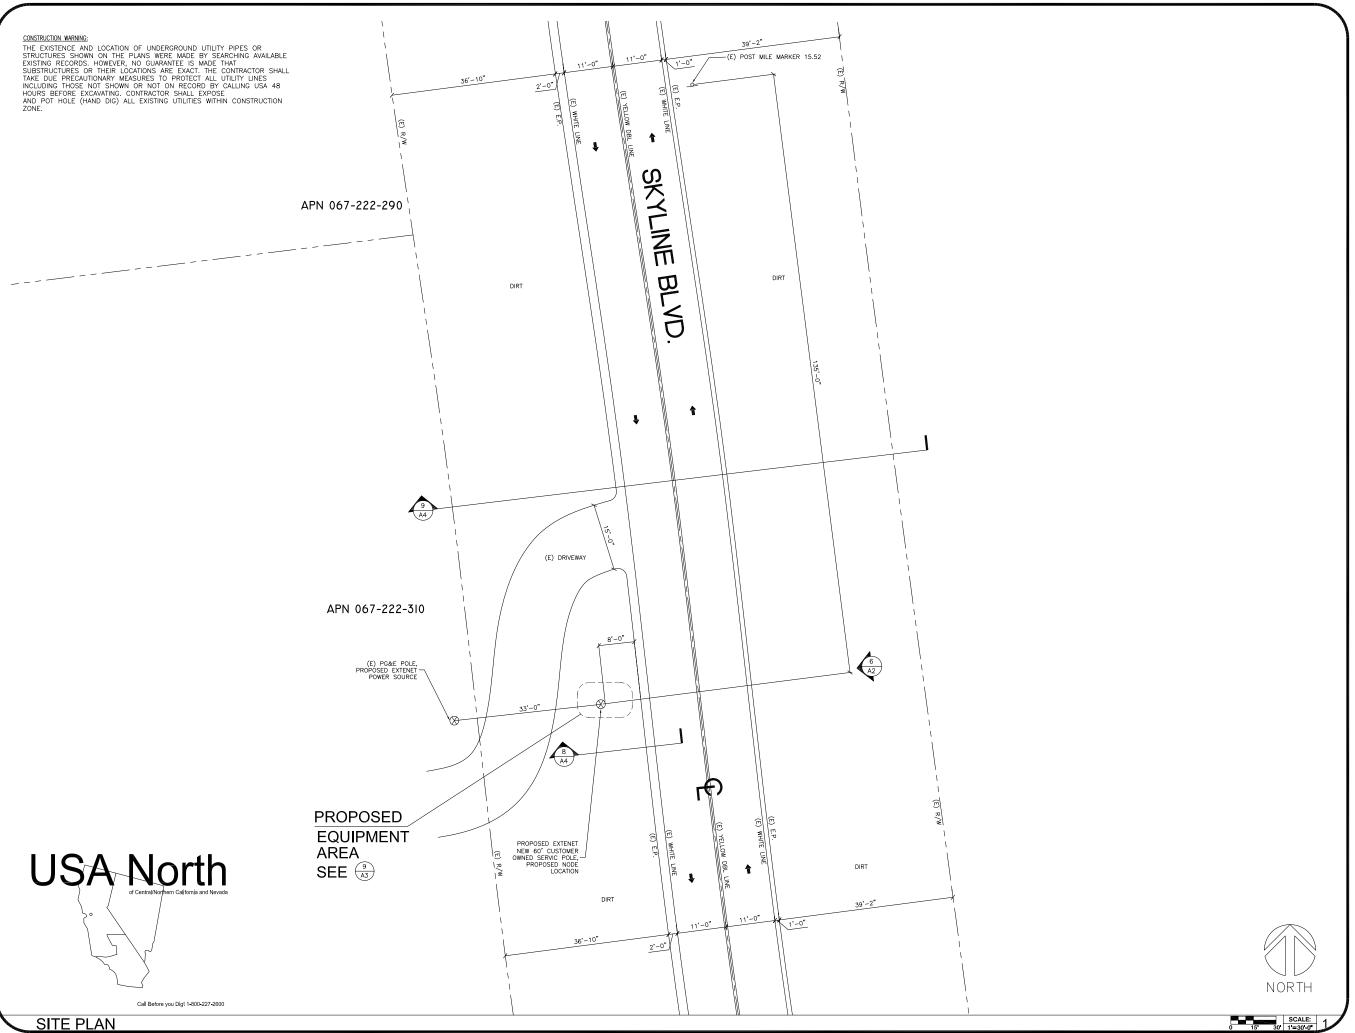




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SITE NO.:

HWY8435-004A

SITE NAME & ADDRESS:

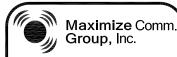HIGHWAY 84/35 NETWORK NODE OO4A

14730 SKYLINE BLVD. WOODSIDE, CA 94062

SITE PLAN

DRAWN BY: MG	CHECKED BY: AF	APPROVED BY
SHEET NUMBER:	A 4	REVISION:

EXTENET MAKE-READY

- 1. INSTALL NEW 60' CLASS 2 NODE POLE IN ROW (SEE SITE PLAN FOR LOCATION) POLE IS CUSTOMER OWNED POLE.
- 2. INSTALL FLUSH MOUNT TOP OF ANTENNA AT 32'-2" GRADE, (2) 51" PANEL ANT. (KATHREIN 840 21410) 3. INSTALL FLUSH MOUNT TOP OF ANTENNA AT 29'-10"
- GRADE. (2) 51" PANEL ANT. (KATHREIN 840 21410)
 4. INSTALL EXTENET NODE EQUIPMENT AND
- METER/BREAKER TO STAND—OFF BRACKET (4" OFF OF POLE) AT THE 3:00 POSITION (BETWEEN QUAD. 3-4)

 5. INSTALL 4" EXT CONDUIT AT 1:30 POSITION
 6. STRING IN EXTENET FIBER AND ATTACH PER FIBER DESIGN

POWER MAKE-READY

- 1. PG&E TO STRING IN SECONDARY POWER AT 52'-6" GRADE TO EXTENET NODE POLE IN ROW APPROX 33' EAST OF PG&E POLE LOCATION. (SEE SITE PLAN FOR
- LOCATION)
 2. INSTALL 1" PG&E SCH. 80 CONDUIT AT 1:00 POSITION (WITH WEATHER HEAD)
- 3. PROVIDE 120/240 3-WIRE SINGLE PHASE, 100 AMP SERVICE TO 1" PG&E CONDUIT TO EXTENET METER BOX FROM SECONDARY AT 42'-0" GRADE.



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HWY8435-004A

SITE NAME & ADDRESS:

11GHWAY 84/35 NETWORK NODE 004*F* 14730 SKYLINE BLVD.


WOODSIDE, CA 94062

LEVATIONS & RISER DETAIL


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MAKE-READY NOTES


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EAST POLE ELEVATION

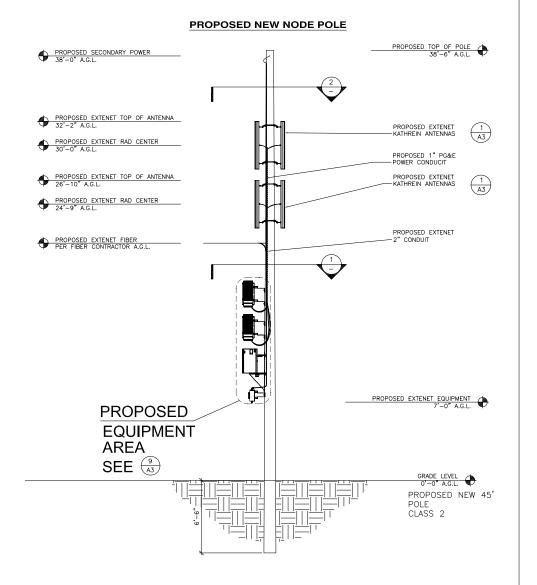

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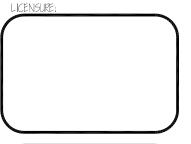
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HWY8435-004A

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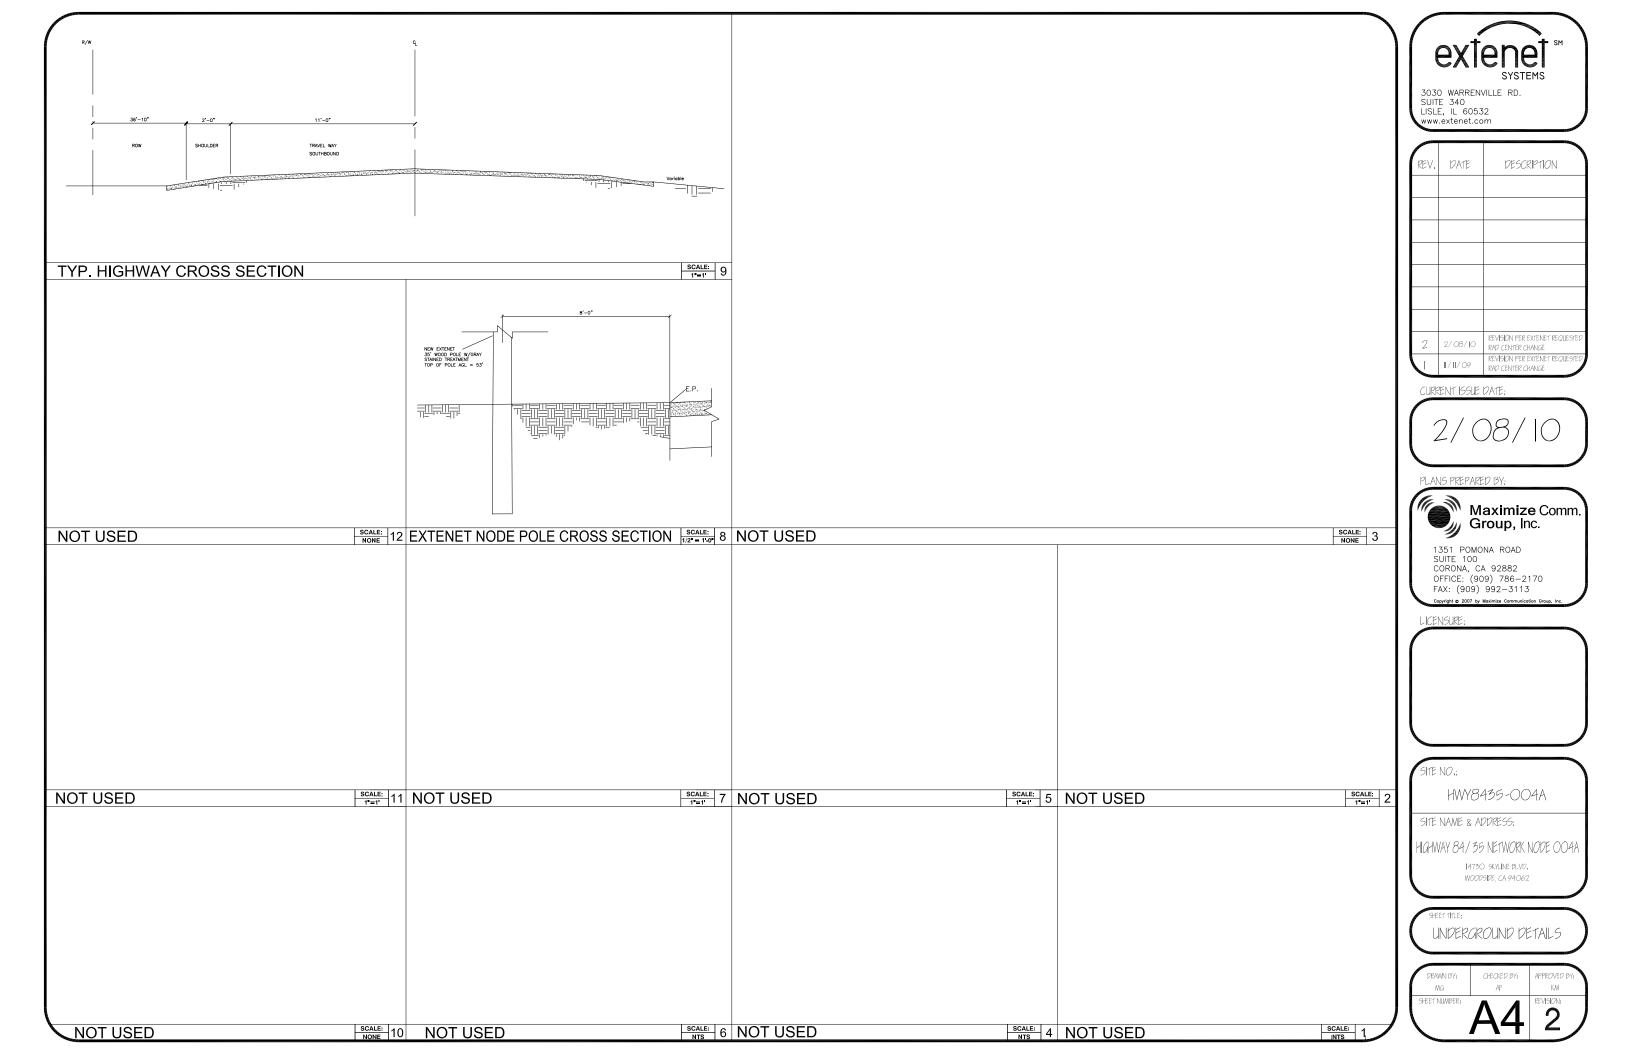
HIGHWAY 84/35 NETWORK NODE OO4A

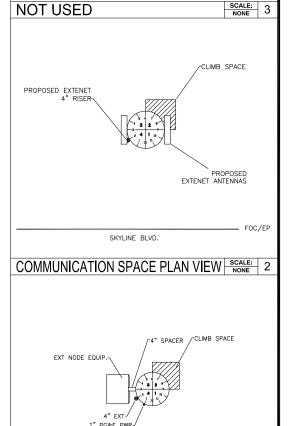14730 SKYLINE BLVD. WOODSIDE, CA 94062

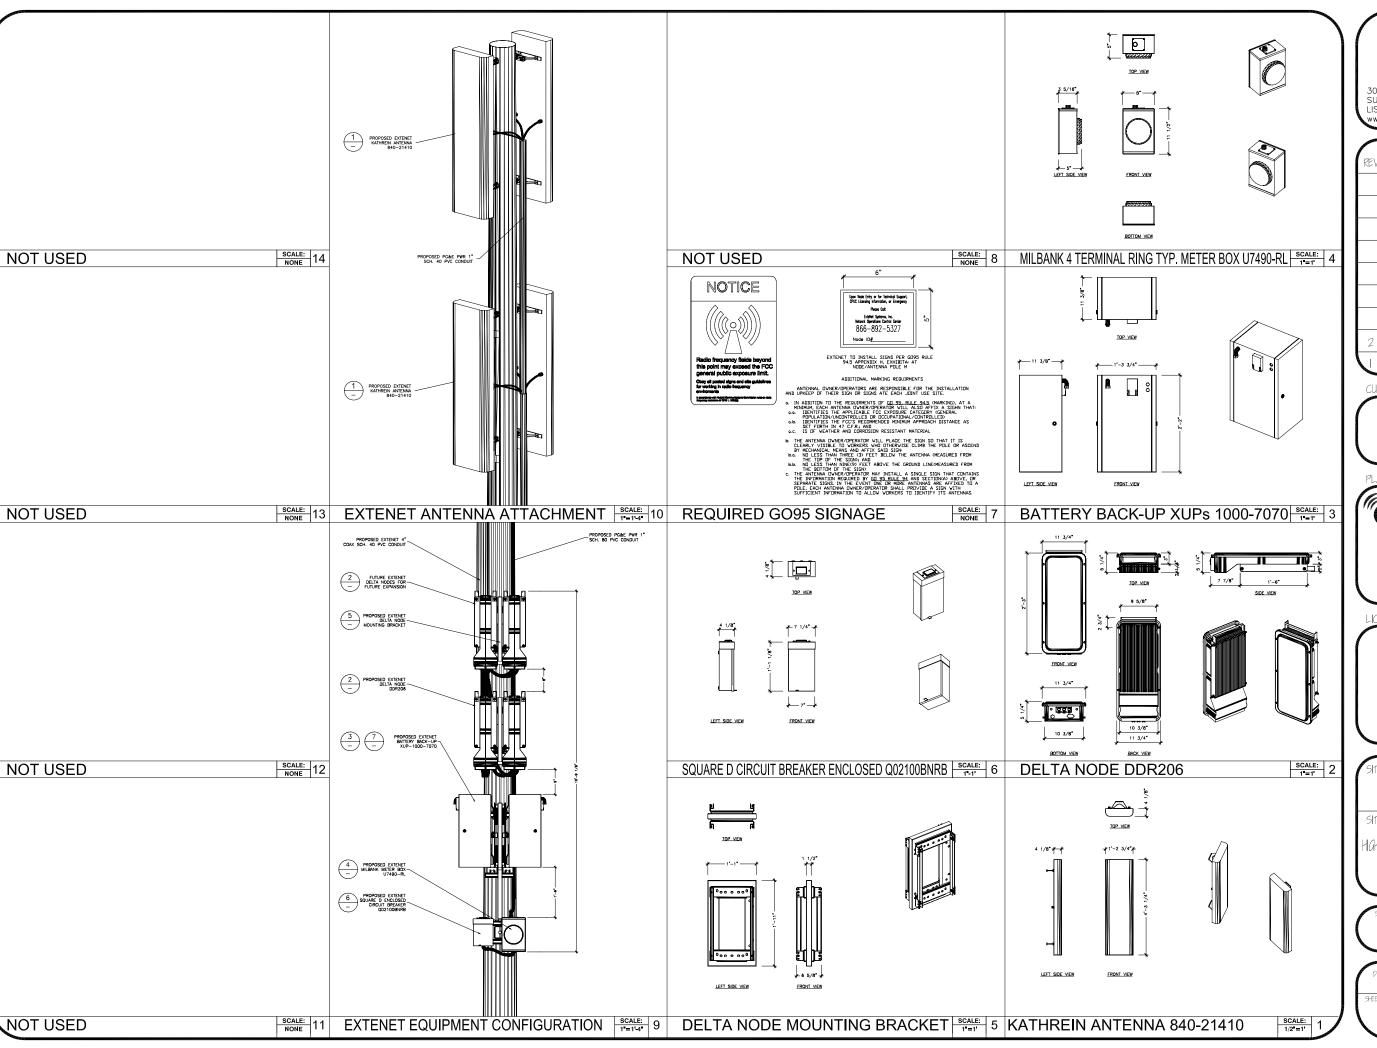SHEET 11T

AERIAL DETAILS

SHEET NUMBER:	<u>A3</u>	2
DRAWN BY: NG	CHECKED BY: AF	APPROVED BY:





SYSTEMS


HWY - 35 PROJECT

HWY8435 - 005B

POST MILE MARKER 15.48

14865 SKYLINE BLVD.

WOODSIDE, CA 94062

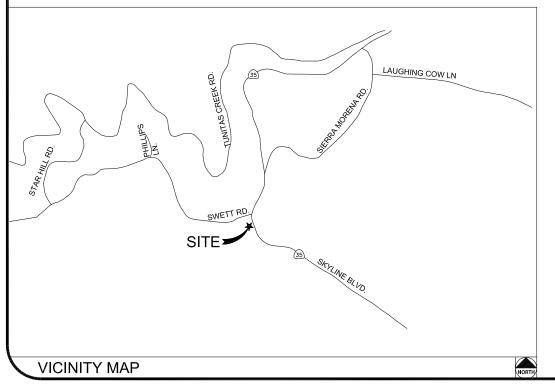

CLIENT

EXTENET SYSTEMS, INC. 3030 WARRENVILLE RD. SUITE 340 LISLE, IL 60532 CONTACT JEFF FRYE PHONE 480-626-1271 FAX 504-285-1603

POLE OWNER

EXTENET SYSTEMS, INC. 3030 WARRENVILLE RD. SUITE 340 LISLE, IL 60532 CONTACT JEFF FRYE PHONE 480-626-1271 FAX 504-285-1603

ENGINEERING FIRM/SURVEYING

MAXIMIZE COMMUNICATION GROUP, INC. 1351 POMONA ROAD SUITE 100 CORONA, CA 92882 CONTACT KELLI MCCABE PHONE 909-786-2170 FAX 909-992-3113

COORDINATES

LAT: 37.41816 LONG: -122.31930

CODE COMPLIANCE:

ALL WORK AND MATERIALS SHALL BE PERFORMED & INSTALLED IN ACCORDANCE WITH THE CURRENT EDITIONS OF THE FOLLOWING CODES AS ADOPTED BY LOCAL GOVERNING AUTHORITIES AND LOCAL/CITY/COUNTY ORDINANCES:

 CALIFORNIA ADMINISTRATIVE CODE (INCLUDING TITLE 24 & 25).

- 2. 2007 CALIFORNIA BUILDING CODE.
- 2007 CALIFORNIA ELECTRICAL CODE.
- 3. BUILDING OFFICIALS AND CODE ADMINISTRATORS (BOCA).
- 4. UNIFORM PLUMBING & MECHANICAL CODES.
- 5. ANSI/EIA-222-F LIFE SAFETY CODE.
- 6. CALIFORNIA GENERAL ORDER 95, 128 & 165.

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T1	TITLE SHEET
T2	GENERAL CONSTRUCTION NOTE & ANTENNA CABLE SCHEDULE
A1	SITE PLAN
A2	UTILITY POLE ELEVATIONS/RISER DETAILS
А3	AERIAL DETAILS
A4	UNDERGROUND DETAILS

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3030 WARRENVILLE RD. SUITE 340 LISLE, IL 60532 www.extenet.com

-400		NOTE:
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2	01/05/10	REVISION PER PG&E REQUEST
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No.	

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HWY8435-005B

SITE NAME & ADDRESS:

HIGHWAY 84/35 NETWORK NODE OOS

14865 SKYLINE BLVD. Woodside CA 94062


SHEET 111.

111LE SHEET

DRAWN BY: CHECKED BY: APPROVED BY:
VG AF KM

SHEET NUMBER: T1

3

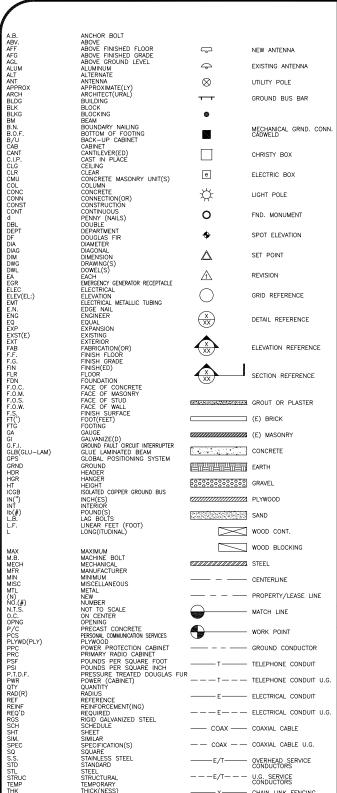

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- 7. MANHOLES OR COVERS SHALL BE LABELED EXTENET
- 8. CONTRACTOR SHALL IMPLEMENT AN EROSION CONTROL PROGRAM DURING THE PROJECT CONSTRUCTION ACTIVITIES. THE PROGRAM SHALL MEET THE APPLICABLE REQUIREMENTS OF THE STATE WATER RESOURCE CONTROL
- 9. THE CONTRACTOR SHALL HAVE EMERGENCY MATERIALS AND EQUIPMENT ON HAND FOR UNFORESEEN SITUATIONS, SUCH AS DAMAGE TO UNDERGROUND WATER, SEWER, AND STORM DRAIN FACILITIES WHEREBY FLOWS MAY GENERATE EROSION AND SEDIMENT POLLUTION.

USA North

- INDEMNIFICATION CLAUSE: THE CONTRACTOR AGREES AND SHALL:
 ASSUME SOLE AND COMPLETE RESPONSIBILITY OF THE JOB SITE CONDITIONS DURING THE COURSE OF
 CONSTRUCTION OF THIS PROJECT, INCLUDING THE EAFETY OF ALL PERSONS AND PROPERTIES. THAT THESE
 REQUIREMENTS SHALL APPLY CONTINUOUSLY AND NOT BE LIMITED TO NORMAL WORKING HOURS AND CONDITIONS. ENGINEERS HARMLESS FROM ANY AND ALL LIABILITY, REAL OR ALLEGED IN CONNECTION WITH THE PERFORMANCE
- 2. PRIOR TO THE BEGINNING OF ANY CONSTRUCTION AND THROUGHOUT THE COURSE OF CONSTRUCTION WORK. THE CONTRACTOR SHALL FULLY COMPLY WITH "CALIFORNIA OCCUPATIONAL SAFETY AND HEALTH" ACT OF 1973 INCLUDING ALL REVISIONS AND AMENDMENTS THERETO.
- 3. ALL WORK SHALL CONFORM TO THE LATEST EDITIONS OF G095,128 AND THE STANDARD "SPECIFICATIONS FOR PUBLIC WORKS CONSTRUCTION" AS ADOPTED BY THE CITY, COUNTY OR STATE AS MODIFIED BY STANDARD PLANS
- 4. THE EXISTENCE AND LOCATION OF UTILITIES AND OTHER AGENCY'S FACILITIES AS SHOWN HERON ARE OBJECT OF AVAILABLE RECORDS. OTHER FACILITIES MAY SUSTE. THE CONTRACTOR SHALL VERIFY PRIOR TO THE START OF CONSTRUCTION AND SHALL USE EXTREME CARE AND PROTOCTIVE MEASURES TO OR AGENCY FACILITIES WITHIN THE LIMITS OF WORK, WHETHER THEY ARE SHOWN ON THIS PLAN OR NOT.
- 5. THE CONTRACTOR SHALL NOTIFY THE CITY, COUNTY OR STATE ENGINEER INSPECTION DEPARTMENT, AT LEAST TWO DAYS BEFORE START OF ANY WORK REQUIRING THEIR INVOLVEMENT.
- 6. THE CITY, COUNTY OR STATE SHALL SPECIFY THE EXPIRATION PERIOD OF THE PERMIT FOR THIS CONSTRUCTION PROJECT.
- 7. THE MINIMUM COVER FOR ALL CONDUITS PLACED UNDERGROUND SHALL BE 36 INCHES TO THE FINISHED GRADE AT ALL TIMES.
- 8. THE CONTRACTOR SHALL TUNNEL ALL CURB AND GUTTERS AND BORE ALL CONCRETE DRIVEWAYS AND WALKWAYS AT THE DIRECTION OF THE CITY, COUNTY OR STATE ENGINEER.
- ALL A.C AND/OR CONCRETE PAVEMENT SHALL BE REPLACED AT THE DIRECTION OF THE CITY, COUNTY OR STATE ENGINEERS.
- WORK, SHALL BE REPLANTED AND/OR REPLACED SO AS TO RESTORE THE WORK SITE TO ITS ORIGINAL CONDITION 11. THE CONTRACTOR WILL BE RESPONSIBLE FOR THE PROCESSING OF ALL APPLICANT PERMIT FORMS ALONG WITH THE REQUIRED LIABILITY INSURANCE FORMS. CLEARLY DEMONSTRATING THAT EXTENET, THE CITY, COUNTY OR
- STATE IS ALSO INSURED WITH THE REQUIRED LIABILITY INSURANCE IN THE AMOUNT OF \$1,000,000.00 FOR THIS VAULTS, PEDESTALS, CONDUITS AND OTHER TYPES OF SUBSTRUCTURE ARE EITHER SPECIFIED ON THIS PLAN OR WILL BE SPECIFIED BY THE CONSTRUCTION ENGINEER, ANY AND ALL DEVIATIONS FROM THE SPECIFIED TYPES
- OF MATERIAL MUST BE APPROVED BY THE SYSTEM ENGINEER, IN WRITING BEFORE INSTALLATION THEREOF. 13. THE CONTRACTOR SHALL VERIFY THE LOCATION OF ALL EXISTING UTILITIES IN INCLUDING SEWER LATERALS & WATER SERVICES TO INDIVIDUAL LOTS BOTH VERTICAL AND HORIZONTAL PRIOR TO COMMENCING IMPROVEMENT
- 14. CONTRACTOR SHALL MAKE EXPLORATION EXCAVATIONS AND LOCATE EXISTING FACILITIES SUFFICIENTLY AHEAD OF CONSTRUCTION TO PERMIT REVISIONS TO PLANS IF REVISION IS NECESSARY BECAUSE OF LOCATION OF
- 15. THE LOCATIONS OF ALL EXISTING UTILITIES SHOWN ON THESE PLANS ARE FROM EXISTING RECORDS AND CORROBORATED, WHERE POSSIBLE, WITH FIELD TIES. THE CONTRACTOR IS RESPONSIBLE FOR CONFIRMING THE LOCATIONS SHOWN, BOTH HORIZONIAL AND VERTICALLY. PRIOR TO CONSTRUCTION, IF EXISTING LOCATIONS VAR SUBSTANTIALLY FROM THE PLANS. THE ENGINEER SHOULD BE NOTIFIED TO MAKE ANY CONSTRUCTION CHANGES

EROSION AND SEDIMENT CONTROL NOTES

TEMPORARY EROSION/SEDIMENT CONTROL PRIOR TO COMPLETION OF FINAL IMPROVEMENTS, SHALL BE PERFORMED BY THE CONTRACTOR OR QUALIFIED PERSON AS INDICATED BELOW:

- 1. ALL REQUIREMENTS OF THE CITY, COUNTY AND STATE "STORM WATER STANDARDS" MUST BE INCORPORATED INTO THE DESIGN AND CONSTRUCTION OF THE PROPOSED GRADING/IMPROVMENTS CONSISTENT WITH THE APPROVED STORM WATER POLLUTION PREVENTION PLAN (SWPPP), WATER QUALITY TECHNICAL REPORT (WQTR), AND/OR WATER POLLUTION CONTROL PLAN (WPCP).
- 2. FOR STORM DRAIN INLETS, PROVIDE A GRAVEL BAG SILT BASIN IMMEDIATELY UPSTREAM OF INLET AS INDICATED ON DETAILS.
- 3. FOR INLETS LOCATED AT SUMPS ADJACENT TO TOP OF SLOPES. THE CONTRACTOR SHALL ENSURE THAT WATER DRAINING TO THE SUMP IS DIRECTED INTO THE INLET AND THAT A MINIMUM OF 1.00' FREEBOARD EXISTS AND IS MAINTAINED ABOVE THE TOP OF THE NITE. IF FREEBOARD IS NOT PROVIDED BY GRADING SHOWN ON
- 4. THE CONTRACTOR OR QUALIFIED PERSON SHALL BE RESPONSIBLE FOR CLEANUP OF SILT AND MUD ON ADJACENT STREET(S) AND STORM DRAIN SYSTEM DUE TO CONSTRUCTION ACTIVITY.
- 5. THE CONTRACTOR OR QUALIFIED PERSON SHALL CHECK AND MAINTAIN ALL LINED AND UNLINED DITCHES AFTER EACH RAINFALL.
- 6. THE CONTRACTOR SHALL REMOVE SILT AND DEBRIS AFTER EACH MAJOR RAINFALL
- 8. THE CONTRACTOR SHALL RESTORE ALL EROSION/SEDIMENT CONTROL DEVICES TO WORKING ORDER TO THE SATISFACTION OF THE CITY ENGINEER OF RESIDENT ENGINEER AFTER EACH RUN-OFF PRODUCING RAINFALL.
- 9. THE CONTRACTOR SHALL INSTALL ADDITIONAL EROSION/SEDIMENT CONTROL MEASURES AS MAY BE REQUIRED BY THE RESIDENT ENGINEER DUE TO UNCOMPLETED GRADING OPERATIONS OR UNFORESEEN CIRCUMSTANCES,
- 10. THE CONTRACTOR SHALL BE RESPONSIBLE AND SHALL TAKE NECESSARY PRECAUTIONS TO PREVENT PUBLIC TRESPASS ONTO AREAS WHERE IMPOUNDED WATERS CREATE A HAZARDOUS CONDITION.
- 11. ALL EROSION/SEDIMENT CONTROL MEASURES PROVIDED PER THE APPROVED GRADING PLAN SHALL BE INCORPORATED HERON. ALL EROSION/SEDIMENT CONTROL FOR INTERIM CONDITIONS SHALL BE DONE TO THE SATISFACTION OF THE RESIDENT BEGINEER.
- 12. GRADED AREAS AROUND THE PROJECT PERIMETER MUST DRAIN AWAY FROM THE FACE OF THE SLOPE AT THE CONCLUSION OF EACH WORKING DAY.
- 13. ALL REMOVABLE PROTECTIVE DEVICES SHOWN SHALL BE IN PLACE AT THE END OF EACH WORKING DAY WHEN RAIN IS IMMINENT.
- 14. THE CONTRACTOR SHALL ONLY GRADE, INCLUDING CLEARING AND GRUBBING FOR THE AREAS FOR WHICH THE CONTRACTOR OR QUALIFIED PERSON CAN PROVIDE EROSION/SEDIMENT CONTROL MEASURES.
- 15. THE CONTRACTOR SHALL ARRANGE FOR WEEKLY MEETINGS DURING OCTOBER 1ST TO APRIL 30TH FOR PROJECT FEAM (GENERAL CONTRACTOR, QUALIFIED PERSON, EROSION CONTROL SUBCONTRACTOR IF AN, ENGINEER OF WORK, OWNER/DEVELOPER AND THE RESIDENT ENGINEER) TO EVALUATE THE ADEQUACY OF THE EROSION/SEDIMENT CONTROL MEASURE AND OTHER RELATED CONSTRUCTION ACTIVITIES.

ANTENNA & CABLE SCHEDULE


MAKE / MODEL

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	REV.	DATE	DESCRIPTION
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1351 POMONA ROAD CORONA, CA 92882 OFFICE: (909) 786-2170 FAX: (909) 992-3113

2

CABLE SIZE

1/2"

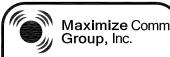1/2"

2

2

HWY8435-005B

SITE NAME & ADDRESS:

HGHWAY 84/35 NETWORK NODE OOSE

14865 SKYLINE BLVD. Woodside, CA 94062

IENERAL NOTES & SCHEDULE

SHEET NUMBER:	T2	REVISION:
DRAWN BY: VG	CHECKED BY: AF	APPROVED BY

Call Before you Dlg! 1-800-227-2600

GENERAL NOTES

- 1. 120/240 POWER REQUIRED FOR 3-WIRE SERVICE.
 2. GC TO REMOVE/CLEAN ALL DEBRIS, NAILS, STAPLES, OR NON-USED VERTICALS OFF THE POLE.
- THE POLE.

 ALL CONSTRUCTION SHALL BE IN ACCORDANCE WITH MUNICIPAL, COUNTY, STATE, FEDERAL, GOS AND GO128 STANDARDS AND REGULATIONS.

 CALL USA 48 HOURS PRIOR TO EXCAVATING AT (800) 422-4133.

 ALL LANDSCAPING TO BE RESTORED TO ORIGINAL CONDITION OR BETTER.

 ALL EQUIPMENT TO BE BONDED.
- 7. METERING CABINET REQUIRES 3'[.914M] CLEARANCE AT DOOR OPENING. 8. CAULK CABINET BASE AT PAD.
- STANDARD GROUNDING NOTES:
- 5/8"x8"[.016x2.44M] ROD, CAD WELD BELOW GRADE
- #6 GROUND AND BOND WIRE
- . WOOD MOLDING, STAPLED EVERY 3'[.914M] AND AT EACH END 6. PLACE 3 #10GA WIRES FROM BREAKER TO METER BOX.

STANDARD CONDUIT NOTES:

- 1. FOR UNDERGROUND USE SCHEDULE 40.
 2. FOR RISERS USE SCHEDULE 80.
 3. PLACE 2"[.051M] GALVANIZED STEEL CONDUIT FOR ANY CONDUIT UNDER 3"[.076M], STUB UP 10"[3.04M] THEN CONVERT TO SCHEDULE 80.
 4. CONVERT 4"[.102M] CARRIER CONDUIT TO 3"[.076M] AT BASE OF POLE.
 5. GC TO STUB UP POLE 10"[3.04M] w/3" POWER CONDUIT, POWER CO. TO CONVERT TROM 3"[.076M] SCH. 80 TO 2"[.051M] SCH. 80 FROM TOP OF STUB UP.
- ALL CONDUIT WILL BE MAN DRILLED AND EQUIPPED WITH 3/8"[.010M] PULL ROPE.

- MAINTAIN 40"[1.02M] MINIMUM COVER FOR ELECTRICAL CONDUIT.
 MAINTAIN 30"[7.62M] MINIMUM COVER FOR COMMUNICATIONS CONDUIT.
 SAND SHADING MINIMUM 1"[0.025M] UNDER CONDUITS, AND 6"[1.152M] COVERING ON TOP REQUIRED.
 ALL ELECTRICAL SERVICE CONDUITS FROM POWER COMPANY, WHETHER FROM POLES, TRANSFORMERS, OR OTHER LOCATIONS; WILL BE SLURRY BACKELI EXTRANSFORMERS.
- 5. IN STREET SLURRY TO GRADE AND MILL DOWN 1-1/2"[.038M] FOR AC CAP.
 6. IN DIRT SLURRY 18"[.457M] FROM GRADE, AND FILL WITH 95% COMPACTION NATIVE SOLI FOR BALANCE.
- PLACE WARNING TAPE IN TRENCH 12"[.305M] ABOVE ALL CONDUITS AND #18 WARNING TAPE ABOVE GROUND RING.

- . NO BOLT THREADS TO PROTRUDE MORE THAN 1-1/2"[.038M]. . FILL ALL HOLES LEFT IN POLE FROM REARRANGEMENT OF CLIMBERS.
- ALL CLIMB STEPS NEXT TO CONDUIT SHALL HAVE EXTENDED STEPS.
- 4. CABLE NOT TO IMPEDE 15"[.381M] CLEAR SPACE OFF POLE FACE
- 4. CABLE NOT TO IMPEDE 151_ASTIM] CLEAR SPACE OFF POLE FACE (12:00).
 5. 90' SHORT SWEEPS UNDER ANTENNA ARM. ALL CABLES MUST ONLY TRANSITION ON THE INSIDE OR BOTTOM OF ARMS (NO CABLE ON TOP OF ARMS).
 6. USE CABLE CLAMPS TO SECURE CABLE TO ARMS; PLACE 2"[0.51 M] CARRIER CABLE ID TAGS ON BOTH SIDES OF ARMS.
 7. USE 90' CONNECTOR AT CABLE CONNECTION TO ANTENNAS.
 8. PLACE GPS ON ARM WITH SOUTHERN SYLEXPOSURE AT MINIMUM.
- S'[1.83M] FROM TRANSMIT ANTENNA, WHICH IS 24"[.61M] AWAY FROM CENTER OF POLE.
- 9. USE 1/2"[.013M] CABLE ON ANTENNAS UNLESS OTHERWISE
- FILL VOID AROUND CABLES AT CONDUIT OPENING WITH FOAM SEALANT TO PREVENT WATER INTRUSION.

TOTAL	77.48 SQ. FT.
TOP GRADE	24'-6"
BOTTOM GRADE	20'-0"
METER/BREAKER AREA TOTAL	4.33 SQ. FT.
TOP GRADE	8'-0"
BOTTOM GRADE	7'-0"
BATTERY BACK-UP AREA TOTAL	16.25 SQ. FT.
TOP GRADE	11'-8"
BOTTOM GRADE	9'-6"
DELTA DECK AREA TOTAL	10.74 SQ. FT.
TOP GRADE	14'-7"
BOTTOM GRADE	12'-5"
DELTA DECK (FUT.) AREA TOTAL	10.74 SQ. FT.
TOP GRADE	17'-6"
BOTTOM GRADE	15'-4"
ext. Riser size	4 " ø
EXT. RISER LENGTH	15'-"
EXT. RISER BTM GRADE	14'-5"
PWR RISER SIZE	1"ø
PWR RISER LENGTH	10'-8"
PWR RISER BTM GRADE	8'-2"

ANTENNA/WOOD ARM AREA TOTAL	77.48 SQ. FT.
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WIND LOADING INFORMATION

LOADING AND ANTENNA CABLE SCHEDULES

ANTENNA SECTOR

AI PHA


SECTOR

AZIMUTH

TOP OF PLATE (PARAPET)
TOP OF STEEL (SLAB)
TOP OF WALL

TOP OF WALL
TYPICAL
UNDER GROUND
UNDERWRITERS LABORATOR'
UNLESS NOTED OTHERWISE
VERIFY IN FIELD
WIDE(WIDTH)
WITH

WOOD

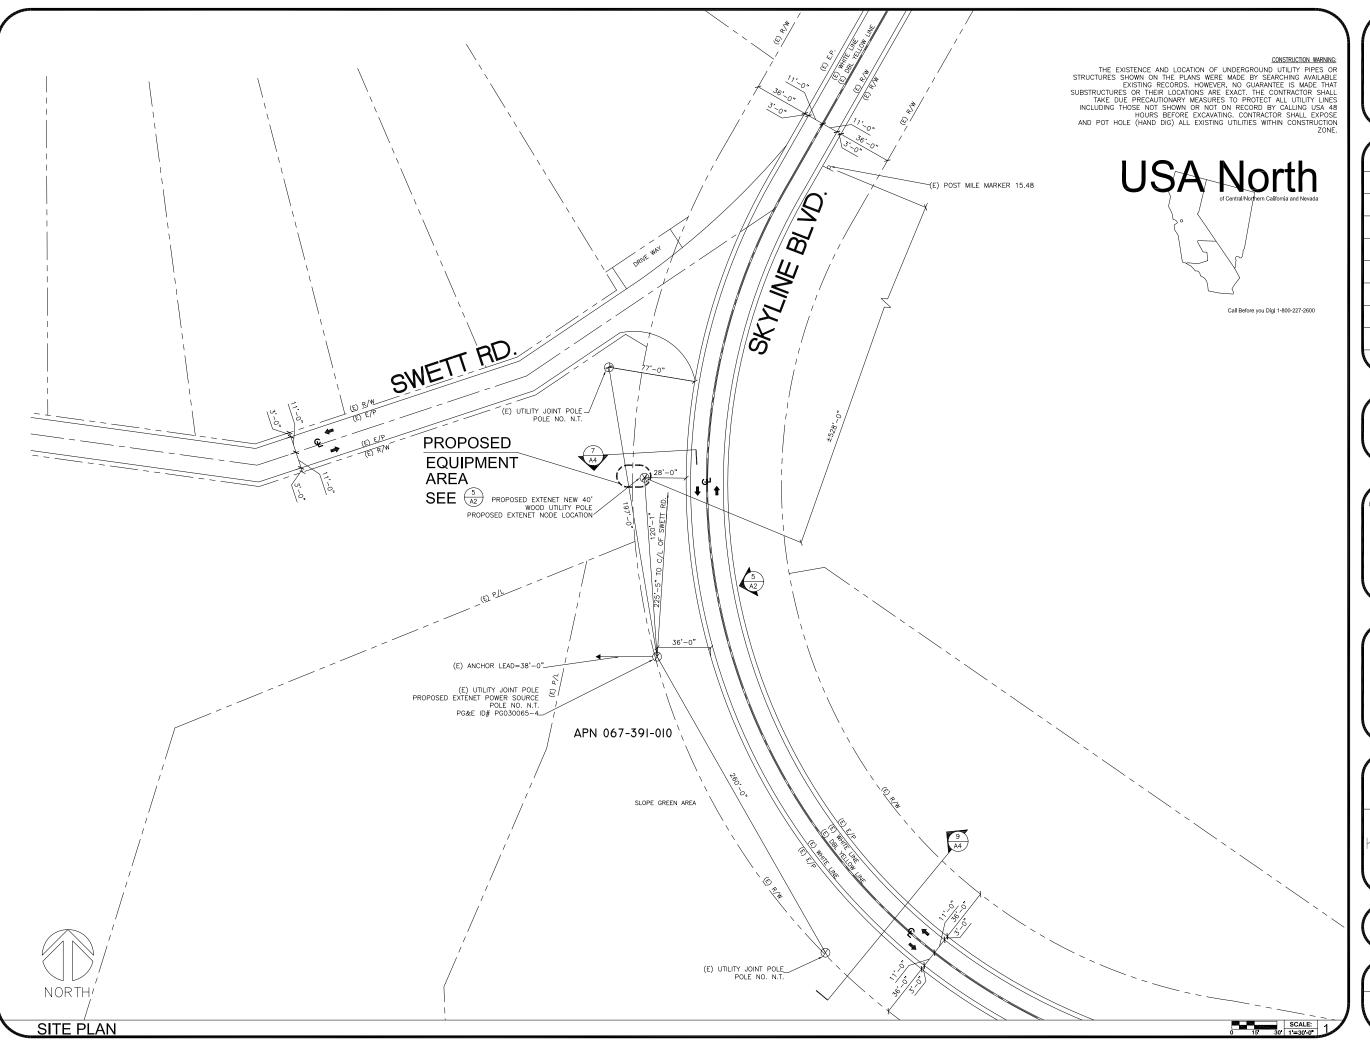



	REV.	DATE	DESCRIPTION
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1		11/11/09	REVISION PER EXTENET REQUESTED

CURRENT ISSUE DATE:

02/08/10

PLANS PREPARED BY:



1351 POMONA ROAD SUITE 100 CORONA, CA 92882 OFFICE: (909) 786-2170 FAX: (909) 992-3113

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LICENSURE:

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SITE NO.:

HWY8435-005B

SITE NAME & ADDRESS:

11GHWAY 84/35 NETWORK NODE 0051

14865 SKYLINE BLVD. Woodside, CA 94062

SHEET 111

SITE PLAN

VG SHEET NUMBER:	Λ ⁴	KM REVISION:
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EXTENET MAKE-READY

- 1. INSTALL 40', CLASS 2, DOUGLAS FIR UTILITY POLE,
- PER SITE PLAN.

 2. FLUSH MOUNT 4" PANEL ANTENNAS TOP AT 32'-2"
 GRADE. SECOND SET 1' BELOW PER ELEVATION.

 3. INSTALL DELTA NODE RADIOS, BATTERY BACK-UP,
 METER AND ELEC. ENCLOSURE AT 3:00 POSITION W/MIN. 4" SPACING FROM POLE.
- 4. INSTALL 4" PVC SCH. 40 COAX RISER AT 2:00 POSITION.

MAKE-READY NOTES

PROPOSED 40' POLE

CLASS 2

EXISTING ELEVATION WEST

POWER MAKE-READY

- INSTALL TRANSFORMER AND SECONDARY POWER FOR SERVICE. PER PG&E DESIGN.
 INSTALL 1" PVC SCH. 80 RISER W/WEATHER HEAD AT
- 2:00 (QUAD 4) POSITION.
- 3. PROVIDE 120/240V, 3-WIRE, SINGLE PHASE 100 AMP SERVICE TO 1" PG&E RISER TO EXTENET METER BOX FROM SECONDARY SERVICE POINT.



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CURRENT ISSUE DATE:

- CLIMB SPACE

/4" SPACER /CLIMB SPACE

FOC/EF

PROPOSED EXTENET PWR/FIBER 2"-

SCALE: 5 EQUIP. SPACE PLAN VIEW SCALE: NONE

PROPOSED EXTENET COAX 4"



PLANS PREPARED BY:



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LICENSURE

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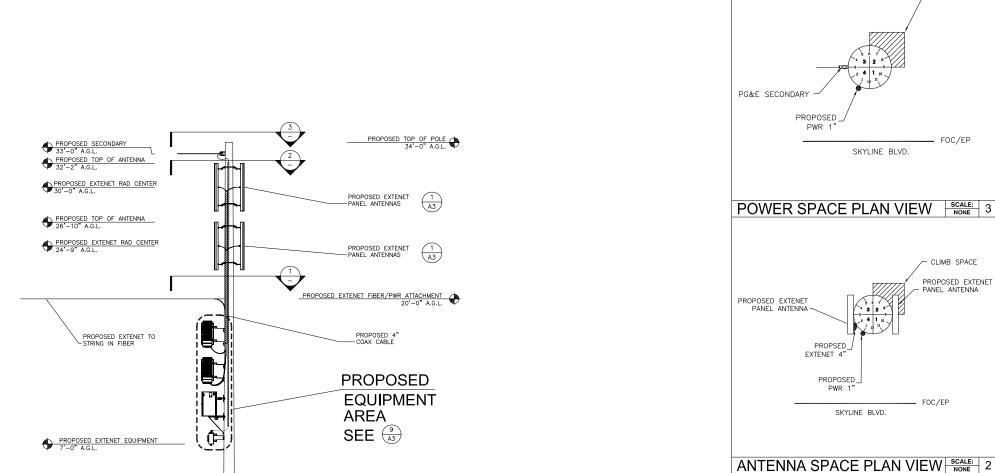
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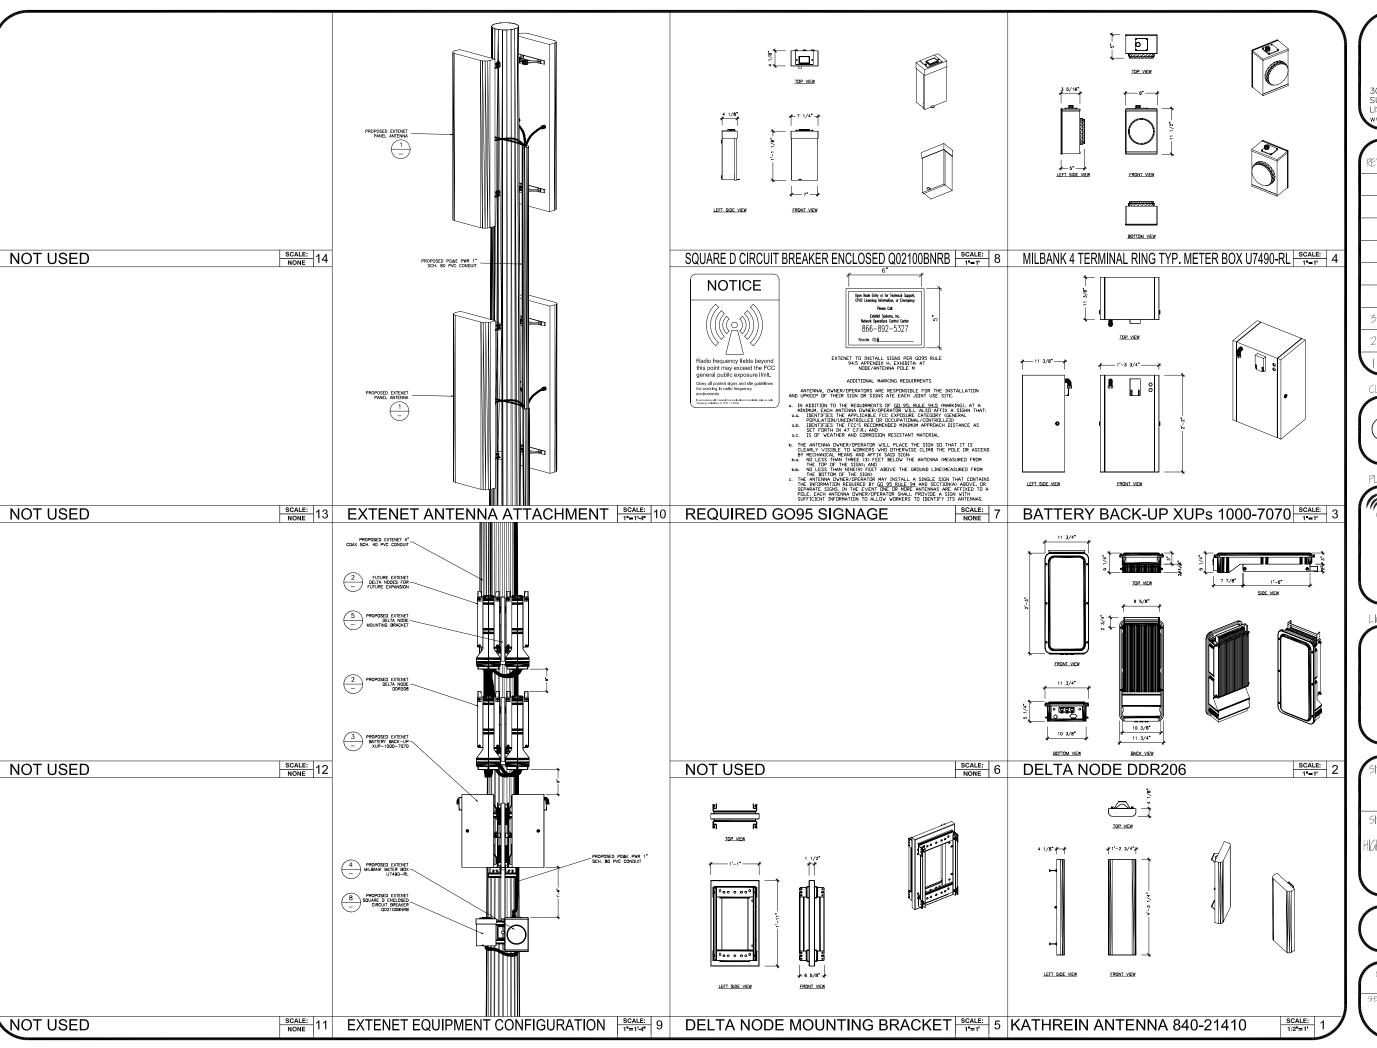
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Woodside, CA 94062

ELEVATIONS & RISER DETAIL

KM EVISION: 3







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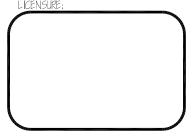


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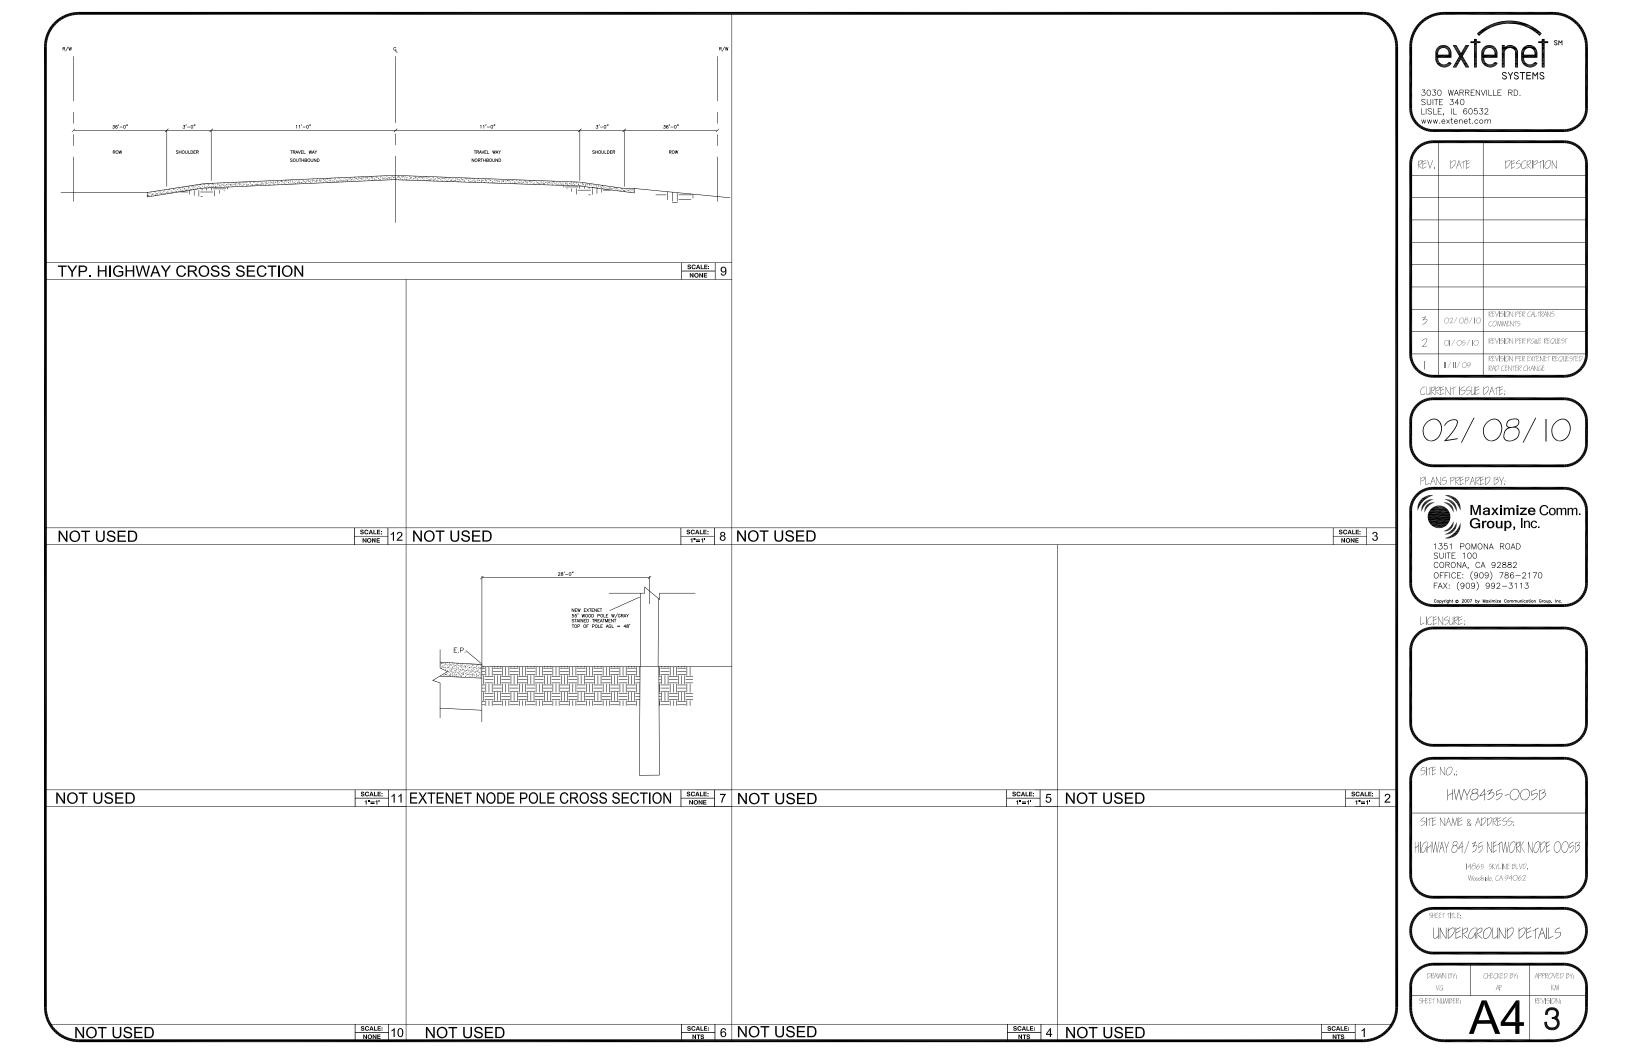
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AERIAL DETAILS


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SYSTEMS

HWY 35 - PROJECT HWY8435 - 007B POST MILE MARKER 14.78 MARKER B18 SKYLINE BLVD. WOODSIDE, CA 94062



CLIENT

EXTENET SYSTEMS, INC. 3030 WARRENVILLE RD. SUITE 340 LISLE, IL 60532 CONTACT JEFF FRYE PHONE 480-626-1271 FAX 504-285-1603

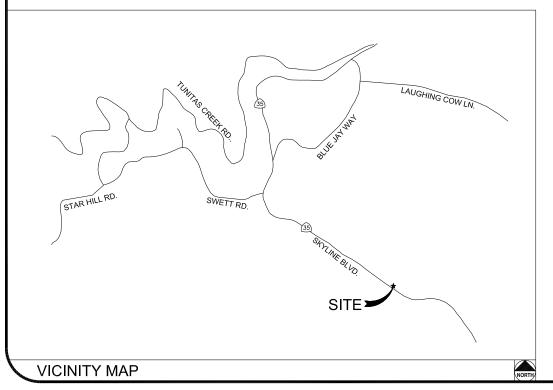EXTENET SYSTEMS, INC. 3030 WARRENVILLE RD. SUITE 340 LISLE, IL 60532 CONTACT JEFF FRYE PHONE 480-626-1271 FAX 504-285-1603

ENGINEERING FIRM/SURVEYING

MAXIMIZE COMMUNICATION GROUP, INC. MAXIMIZE COMMUNICATIO 1351 POMONA ROAD SUITE 100 CORONA, CA 92882 CONTACT KELLI McCABE PHONE 909-786-2170 FAX 909-992-3113

COORDINATES

CODE COMPLIANCE:

ALL WORK AND MATERIALS SHALL BE PERFORMED & INSTALLED IN ACCORDANCE WITH THE CURRENT EDITIONS OF THE FOLLOWING CODES AS ADOPTED BY LOCAL GOVERNING AUTHORITIES AND LOCAL/CITY/COUNTY ORDINANCES:

1. CALIFORNIA ADMINISTRATIVE CODE (INCLUDING TITLE 24 &

- 3. 2007 CALIFORNIA ELECTRICAL CODE.
- 3. BUILDING OFFICIALS AND CODE ADMINISTRATORS (BOCA).
- 4. UNIFORM PLUMBING & MECHANICAL CODES.
- 5. ANSI/EIA-222-F LIFE SAFETY CODE
- 6. CALIFORNIA GENERAL ORDER 95, 128 & 165.

	SHEET INDEX				
SHEET	DESCRIPTION				
T1	TITLE SHEET				
T2	GENERAL CONSTRUCTION NOTE & ANTENNA CABLE SCHEDULE				
A1	SITE PLAN				
A2	UTILITY POLE ELEVATIONS/RISER DETAILS				
A3	AERIAL DETAILS				
A4	UNDERGROUND DETAILS				
E1	ELECTRICAL DETAILS				
	· NEEDER				



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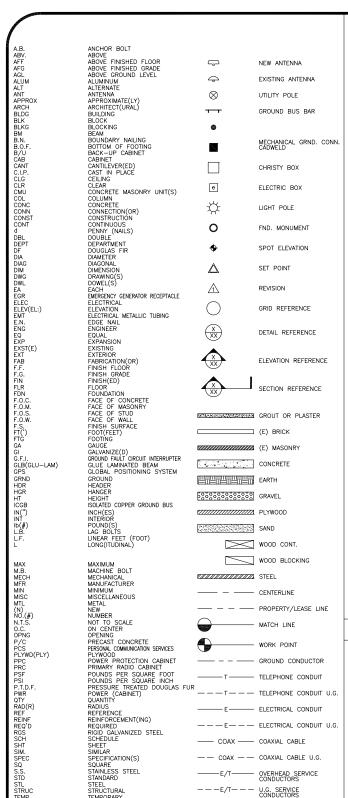
SITE NAME & ADDRESS:

HIGHWAY 84/35 NETWORK NODE 0071

MARKER BIS SKYLINE BLVD. WOODSIDE CA 94062

TITLE SHEET

DRAWN BY:	CHECKED BY:	APPROVED BY
VG	AF	KM
SHEET NUMBER		REVISION:
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1. THE CONTRACTOR SHALL BE RESPONSIBLE FOR SURVEY MONUMENTS AND/OR VERTICAL CONTROL BENCHMARKS WHICH ARE DISTURBED OR DESTROYED BY CONSTRUCTION. A LAND SURVEYOR MUST FIELD LOCATE, REFERENCE, AND/OR PRESERVE ALL HISTORICAL OR CONTROLLING MONUMENTS PRIOR TO ANY EARTHMORK. IF DESTROYED, SUCH MONUMENTS SHALL BE REPLACED WITH APPROPRIATE MONUMENTS BY A LAND SURVEYOR. A CORNER RECORD OR RECORD OF SURVEY, AS APPROPRIATE, SHALL BE FILED AS REQUIRED BY THE PROPRESSIONAL LAND SURVEYOR.

NUMBER BE ISSUED BEFORE A "PERMT TO EXCAVATE" WILL BE VALID. FOR YOUR DIG ALERT I.D. NUMBER, CALL UNDERGROUND SERVICE ALERT, TOLL FREE 1-800-422-4133, TWO DAYS BEFORE YOU DIG.

CROSS THE PROPOSED TRENCH LINE AND MUST MAINTAIN A 1' MINIMUM VERTICAL CLEARANCE.

4. IF ANY EXISTING HARDSCAPE OR LANDSCAPE INDICATED ON THE APPROVE PLANS IS DAMAGED OR REMOVED DURING DEMOLITION OR CONSTRUCTION, IT SHALL BE REPAIRED AND/OR REPLACED IN KIND PER THE APPROVED PLANS.

5. CONTRACTOR SHALL REPLACE OR REPAIR ALL TRAFFIC SIGNAL LOOPS, CONDUIT, AND LANE STRIPING DAMAGED DURING CONSTRUCTION.

6. THIS PROJECT WILL BE INSPECTED BY ENGINEERING AND FIELD ENGINEERING DIVISION

7. MANHOLES OR COVERS SHALL BE LABELED EXTENET

8. CONTRACTOR SHALL IMPLEMENT AN EROSION CONTROL PROGRAM DURING THE PROJECT CONSTRUCTION ACTIVITIES. THE PROGRAM SHALL MEET THE APPLICABLE REQUIREMENTS OF THE STATE WATER RESOURCE CONTROL

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USA North

Call Before you Dlg! 1-800-227-2600

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8. THE CONTRACTOR SHALL TUNNEL ALL CURB AND GUTTERS AND BORE ALL CONCRETE DRIVEWAYS AND WALKWAYS AT THE DIRECTION OF THE CITY, COUNTY OR STATE ENGINEER.

ALL A.C AND/OR CONCRETE PAVEMENT SHALL BE REPLACED AT THE DIRECTION OF THE CITY, COUNTY OR STATE ENGINEERS.

WORK, SHALL BE REPLANTED AND/OR REPLACED SO AS TO RESTORE THE WORK SITE TO ITS ORIGINAL CONDITION

11. THE CONTRACTOR WILL BE RESPONSIBLE FOR THE PROCESSING OF ALL APPLICANT PERMIT FORMS ALONG WITH THE REQUIRED LIABILITY INSURANCE FORMS. CLEARLY DEMONSTRATING THAT EXTENET, THE CITY, COUNTY OR STATE IS ALSO INSURED WITH THE REQUIRED LIABILITY INSURANCE IN THE AMOUNT OF \$1,000,000.00 FOR THIS

12. VAULTS, PEDESTALS, CONDUITS AND OTHER TYPES OF SUBSTRUCTURE ARE EITHER SPECIFIED ON THIS PLAN OR WILL BE SPECIFIED BY THE CONSTRUCTION ENGINEER. ANY AND ALL DEVIATIONS FROM THE SPECIFIED TYPES OF MATERIAL MUST BE APPROVED BY THE SYSTEM ENGINEER, IN WRITING BEFORE INSTALLATION THEREOF.

13. THE CONTRACTOR SHALL VERIFY THE LOCATION OF ALL EXISTING UTILITIES IN INCLUDING SEWER LATERALS & WATER SERVICES TO INDIVIDUAL LOTS BOTH VERTICAL AND HORIZONTAL PRIOR TO COMMENCING IMPROVEMENT

14. CONTRACTOR SHALL MAKE EXPLORATION EXCAVATIONS AND LOCATE EXISTING FACILITIES SUFFICIENTLY AHEAD OF CONSTRUCTION TO PERMIT REVISIONS TO PLANS IF REVISION IS NECESSARY BECAUSE OF LOCATION OF

15. THE LOCATIONS OF ALL EXISTING UTILITIES SHOWN ON THESE PLANS ARE FROM EXISTING RECORDS AND CORROBORATED, WHERE POSSIBLE, WITH FIELD TIES. THE CONTRACTOR IS RESPONSIBLE FOR CONFIRMING THE LOCATIONS SHOWN, BOTH HORIZONIAL AND VERTICALLY. PRIOR TO CONSTRUCTION, IF EXISTING LOCATIONS VAR SUBSTANTIALLY FROM THE PLANS. THE ENGINEER SHOULD BE NOTIFIED TO MAKE ANY CONSTRUCTION CHANGES

EROSION AND SEDIMENT CONTROL NOTES

TEMPORARY EROSION/SEDIMENT CONTROL PRIOR TO COMPLETION OF FINAL IMPROVEMENTS, SHALL BE PERFORMED BY THE CONTRACTOR OR QUALIFIED PERSON AS INDICATED BELOW:

1. ALL REQUIREMENTS OF THE CITY, COUNTY AND STATE "STORM WATER STANDARDS" MUST BE INCORPORATED INTO THE DESIGN AND CONSTRUCTION OF THE PROPOSED GRADING/IMPROVMENTS CONSISTENT WITH THE APPROVED STORM WATER POLLUTION PREVENTION PLAN (SWPPP), WATER QUALITY TECHNICAL REPORT (WQTR), AND/OR WATER POLLUTION CONTROL PLAN (WPCP).

2. FOR STORM DRAIN INLETS, PROVIDE A GRAVEL BAG SILT BASIN IMMEDIATELY UPSTREAM OF INLET AS INDICATED ON DETAILS.

3. FOR INLETS LOCATED AT SUMPS ADJACENT TO TOP OF SLOPES. THE CONTRACTOR SHALL ENSURE THAT WATER DRAINING TO THE SUMP IS DIRECTED INTO THE INLET AND THAT A MINIMUM OF 1.00° FREEBOARD EXISTS AND IS MAINTAINED ABOVE THE TOP OF THE INLET. IF FREEBOARD IS NOT PROVIDED BY GRADING SHOWN ON

4. THE CONTRACTOR OR QUALIFIED PERSON SHALL BE RESPONSIBLE FOR CLEANUP OF SILT AND MUD ON ADJACENT STREET(S) AND STORM DRAIN SYSTEM DUE TO CONSTRUCTION ACTIVITY.

5. THE CONTRACTOR OR QUALIFIED PERSON SHALL CHECK AND MAINTAIN ALL LINED AND UNLINED DITCHES AFTER EACH RAINFALL.

6. THE CONTRACTOR SHALL REMOVE SILT AND DEBRIS AFTER EACH MAJOR RAINFALL

B. THE CONTRACTOR SHALL RESTORE ALL EROSION/SEDIMENT CONTROL DEVICES TO WORKING ORDER TO THE SATISFACTION OF THE CITY ENGINEER OF RESIDENT ENGINEER AFTER EACH RUN-OFF PRODUCING RAINFALL.

). THE CONTRACTOR SHALL INSTALL ADDITIONAL EROSION/SEDIMENT CONTROL MEASURES AS MAY BE REQUIRED BY THE RESIDENT ENGINEER DUE TO UNCOMPLETED GRADING OPERATIONS OR UNFORESEEN CIRCUMSTANCES,

10. THE CONTRACTOR SHALL BE RESPONSIBLE AND SHALL TAKE NECESSARY PRECAUTIONS TO PREVENT PUBLIC TRESPASS ONTO AREAS WHERE IMPOUNDED WATERS CREATE A HAZARDOUS CONDITION.

11. ALL EROSION/SEDIMENT CONTROL MEASURES PROVIDED PER THE APPROVED GRADING PLAN SHALL BE INCORPORATED HERON. ALL EROSION/SEDIMENT CONTROL FOR INTERIM CONDITIONS SHALL BE DONE TO THE SATISFACTION OF THE RESIDENT ENGINEER.

12. GRADED AREAS AROUND THE PROJECT PERIMETER MUST DRAIN AWAY FROM THE FACE OF THE SLOPE AT THE CONCLUSION OF EACH WORKING DAY.

13. ALL REMOVABLE PROTECTIVE DEVICES SHOWN SHALL BE IN PLACE AT THE END OF EACH WORKING DAY WHEN RAIN IS IMMINENT.

14. THE CONTRACTOR SHALL ONLY GRADE, INCLUDING CLEARING AND GRUBBING FOR THE AREAS FOR WHICH THE CONTRACTOR OR QUALIFIED PERSON CAN PROVIDE EROSION/SEDIMENT CONTROL MEASURES.

15. THE CONTRACTOR SHALL ARRANGE FOR WEEKLY MEETINGS DURING OCTOBER 1ST TO APRIL 30TH FOR PROJECT TEAM (GENERAL CONTRACTOR, QUALIFIED PERSON, EROSION CONTROL SUBCONTRACTOR IF AN, ENGINEER OF WORK, OWNER/DEVELOPER AND THE RESIDENT ENGINEER) TO EVALUATE THE ADEQUACY OF THE EROSION/SEDIMENT CONTROL MEASURE AND OTHER RELATED CONSTRUCTION ACTIVITIES.

ANTENNA & CABLE SCHEDULE

MAKE / MODEL


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KATHREIN

3030 WARRENVILLE RD. LISLE, IL 60532 www.extenet.com

	REV.	DATE	DESCRIPTION
	3	02/08/10	REVISION PER CALTRANS COMMENTS
	2	01/05/10	REVISION PER PG&E DESIGN CHANGE
1		11/11/09	REVISION PER EXTENET REQUESTED RAD CENTER CHANGE

CURRENT ISSUE DATE

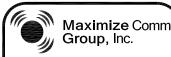

1351 POMONA ROAD SUITE 100 CORONA, CA 92882 OFFICE: (909) 786-2170 FAX: (909) 992-3113

2

CABLE SIZE

1/2"

1/2"

2

2

51'-1'

HWY8435-007B

SITE NAME & ADDRESS:

11GHWAY 84/35 NETWORK NODE OO7B

MARKER BIS SKYLINE BLVD. WOODSIDE, CA 94062

IENERAL NOTES & SCHEDULE

DRAWN BY: VG	CHECKED BY: AF	APPROVED BY:
SHEET NUMBER:	T2	REVISION:

GENERAL NOTES

1. 120/240 POWER REQUIRED FOR 3-WIRE SERVICE.
2. GC TO REMOVE/CLEAN ALL DEBRIS, NAILS, STAPLES, OR NON-USED VERTICALS OFF THE POLE.
3. ALL CONSTRUCTION SHALL BE IN ACCORDANCE WITH MUNICIPAL, COUNTY, STATE, FEDERAL, GO95 AND G0128 STANDARDS AND REQUILATIONS.
4. CALL USA 48 HOURS PRIOR TO EXCAVATING AT (800) 422-4133.
5. ALL LANDSCAPING TO BE RESTORED TO ORIGINAL CONDITION OR BETTER.
6. ALL EQUIPMENT TO BE BONDED.

7. METERING CABINET REQUIRES 3'[.914M] CLEARANCE AT DOOR OPENING. 8. CAULK CABINET BASE AT PAD.

STANDARD GROUNDING NOTES:

5/8"x8"[.016x2.44M] ROD, CAD WELD BELOW GRADE

#6 GROUND AND BOND WIRE . WOOD MOLDING, STAPLED EVERY 3'[.914M] AND AT EACH END . GROUNDS 3'[.914M] FROM POLE.

6. PLACE 3 #10GA WIRES FROM BREAKER TO METER BOX.

STANDARD CONDUIT NOTES:

1. FOR UNDERGROUND USE SCHEDULE 40.
2. FOR RISERS USE SCHEDULE 80.
3. PLACE 2"[.051M] GALVANIZED STEEL CONDUIT FOR ANY CONDUIT UNDER 3"[.076M], STUB UP 10"[3.04M] THEN CONVERT TO SCHEDULE 80.
4. CONVERT 4"[.102M] CARRIER CONDUIT TO 3"[.076M] AT BASE OF POLE.
5. GC TO STUB UP POLE 10"[3.04M] w/3" POWER CONDUIT, POWER CO. TO CONVERT TROM 3"[.076M] SCH. 80 TO 2"[.051M] SCH. 80 FROM TOP OF STUB UP.

ALL CONDUIT WILL BE MAN DRILLED AND EQUIPPED WITH 3/8"[.010M] PULL ROPE.

MAINTAIN 40"[1.02M] MINIMUM COVER FOR ELECTRICAL CONDUIT.
 MAINTAIN 30"[7.62M] MINIMUM COVER FOR COMMUNICATIONS CONDUIT.
 SAND SHADING MINIMUM 1"[0.025M] UNDER CONDUITS, AND 6"[1.152M] COVERING ON TOP REQUIRED.
 ALL ELECTRICAL SERVICE CONDUITS FROM POWER COMPANY, WHETHER FROM POLES, TRANSFORMERS, OR OTHER LOCATIONS; WILL BE SLURRY BACKELIES.

5. IN STREET SLURRY TO GRADE AND MILL DOWN 1-1/2"[.038M] FOR AC CAP. 6. IN DIRT SLURRY 18"[.457M] FROM GRADE, AND FILL WITH 95% COMPACTION NATIVE SOIL FOR BALANCE.

PLACE WARNING TAPE IN TRENCH 12"[.305M] ABOVE ALL CONDUITS AND #18 WARNING TAPE ABOVE GROUND RING.

. NO BOLT THREADS TO PROTRUDE MORE THAN 1-1/2"[.038M]. . FILL ALL HOLES LEFT IN POLE FROM REARRANGEMENT OF CLIMBERS.

ALL CLIMB STEPS NEXT TO CONDUIT SHALL HAVE EXTENDED STEPS.

4. CABLE NOT TO IMPEDE 15"[.381M] CLEAR SPACE OFF POLE FACE

4. CABLE NOT TO IMPEDE 151_ASTIM] CLEAR SPACE OFF POLE FACE (12:00).
5. 90' SHORT SWEEPS UNDER ANTENNA ARM. ALL CABLES MUST ONLY TRANSITION ON THE INSIDE OR BOTTOM OF ARMS (NO CABLE ON TOP OF ARMS).
6. USE CABLE CLAMPS TO SECURE CABLE TO ARMS; PLACE 2"[0.51 M] CARRIER CABLE ID TAGS ON BOTH SIDES OF ARMS.
7. USE 90' CONNECTOR AT CABLE CONNECTION TO ANTENNAS.
8. PLACE GPS ON ARM WITH SOUTHERN SYLEXPOSURE AT MINIMUM.

S'[1.83M] FROM TRANSMIT ANTENNA, WHICH IS 24"[.61M] AWAY FROM CENTER OF POLE.

9. USE 1/2"[.013M] CABLE ON ANTENNAS UNLESS OTHERWISE 10. FILL VOID AROUND CABLES AT CONDUIT OPENING WITH FOAM SEALANT TO PREVENT WATER INTRUSION.

ANTENNA/WOOD ARM AREA TOTAL	77.48 SQ. FT.	
TOP GRADE	32'-9"	
BOTTOM GRADE	28'-5"	
METER/BREAKER AREA TOTAL	4.33 SQ. FT.	
TOP GRADE	8'-0"	
BOTTOM GRADE	7'-0"	
BATTERY BACK-UP AREA TOTAL	16.25 SQ. FT.	
TOP GRADE	11'-8"	
BOTTOM GRADE	9'-6"	
DELTA DECK AREA TOTAL	10.74 SQ. FT.	
TOP GRADE	14'-7"	
BOTTOM GRADE	12'-5"	
DELTA DECK (FUT.) AREA TOTAL	10.74 SQ. FT.	
TOP GRADE	17'-6"	
BOTTOM GRADE	15'-4"	
EXT. RISER SIZE	4"ø	
EXT. RISER LENGTH	15'-1"	
EXT. RISER BTM GRADE	14'-5"	
PWR RISER SIZE	1"ø	
PWR RISER LENGTH	10'-10"	
PWR RISER BTM GRADE	8'-4"	

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ANTENNA SECTOR

AI PHA

SECTOR

AZIMUTH


223

THICK(NESS)

WOOD

TOP OF PLATE (PARAPET)
TOP OF STEEL (SLAB)
TOP OF WALL

TOP OF WALL
TYPICAL
UNDER GROUND
UNDERWRITERS LABORATORY
UNLESS NOTED OTHERWISE
VERIFY IN FIELD
WIDE(WIDTH)
WITH

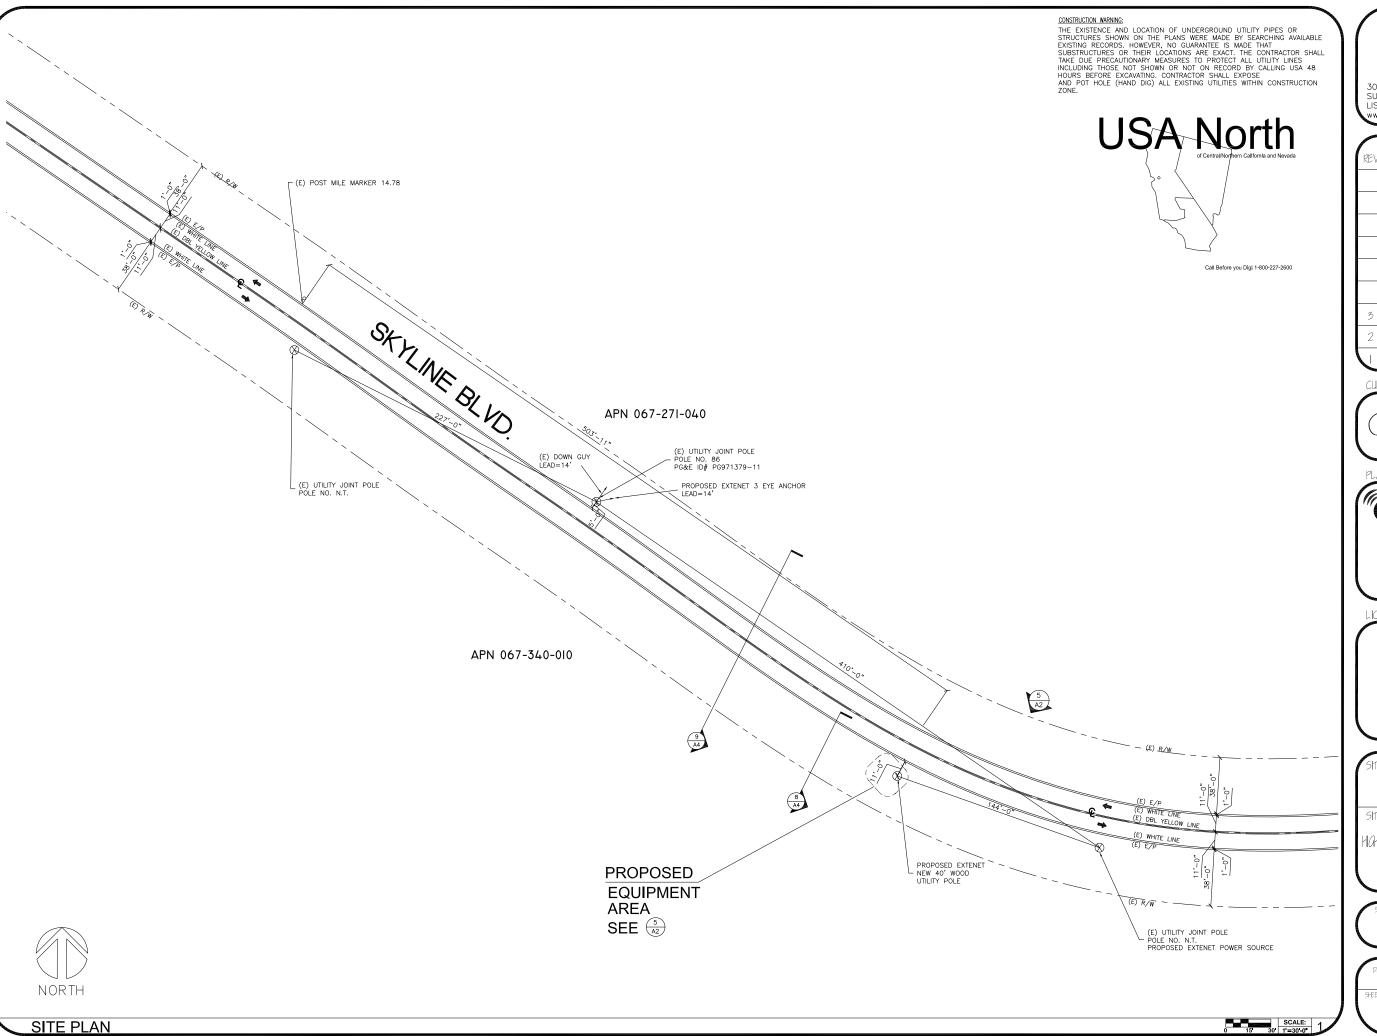



REV.	DATE	DESCRIPTION
3	02/08/10	REVISION PER CALTRANS COMMENTS
2	01/05/10	REVISION PER PG&E DESIGN CHANGE
	11/11/09	REVISION PER EXTENET REQUESTED RAD CENTER CHANGE

CURRENT ISSUE DATE:

02/08/10

PLANS PREPARED BY:



1351 POMONA ROAD SUITE 100 CORONA, CA 92882 OFFICE: (909) 786-2170 FAX: (909) 992-3113

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LICENSURE:

SITE NO.:

HWY8435-007B

SITE NAME & ADDRESS:

HIGHWAY 84/35 NETWORK NODE OO7B

MARKER BIS SKYLINE BLVD. WOODSIDE, CA 94062

SHEET 11

SITE PLAN

DRAWN BY:	CHECKED BY:	APPROVED BY
VG SHEET NUMBER:	AF AF	REVISION:

EXTENET MAKE-READY

- INSTALL 40', CLASS 2, DOUGLAS FIR UTILITY POLE, PER SITE PLAN.
- PER SITE PLAN.

 2. FLUSH MOUNT 4" PANEL ANTENNAS TOP AT 32'-2" GRADE. SECOND SET 1' BELOW PER ELEVATION.

 3. INSTALL DELTA NODE RADIOS, BATTERY BACK-UP, METER AND ELEC. ENCLOSURE AT 3:00 POSITION W/MIN. 4" SPACING FROM POLE.

 4. INSTALL 4" PVC SCH. 40 COAX RISER AT 2:00 POSITION.

MAKE-READY NOTES

POWER MAKE-READY

- STRING IN SECONDARY POWER PER POWER DESIGN
 (SEE SITE PLAN/POWER DESIGN)
 INSTALL 1" PVC SCH. 80 RISER W/WEATHER HEAD AT
- 1:00 (QUAD 4) POSITION.
- 3. PROVIDE 120/240V, 3-WIRE, SINGLE PHASE 100 AMP SERVICE TO 1" PG&E RISER TO EXTENET METER BOX FROM SECONDARY POWER.



3030 WARRENVILLE RD. SUITE 340 LISLE, IL 60532 www.extenet.com

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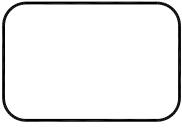


PLANS PREPARED BY:



1351 POMONA ROAD SUITE 100 CORONA, CA 92882 OFFICE: (909) 786-2170 FAX: (909) 992-3113

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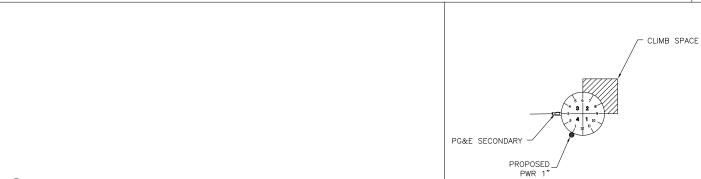



HWY8435-007B SITE NAME & ADDRESS: HIGHWAY 84/35 NETWORK NODE OO7E MARKER BIS SKYLINE BLVD.


WOODSIDE, CA 94062

ELEVATIONS & RISER DETAILS

VG SHEET NUMBER	AF A	KM REVISION:
	AZ	3




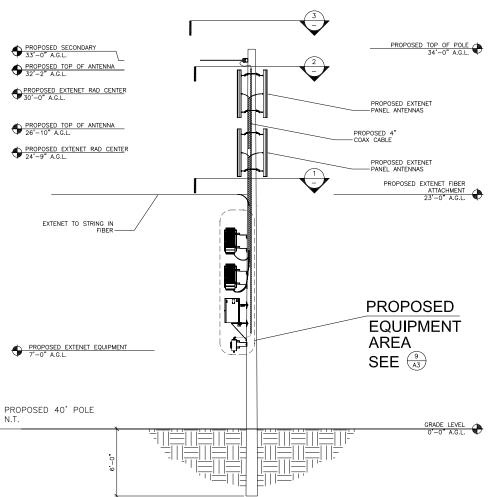

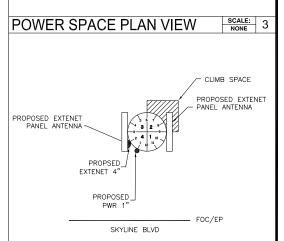

SKYLINE BLVD


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SKYLINE BLVD

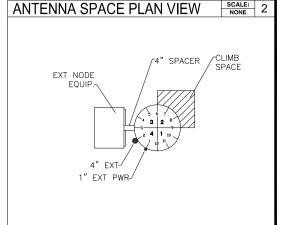SCALE: 5 NODE POLE RISER DETAIL NONE 1

NORTH EAST POLE ELEVATION



REV.	DATE	DESCRIPTION
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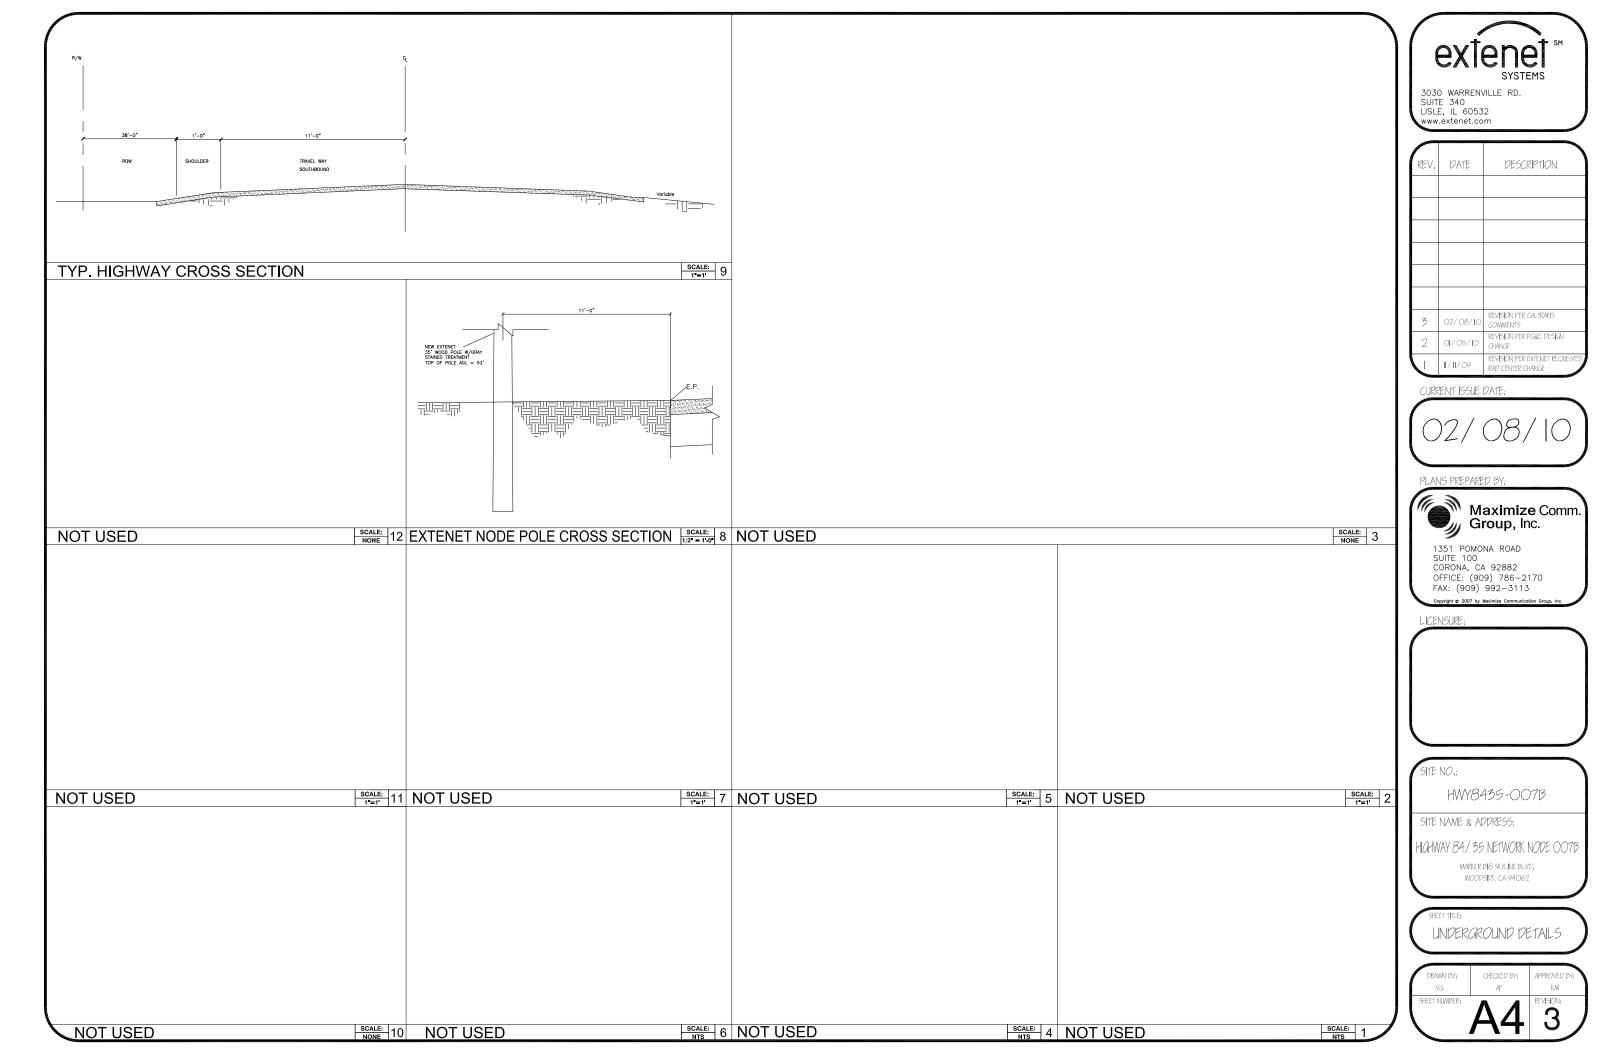


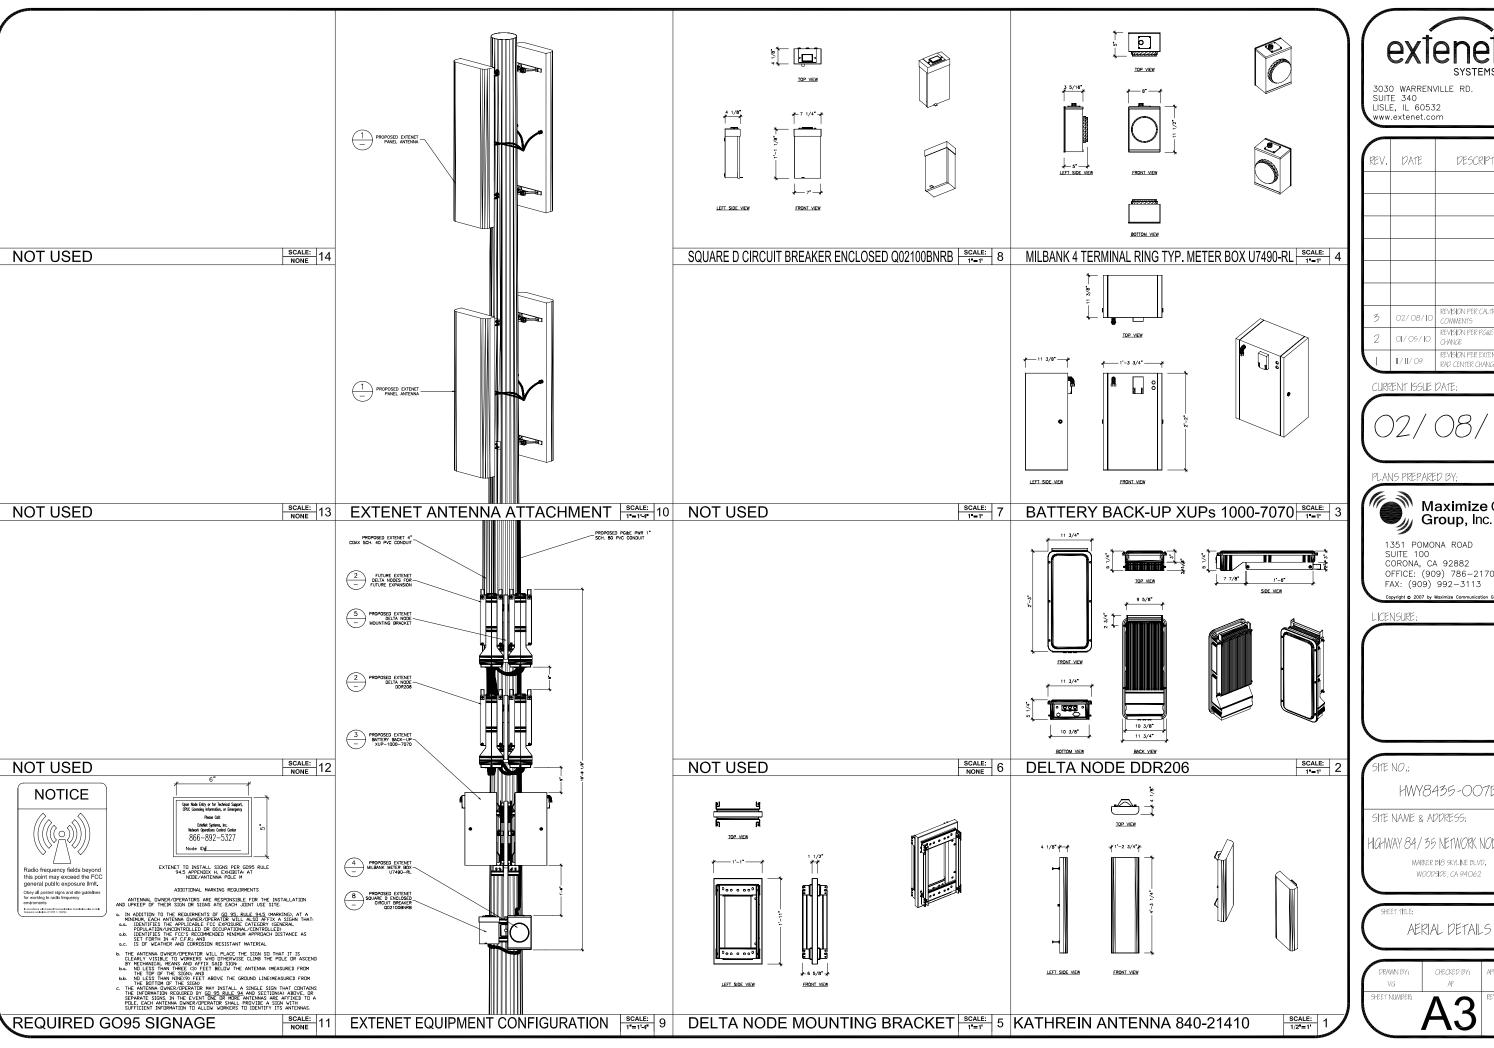HWY8435-007B

HGHWAY 84/35 NETWORK NODE OO7E

WOODSIDE, CA 94062

	SHEET NUMBER:	A3	8EVISION: 3
1	DRAWN BY: VG	CHECKED BY: AF	APPROVED BY:





SYSTEMS


HWY 35 - PROJECT HWY8435 - 008B

POST MILE MARKER 14.37

LOOKOUT POINT SKYLINE BLVD.

WOODSIDE, CA 94062

EXTENET SYSTEMS, INC. 3030 WARRENVILLE RD. SUITE 340 LISLE, IL 60532 CONTACT JEFF FRYE PHONE 480-626-1271 FAY 504-295-1803

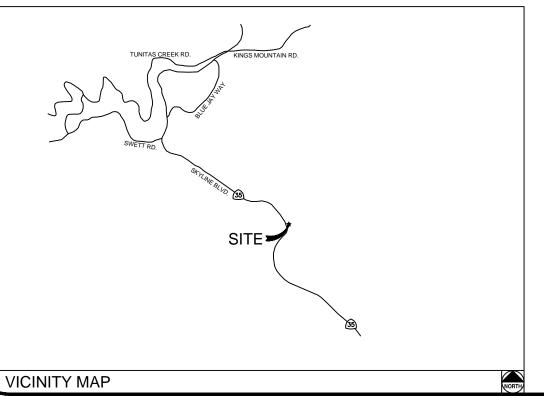

CLIENT

EXTENET SYSTEMS, INC. 3030 WARRENVILLE RD. SUITE 340 LISLE, IL 60532 CONTACT JEFF FRYE PHONE 480-626-1271 FAX 504-285-1603

ENGINEERING FIRM/SURVEYING

ADVANCED COMMUNICATIONS INC. 5711 RESEARCH DR. CANTON, MI 48188 CONTACT EDWARD DOUGHERTY PHONE 734-467-8121

COORDINATES

LAT: 37.4109

CODE COMPLIANCE:

ALL WORK AND MATERIALS SHALL BE PERFORMED & INSTALLED IN ACCORDANCE WITH THE CURRENT EDITIONS O THE FOLLOWING CODES AS ADOPTED BY LOCAL GOVERNING AUTHORITIES AND LOCAL/CITY/COUNTY ORDINANCES:

1. CALIFORNIA ADMINISTRATIVE CODE (INCLUDING TITLE 24 &

- 2. 2007 CALIFORNIA BUILDING CODE.
- 3. 2007 CALIFORNIA ELECTRICAL CODE.
- 3. BUILDING OFFICIALS AND CODE ADMINISTRATORS (BOCA).
- 4. UNIFORM PLUMBING & MECHANICAL CODES.
- 5. ANSI/EIA-222-F LIFE SAFETY CODE.
- 6. CALIFORNIA GENERAL ORDER 95, 128 & 165.

	SHEET INDEX
SHEET	DESCRIPTION
T1	TITLE SHEET
T2	GENERAL CONSTRUCTION NOTE & ANTENNA CABLE SCHEDULE
A1	SITE PLAN
A2	UTILITY POLE ELEVATIONS/RISER DETAILS
A3	AERIAL DETAILS
A4	UNDERGROUND DETAILS



3030 WARRENVILLE RD. SUITE 340 LISLE, IL 60532 www.extenet.com

REV.	DATE	DESCRIPTION
	11/11/09	REVISION PER EXTENET REQUESTED PAD CENTER CHANGE
2	01/05/10	REVISION PER PAGE DESIGN CHANGE
3	02/08/10	REVISION PER CALTRANS COMMENTS
4	04/26/10	REVISION PER CALTRANS COMMENTS
5	/ 3/	REVISION PER CALTRANS COMMENTS
6	07/25/11	REVISION PER CALTRANS EQUIPMENT ORIENTATION

CURRENT ISSUE DATE:

07/25/11

PLANS PREPARED BY



LICENSURE

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SITE NO

HWY8435-008B

SITE NAME & ADDRESS:


HIGHWAY 84/ 35 NETWORK NODE 0081

LOOKOUT POINT SKYLINE BLVD WOODSIDE, CA 94062

SUPER THE E.

111LE SHEET

DRAWN BY: CHECKED BY: APPROVED BY:
.
SHEET NUMBER: REVISION:

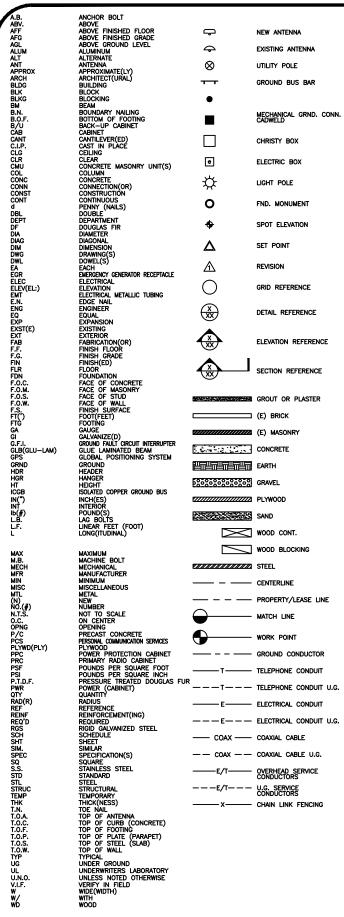

- The contractor shall be responsible for survey monuments and/or vertical control bedichiaris which are disturbed or destroyed by construction. A land surveyor must field locate, reference, and/or preserve all historica, or controlling monuments pigner to any earthwork. If destroyed, such monuments shall be replaced with appropriate monuments by a land surveyor. A
- 2. Important notice: Section 4215 of the government code requires a dig alert identification number be issued before a "permt to excavate" will be valid. For your dig alert 1.d. number, call underground service alert, toll free 1–800–422–4133, two days before you dig.
- 3. CONTRACTOR SHALL BE RESPONSIBLE FOR THE POT HOLE AND LOCATING OF ALL EXISTING UTILITIES THAT cross the proposed trench line and must maintain a 1' minimum vertical clearance.
- 4. If any existing hardscape or landscape indicated on the approve plans is damaged or removed during demolition or construction, it shall be repaired and/or replaced in kind per the approved plans.
- $5.\,$ contractor shall replace or repair all traffic signal loops, conduit, and lane striping damaged during construction.
- 6. THIS PROJECT WILL BE INSPECTED BY ENGINEERING AND FIELD ENGINEERING DIVISION.
- 7. MANHOLES OR COVERS SHALL BE LABELED EXTENET.
- Contractor shall implement an erosion control program during the project construction activities. The program shall meet the applicable requirements of the state water resource control
- The contractor shall have emergency materials and equipment on hand for unforeseen stidations, such as damage to underground water, sewer, and storm drain facilities whereby flows may delekate crosion and sediment pollutions.

USA North

GENERAL NOTES

7. METERING CABINET REQUIRES $3^{\circ}[.914\text{M}]$ CLEARANCE AT DOOR OPENING. 8. CAULK CABINET BASE AT PAD.

2. FUK KISENS USE SCHEDULE 80.

3. PLACE 2"[.051M] GALVANIZED STEEL CONDUIT FOR ANY CONDUIT UNDER 3"[.076M], STUB UP 10"[3.04M] THEN CONVERT TO SCHEDULE 80.

4. CONVERT 4"[.102M] CARRIER CONDUIT TO 3"[.076M] AT BASE OF POLE.

5. GC TO STUB UP POLE 10"[3.04M] w/3" POWER CONDUIT, POWER CO. TO CONVERT FROM 3"[.076M] SCH. 80 TO 2"[.051M] SCH. 80 FROM TOP OF STUB UP.

ALL CONDUIT WILL BE MAN DRILLED AND EQUIPPED WITH 3/8"[.010M] PULL ROPE.

. MAINTAIN 40"[1.02M] MINIMUM COVER FOR ELECTRICAL CONDUIT.

. MAINTAIN 30"[.762M] MINIMUM COVER FOR COMMUNICATIONS CONDUIT.

SAND SHADING MINIMUM 1"[.025M] UNDER CONDUITS, AND 6"[.152M] COVERING ON TOP REQUIRED.

COVERING ON TOP REQUIRED.

4. ALL ELECTRICAL SERVICE CONDUITS FROM POWER COMPANY, WHETHER FROM POLES, TRANSFORMERS, OR OTHER LOCATIONS; WILL BE SLURRY BACKFILLED.

5. IN STREET SLURRY TO GRADE AND MILL DOWN 1-1/2_T.038MJ FOR AC CAP.

6. IN DIRT SLURRY 18_1.457MJ FROM GRADE, AND FILL WITH 95% COMPACTION.

ANTIVE SOIL FOR BALANCE.

PLACE WARNING TAPE IN TRENCH 12"[.305M] ABOVE ALL CONDUITS AND #18 WARNING TAPE ABOVE GROUND RING.

. GROUND TESTED AT 5 OHMS OR LESS. 2. 5/8"x8"[.016x2.44M] ROD, CAD WELD BELOW GRADE

FOR UNDERGROUND USE SCHEDULE 40. FOR RISERS USE SCHEDULE 80.

3. #6 GROUND AND BOND WIRE.
4. WOOD MOLDING, STAPLED EVERY 3'[.914M] AND AT EACH END
5. GROUNDS 3'[.914M] FROM POLE.
6. PLACE 3 #10GA WIRES FROM BREAKER TO METER BOX.

ROW GROUND CONSTRUCTION NOTES:

Call Before you Dig! 1-800-227-2600

1. 120/240 POWER REQUIRED FOR 3-WIRE SERVICE.
2. GG TO REMOVE/CLEAN ALL DEBRIS, NAILS, STAPLES, OR NON-USED VERTICALS OFF THE POLE.
3. ALL CONSTRUCTION SHALL BE IN ACCORDANCE WITH MUNICIPAL, COUNTY, STATE, FEDERAL, GO95 AND G0128 STANDARDS AND REGULATIONS.
4. CALL USA 48 HOURS PRIOR TO EXCAVATING AT (800) 422-4133.
5. ALL LADSACPING TO BE RESTORED TO ORIGINAL CONDITION OR BETTER.
6. ALL EQUIPMENT TO BE BONDED.
7. METERING CARRINET PEOPLIPES 3¹⁷ G14AU] CLEARANCE AT DOOR OPENING.
5. 90' SHORT SWEEPS UNDER ANTENNA ARM. ALL CABLES MUST

ROW UTILITY POLE CONSTRUCTION NOTES:

4. CABLE NOT TO IMPEDE 15"[.381M] CLEAR SPACE OFF POLE FACE

ONLY TRANSITION ON THE INSIDE OR BOTTOM OF ARMS (NO CABLE ON TOP OF ARMS).

6. USE CABLE CLAMPS TO SECURE CABLE TO ARMS; PLACE 2T.051M] CAPRIER CABLE ID TAGS ON BOTH SIDES OF ARMS.

7. USE 90' CONNECTOR AT CABLE CONNECTION TO ANTENNAS.

8. PLACE GPS ON ARM WITH SOUTHERN SKY EXPOSURE ATMINIMUM 6T.18.3M] FROM TRANSMIT ANTENNA, WHICH IS 24*[-6.1M] AWAY FROM CENTER OF POLE.

9. USE 1,2*[-7.013M] CABLE ON ANTENNAS UNLESS OTHERWISE SPECIFIED.

10. FILL VOID AROUND CABLES AT CONDUIT OPENING WITH FOAM SEALANT TO PREVENT WATER INTRUSION.

(12:00).
5. 90° SHORT SWEEPS UNDER ANTENNA ARM. ALL CABLES MUST ONLY TRANSITION ON THE INSIDE OR BOTTOM OF ARMS (NO

- 1. Indemnification clause: The contractor agrees and shall:
 Assume sole and complete responsibility of the job site conditions during the course of
 Construction of this prolect, including the safety of all persons and properties. That these
 Requirements shall apply continuously and not be limited to normal working hours and conditions.
 The contractor further agrees to defend indemnity and hold extent, representatives, and
 Engineers Harmless from any and all liability, real or alleged in connection with the performance
 of the work on this properties.
- 2. PRIOR TO THE BEGINNING OF ANY CONSTRUCTION AND THROUGHOUT THE COURSE OF CONSTRUCTION WORK, THE CONTRACTOR SHALL FULLY COMPLY WITH "CALIFORNIA OCCUPATIONAL SAFETY AND HEALTH" ACT OF 1973 INCLUDING ALL REVISIONS AND AMENDMENTS THERETO.
- 3. ALL WORK SHALL CONFORM TO THE LATEST EDITIONS OF G095,128 AND THE STANDARD "SPECIFICATIONS FOR PUBLIC WORKS CONSTRUCTION" AS ADOPTED BY THE CITY, COUNTY OR STATE AS MODIFIED BY STANDARD PLANS MAD ADDRESSED FOR THE CITY.
- 4. THE EXISTENCE AND LOCATION OF UTILITIES AND OTHER AGENCY'S FACILITIES AS SHOWN HERON ARE OBTAINED BY A SEARCH OF AVAILABLE RECORDS. OTHER FACILITIES MAY EXIST. THE CONTRACTOR SHALL VERIFY PRIOR TO THE START OF CONSTRUCTION AND SHALL USE EXTREME CARE AND PROTECTIVE MEASURES TO PREVENTED TOWNER TO THESE FACILITIES. THE CONTRACTOR IS RESPONSIBLE FOR THE PROTECTION OF ALL UTILITY OR AGENCY FACILITIES WITHIN THE LIMITS OF WORK, WHETHER THEY ARE SHOWN ON THIS PLAN OR NOT.
- 5. THE CONTRACTOR SHALL NOTIFY THE CITY, COUNTY OR STATE ENGINEER INSPECTION DEPARTMENT, AT LEAST TWO DAYS BEFORE START OF ANY WORK REQUIRING THEIR INVOLVEMENT.
- 6. The city, county or state shall specify the expiration period of the permit for this construction project.
- 7. THE MINIMUM COVER FOR ALL CONDUITS PLACED UNDERGROUND SHALL BE 36 INCHES TO THE FINISHED
- 8. THE CONTRACTOR SHALL TUNNEL ALL CURB AND GUTTERS AND BORE ALL CONCRETE DRIVEWAYS AND WALKWAYS AT THE DIRECTION OF THE CITY, COUNTY OR STATE ENGINEER.
- 9. ALL A.C AND/OR CONCRETE PAVEMENT SHALL BE REPLACED AT THE DIRECTION OF THE CITY, COUNTY OR STATE ENGINEERS.
- 10. ALL SHRUBS, PLANTS OR TREES THAT HAVE BEEN DAMAGED OR DISTURBED DURING THE COURSE OF THE WORK, SHALL BE REPLANTED AND/OR REPLACED SO AS TO RESTORE THE WORK SITE TO ITS ORIGINAL CONDITION.
- 11. THE CONTRACTOR WILL BE RESPONSIBLE FOR THE PROCESSING OF ALL APPLICANT PERMIT FORMS ALONG WITH HER REQUIRED LABILITY INSURANCE FORMS, CLEARLY DEMONSTRATING THAT EXTENET, THE CITY, COUNTY OR STATE IS ALSO INSURED WITH THE REQUIRED LIABILITY INSURANCE IN THE AMOUNT OF \$1,000,000.00 FOR THIS CONSTRUCTION PROJECT.
- 12. VAULTS, PEDESTALS, CONDUITS AND OTHER TYPES OF SUBSTRUCTURE ARE EITHER SPECIFIED ON THIS PLAN OR WILL BE SPECIFIED BY THE CONSTRUCTION ENGINEER. ANY AND ALL DEVATIONS FROM THE SPECIFIED TYPES OF MATERIAL MUST BE APPROVED BY THE SYSTEM ENGINEER, IN WRITING BEFORE INSTALLATION THEREOF.
- 13. THE CONTRACTOR SHALL VERIFY THE LOCATION OF ALL EXISTING UTILITIES IN INCLUDING SEWER LATERALS & WATER SERVICES TO INDIVIDUAL LOTS BOTH VERTICAL AND HORIZONTAL PRIOR TO COMMENCING IMPROVEMENT
- 14. CONTRACTOR SHALL MAKE EXPLORATION EXCAVATIONS AND LOCATE EXISTING FACILITIES SUFFICIENTLY AHEAD OF CONSTRUCTION TO PERMIT REVISIONS TO PLANS IF REVISION IS NECESSARY BECAUSE OF LOCATION OF EXISTING UTILITIES.
- 15. THE LOCATIONS OF ALL EXISTING UTILITIES SHOWN ON THESE PLANS ARE FROM EXISTING RECORDS AND CORROBORATED, WHERE POSSIBLE, WITH FIELD TIES. THE CONTRACTOR IS RESPONSIBLE FOR CONFIRMING THE LOCATIONS SHOWN, BOTH HORIZOTATA, AND VERTICALLY, PRIOR TO CONSTRUCTION, IF EXISTING LOCATIONS WAY SUBSTANTIALLY PROM THE PLANS. THE ENGINEER SHOULD BE NOTIFIED TO MAKE ANY CONSTRUCTION CHANGES

WIND LOADING INFORMATION

23'-11"

4.33 SQ. FT.

7'-0"

16,25 SQ, FT,

11'-8"

9'-6"

10.74 SQ. FT.

14'-7"

12'-5"

10.74 SQ. FT.

17'-6"

15'-4"

4"-ø

28'-1"

14'-5"

16'-0" 7'-0"

ANTENNA/WOOD ARM AREA

TOP GRADE

TOP GRADE

BOTTOM GRADE

TOP GRADE

DELTA DECK AREA TOTAL

TOP GRADE

TOP GRADE

BOTTOM GRADI

EXT. RISER SIZE

EXT. RISER LENGTH

PWR RISER SIZE PWR RISER LENGTH

EXT. RISER BTM GRADE

PWR RISER BTM GRADE

BOTTOM GRADE

DELTA DECK (FUT.) AREA TOTAL

BOTTOM GRADI

BOTTOM GRADI

- TEMPORARY EROSION/SEDIMENT CONTROL PRIOR TO COMPLETION OF FINAL IMPROVEMENTS, SHALL BE PERFORMED BY THE CONTRACTOR OR QUALIFIED PERSON AS INDICATED BELOW:
- 1. ALL REQUIREMENTS OF THE CITY, COUNTY AND STATE "STORM WATER STANDARDS" MUST BE INCORPORATED INTO THE DESIGN AND CONSTRUCTION OF THE PROPOSED GRADING/IMPROVMENTS CONSISTENT WITH THE APPROVED STORM WATER POLLUTION PREVENTION PLAN (SWPPP), WATER QUALITY TECHNICAL REPORT (WQTR), AND/OR WATER POLLUTION CONTROL PLAN (WPCP).
- 2. FOR STORM DRAIN INLETS, PROVIDE A GRAVEL BAG SILT BASIN IMMEDIATELY UPSTREAM OF INLET AS INDICATED ON DETAILS.
- 3. FOR INLETS LOCATED AT SUMPS ADJACENT TO TOP OF SLOPES, THE CONTRACTOR SHALL ENSURE THAT WATER DRAINING TO THE SUMP IS DIRECTED INTO THE INLET AND THAT A MINIMUM OF 1.00' FREEBOARD EXISTS AND IS MANTAINED ABOVE THE TOP OF THE INLET. IF FREEBOARD IS NOT PROVIDED BY GRADING SHOWN ON THESE PLANS THE CONTRACTOR SHALL PROVIDE IT VIA TEMPORARY MEASURES, I.E. GRAZEL BAGS OR DIKES.
- 4. THE CONTRACTOR OR QUALIFIED PERSON SHALL BE RESPONSIBLE FOR CLEANUP OF SILT AND MUD ON ADJACENT STREET(S) AND STORM DRAIN SYSTEM DUE TO CONSTRUCTION ACTIVITY.
- 5. The contractor or qualified person shall check and maintain all lined and unlined ditches after each rainfall.
- 6. THE CONTRACTOR SHALL REMOVE SILT AND DEBRIS AFTER EACH MAJOR RAINFALL
- 7. EQUIPMENT AND WORKERS FOR EMERGENCY WORK SHALL BE MADE AVAILABLE AT ALL TIMES DURING THE RAINY SEASON. ALL NECESSARY MARRIALS SHALL BE STOCKPILED ON STIE AT CONVENIENT LOCATIONS TO FELICIDATE RAPID CONSTRUCTION OF TEMPORALY DEVICES WHEN RAIN IS MININGLY.
- 8. THE CONTRACTOR SHALL RESTORE ALL EROSION/SEDIMENT CONTROL DEVICES TO WORKING ORDER TO THE SATISFACTION OF THE CITY ENGINEER OF RESIDENT ENGINEER AFTER EACH RUN-OFF PRODUCING RAINFALL.
- 9. THE CONTRACTOR SHALL INSTALL ADDITIONAL EROSION/SEDIMENT CONTROL MEASURES AS MAY BE REQUIRED BY THE RESIDENT ENGINEER DUE TO UNCOMPLETED GRADING OPERATIONS OR UNFORESEEN CIRCUMSTANCES,
- THE CONTRACTOR SHALL BE RESPONSIBLE AND SHALL TAKE NECESSARY PRECAUTIONS TO PREVENT PUBLIC TRESPASS ONTO AREAS WHERE IMPOUNDED WATERS CREATE A HAZARDOUS CONDITION.
- 11. ALL EROSION/SEDIMENT CONTROL MEASURES PROVIDED PER THE APPROVED GRADING PLAN SHALL BE INCORPORATED HERON. ALL EROSION/SEDIMENT CONTROL FOR INTERIM CONDITIONS SHALL BE DONE TO THE SATISFACTION OF THE RESIDENT ENGINEER.
- 12. GRADED AREAS AROUND THE PROJECT PERIMETER MUST DRAIN AWAY FROM THE FACE OF THE SLOPE AT THE CONCLUSION OF EACH WORKING DAY.
- 13. ALL REMOVABLE PROTECTIVE DEVICES SHOWN SHALL BE IN PLACE AT THE END OF EACH WORKING DAY
- 14. THE CONTRACTOR SHALL ONLY GRADE, INCLUDING CLEARING AND GRUBBING FOR THE AREAS FOR WHICH THE CONTRACTOR OR QUALIFIED PERSON CAN PROVIDE EROSION/SEDIMENT CONTROL MEASURES.
- 15. THE CONTRACTOR SHALL ABRANCE FOR WEEKLY MEETINGS DURING OCTOBER 1ST TO APRIL 30TH FOR PROJECT TEAM (GENERAL CONTRACTOR, QUALIFIED PERSON, EROSION CONTROL SUBCONTRACTOR IF AN, ENGINEER OF WORK, OWNER/DEVELOPER AND THE RESIDENT ENGINEER) TO EVALUATE THE ADEQUACY OF THE

ANTENNA & CABLE SCHEDULE

44'-5'

44'-5'

KATHREIN

840 21410

<u>Note:</u> Contractor to field verify cable lengths prior to ordering, fabrication, or installation of cables.

3030 WARRENVILLE RD. SUITE 340 LISLE, IL 60532 www.extenet.com

l	REV.	DATE	DESCRIPTION
	I	11/11/09	REVISION PER EXTENET REQUESTED PAD CENTER CHANGE
	2	01/05/10	REVISION PER PAGE DESIGN CHANGE
П	3	02/08/10	REVISION PER CALTRANS COMMENTS
П	4	04/26/10	REVISION PER CALTRANS COMMENTS
	5	/ 3/	REVISION PER CALTRANS COMMENTS
	6	07/25/11	REVISION PER CALTRANS EQUIPMENT ORIENTATION
П			

CURRENT ISSUE DATE

PLANS PREPARED BY



Canton, MI 48188

SITE NAME & ADDRESS:

HIGHWAY 84/ 35 NETWORK NODE OOSE

CABLE SIZE

1/2"

1/2"

2

2

HWY8435-008B

LOOKOUT POINT SKYLINE BLVD WOODSIDE, CA 94062

GENERAL NOTES & SCHEDULI

ANTENNA SECTOR


SECTOR ALPHA

SECTOR GAMMA

AZIMUTH

377

206

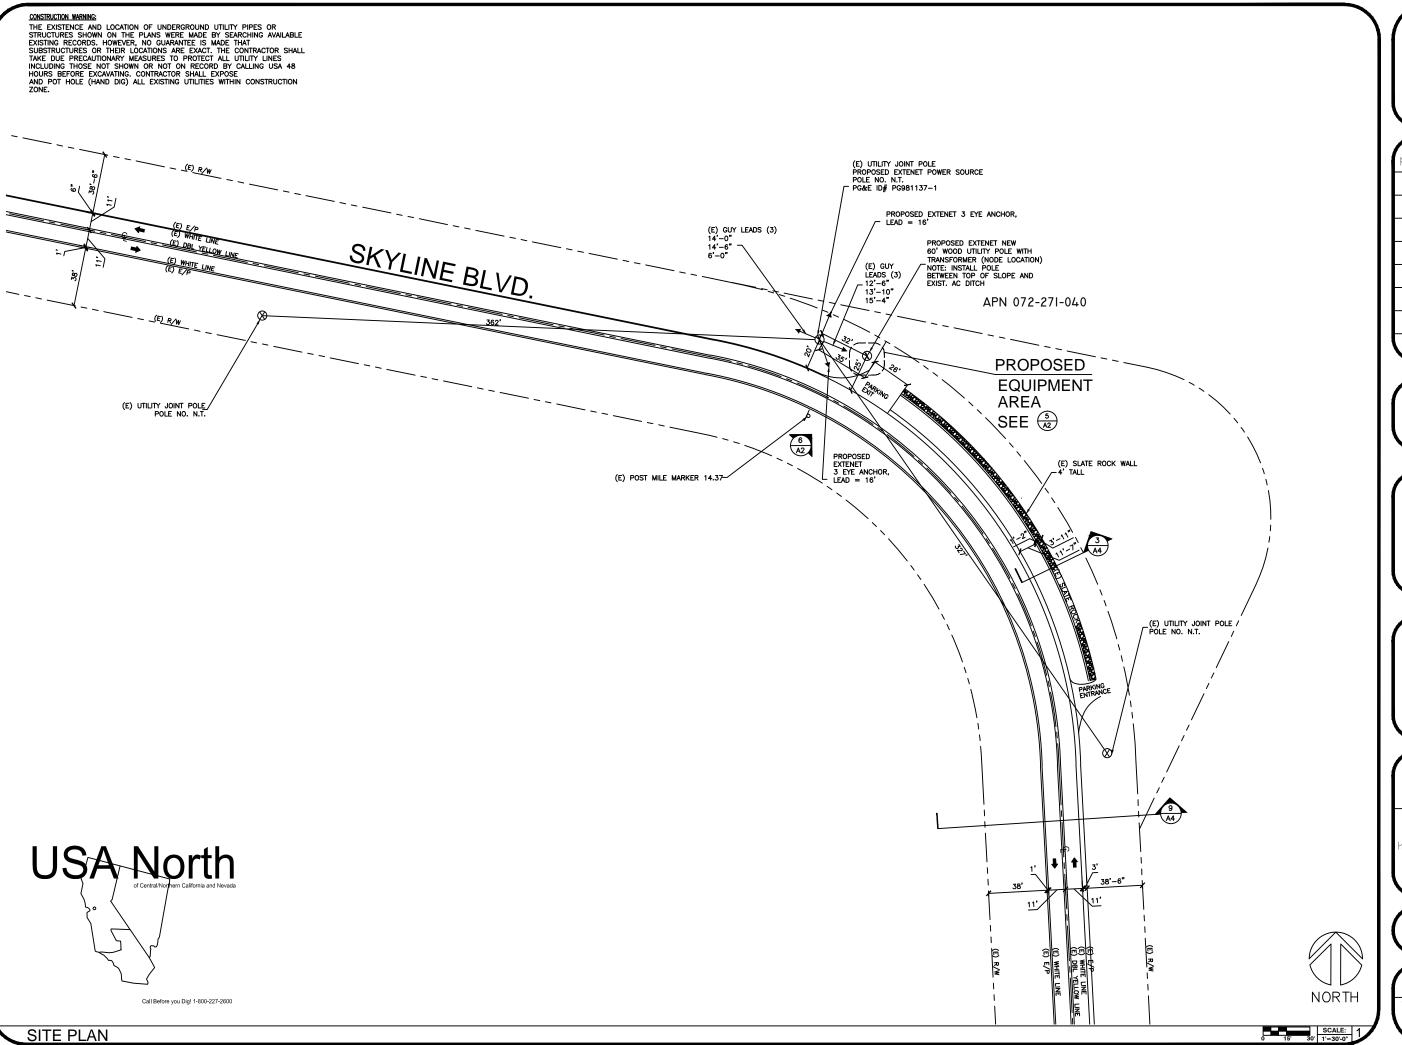

extenet

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5	/ 3/	REVISION PER CALTRANS COMMENTS
6	07/25/11	REVISION PER CALTRANS EQUIPMENT ORIENTATION

CURRENT ISSUE DATE:

07/25/11

PLANS PREPARED BY:



1-800-825-4ACI 5711 Research Drive Canton, MI 48188

LICENSURE:



SITE NO.:

HWY8435-008B

SITE NAME & ADDRESS:

HIGHWAY 84/ 35 NETWORK NODE 008B


LOOKOUT POINT SKYLINE BLVD WOODSIDE, CA 94062

SHEET TITLE


SITE PLAN


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2	01/05/10	REVISION PER PAGE DESIGN CHANGE
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5	1/13/11	REVISION PER CALTRANS COMMENTS
6	07/25/11	REVISION PER CALTRANS EQUIPMENT ORIENTATION



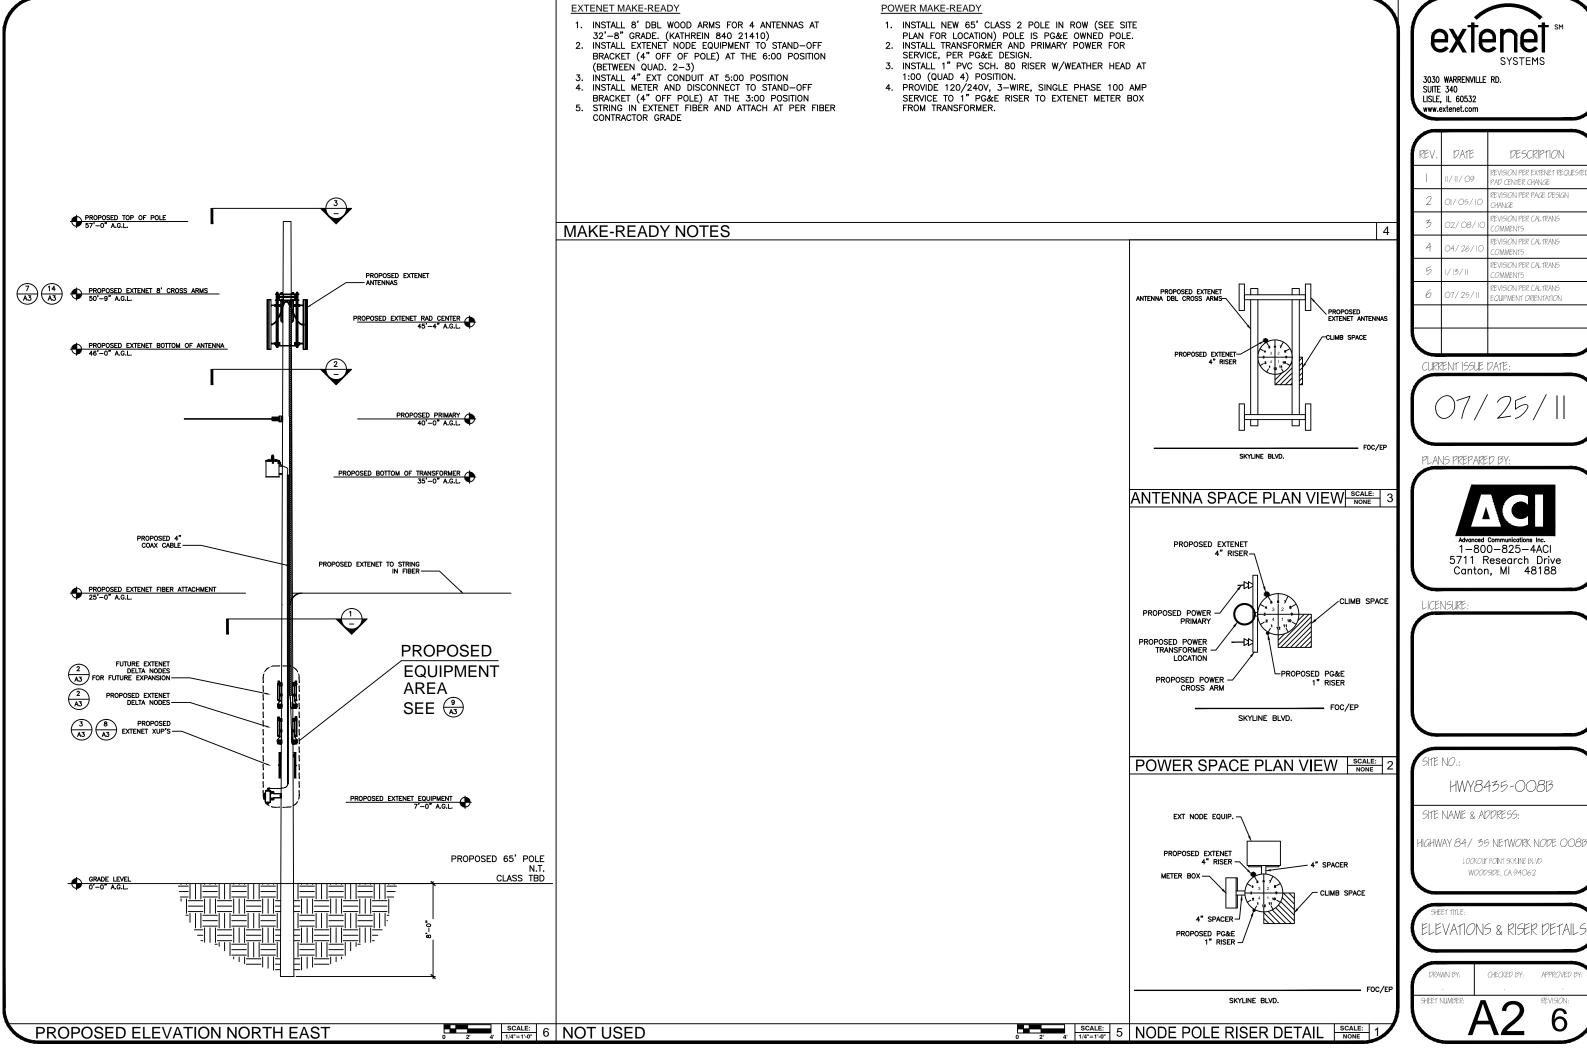


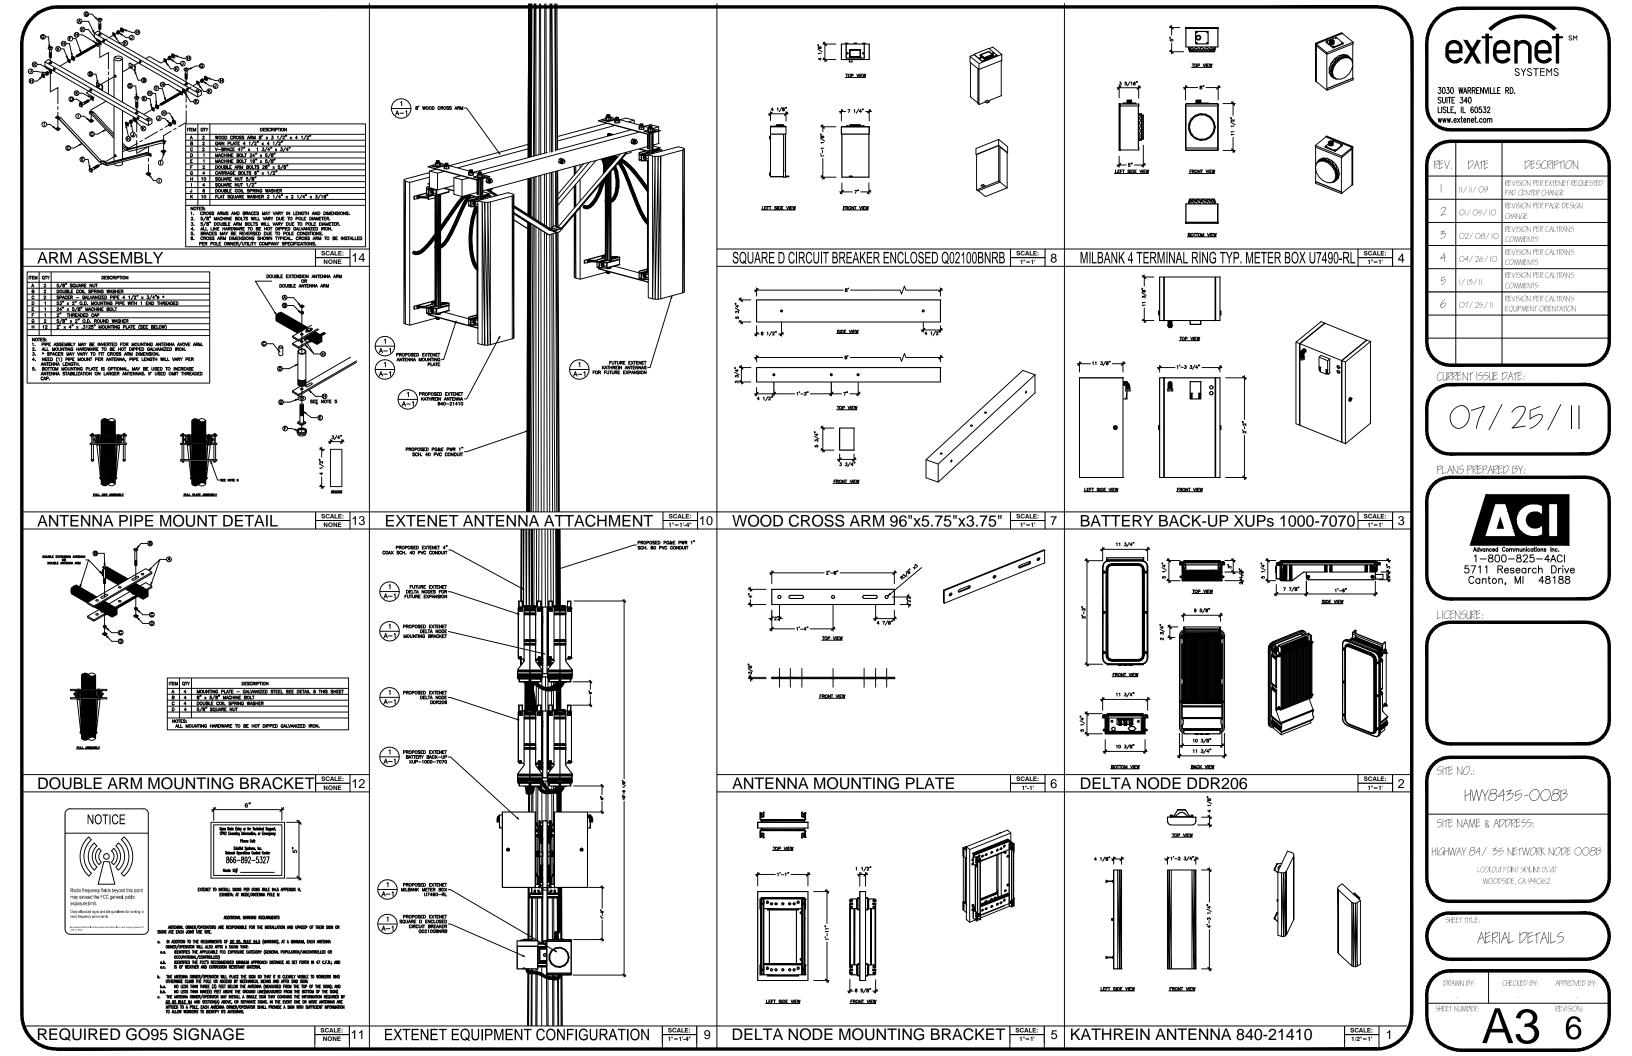

HWY - 35 PROJECT HWY8435 - 009B

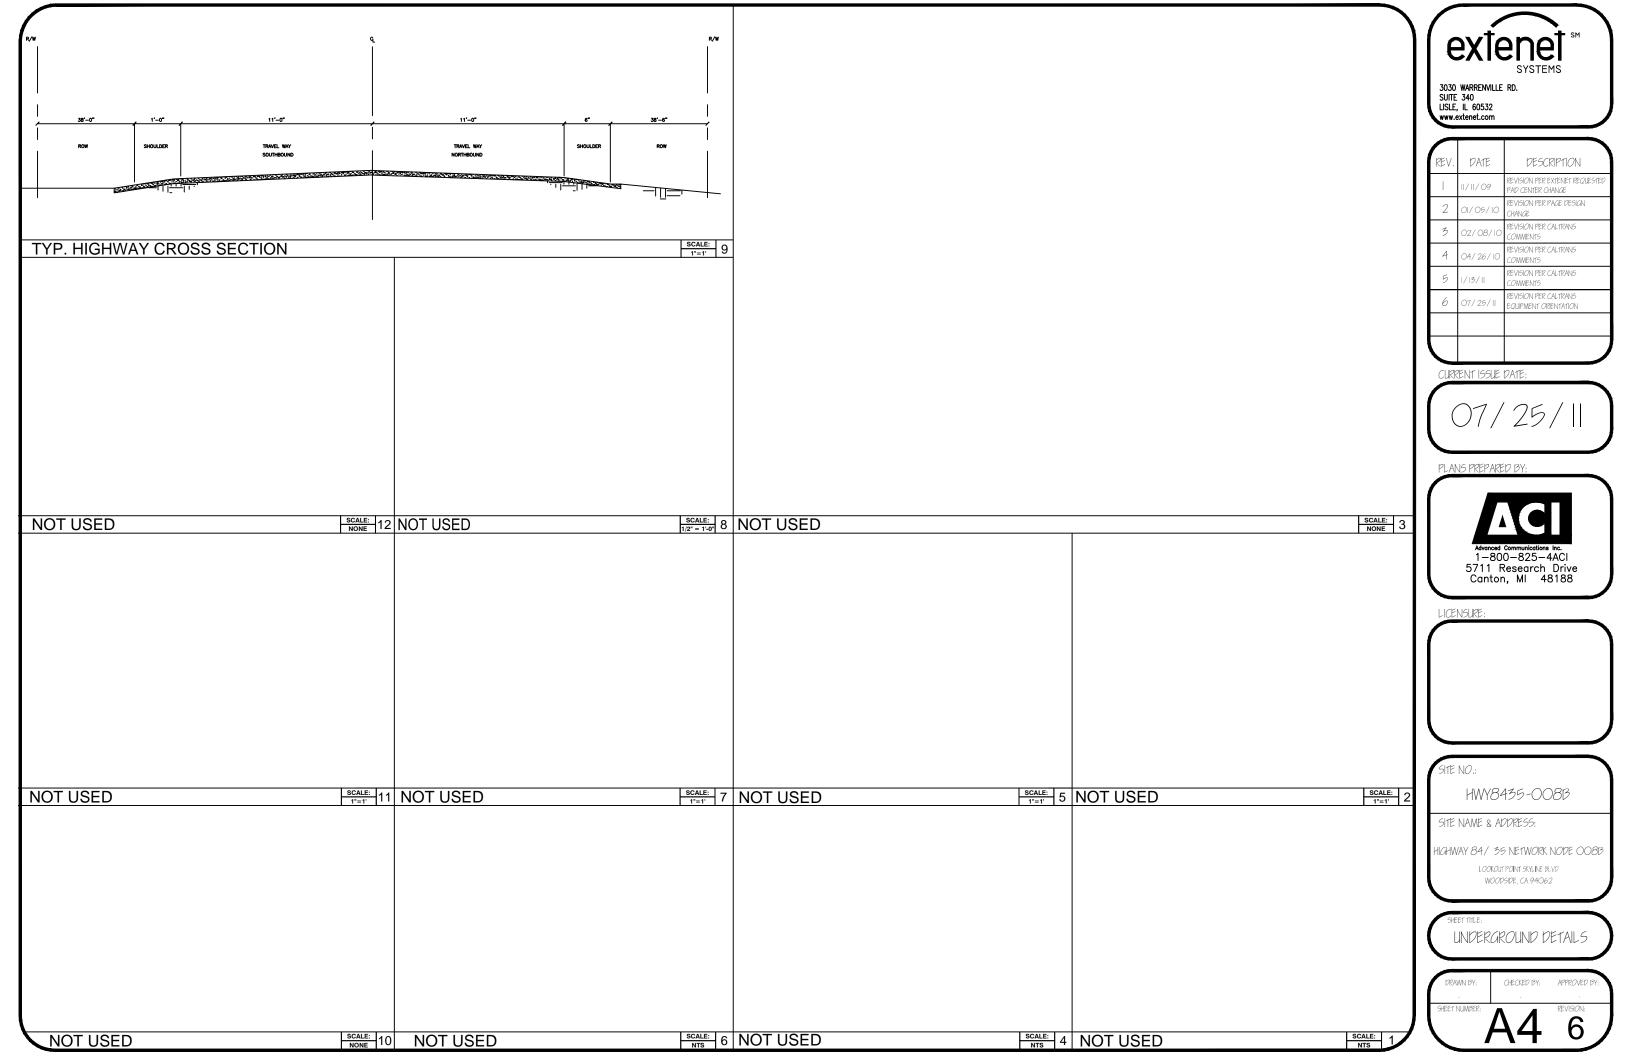POST MILE MARKER 13.84

EL CORTE DE MADERA CREEK SKYLINE BLVD.
WOODSIDE, CA 94062

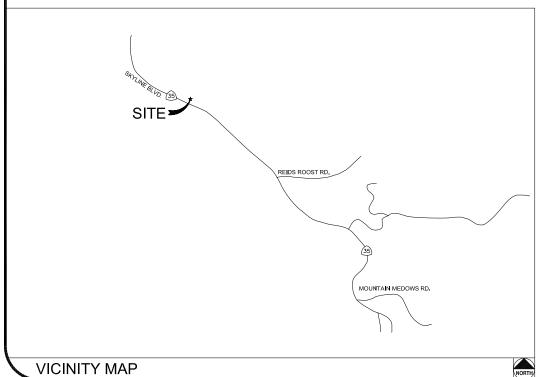

CLIENT

EXTENET SYSTEMS, INC. 3030 WARRENVILLE RD. SUITE 340 LISLE, IL 60532 CONTACT JEFF FRYE PHONE 480-626-1271 FAX 504-285-1603

POLE OWNER

EXTENET SYSTEMS, INC. 3030 WARRENVILLE RD. SUITE 340 LISLE, IL 60532 CONTACT JEFF FRYE PHONE 480-626-1271 FAX 504-285-1603

ENGINEERING FIRM/SURVEYING

MAXIMIZE COMMUNICATION GROUP, INC. 1351 POMONA ROAD SUIFE 100 CORONA, CA 92882 CONTACT KELLI MCCABE PHONE 909-786-2170 FAX 909-992-3113

COORDINATES

LAT: 37.40580 LONG: -122.30383

CODE COMPLIANCE:

INC. ALL WORK AND MATERIALS SHALL BE PERFORMED &
INSTALLED IN ACCORDANCE WITH THE CURRENT EDITIONS OF
THE FOLLOWING CODES AS ADOPTED BY LOCAL GOVERNING
AUTHORITIES AND LOCAL/CITY/COUNTY ORDINANCES:

 CALIFORNIA ADMINISTRATIVE CODE (INCLUDING TITLE 24 & 25).

- 2. 2007 CALIFORNIA BUILDING CODE
- 3. 2007 CALIFORNIA ELECTRICAL CODE.
- 3. BUILDING OFFICIALS AND CODE ADMINISTRATORS (BOCA).
- UNIFORM PLUMBING & MECHANICAL CODES.
- 5. ANSI/EIA-222-F LIFE SAFETY CODE.
- 6. CALIFORNIA GENERAL ORDER 95, 128 & 165.

SHEET INDEX				
SHEET	DESCRIPTION			
T1	TITLE SHEET			
T2	GENERAL CONSTRUCTION NOTE & ANTENNA CABLE SCHEDULE			
A1	SITE PLAN			
A2	JTILITY POLE ELEVATIONS/RISER DETAILS			
А3	AERIAL DETAILS			
A4	UNDERGROUND DETAILS			



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		11/11/09	REVISION PER EXTENET REQUESTED RAD CENTER CHANGE

CURRENT ISSUE DATE:



PLANS PREPARED BY:



1351 POMONA ROAD SUITE 100 CORONA, CA 92882 OFFICE: (909) 786-2170 FAX: (909) 992-3113

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SITE NO.:

HWY8435-009B

SITE NAME & ADDRESS:


HIGHWAY 84/35 NETWORK NODE 009

EL CORTE DE MADERA CREEK SKLYLINE BLVD WOODSIDE CA 94062

SHEET 111

111LE SHEET

DRAWN BY:	CHECKED BY:	APPROVED BY
VG	AF	KM
SHEET NUMBER	T 4	REVISION:

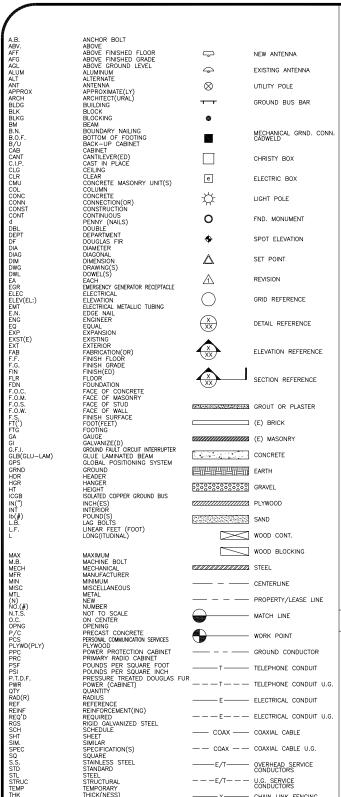

1. THE CONTRACTOR SHALL BE RESPONSIBLE FOR SURVEY MONUMENTS AND/OR VERTICAL CONTROL BENCHMARKS WHICH ARE DISTURBED OR DESTROYED BY CONSTRUCTION. A LAND SURVEYOR MUST FIELD LOCATE, REFERENCE, AND/OR PRESERVE ALL HISTORICAL OR CONTROLLING MONUMENTS PRIOR TO ANY EARTHMORK. IF DESTROYED, SUCH MONUMENTS SHALL BE REPLACED WITH APPROPRIATE MONUMENTS BY A LAND SURVEYOR. A CORNER RECORD OR RECORD OF SURVEY, AS APPROPRIATE, SHALL BE FILED AS REQUIRED BY THE PROPRESSIONAL LAIDS SURVEYOR.

NUMBER BE ISSUED BEFORE A "PERMT TO EXCAVATE" WILL BE VALID. FOR YOUR DIG ALERT I.D. NUMBER, CALL UNDERGROUND SERVICE ALERT, TOLL FREE 1-800-422-4133, TWO DAYS BEFORE YOU DIG.

CROSS THE PROPOSED TRENCH LINE AND MUST MAINTAIN A 1' MINIMUM VERTICAL CLEARANCE.

4. IF ANY EXISTING HARDSCAPE OR LANDSCAPE INDICATED ON THE APPROVE PLANS IS DAMAGED OR REMOVED DURING DEMOLITION OR CONSTRUCTION, IT SHALL BE REPAIRED AND/OR REPLACED IN KIND PER THE APPROVED PLANS.

5. CONTRACTOR SHALL REPLACE OR REPAIR ALL TRAFFIC SIGNAL LOOPS, CONDUIT, AND LANE STRIPING DAMAGED DURING CONSTRUCTION.

6. THIS PROJECT WILL BE INSPECTED BY ENGINEERING AND FIELD ENGINEERING DIVISION

7. MANHOLES OR COVERS SHALL BE LABELED EXTENET

8. CONTRACTOR SHALL IMPLEMENT AN EROSION CONTROL PROGRAM DURING THE PROJECT CONSTRUCTION ACTIVITIES. THE PROGRAM SHALL MEET THE APPLICABLE REQUIREMENTS OF THE STATE WATER RESOURCE CONTROL

9. THE CONTRACTOR SHALL HAVE EMERGENCY MATERIALS AND EQUIPMENT ON HAND FOR UNFORESEEN SITUATIONS, SUCH AS DAMAGE TO UNDERGROUND WATER, SEWER, AND STORM DRAIN FACILITIES WHEREBY FLOWS MAY GENERATE EROSION AND SEDIMENT POLLUTION.

USA North

1. INDEMNIFICATION CLAUSE: THE CONTRACTOR AGREES AND SHALL:
ASSUME SOLE AND COMPLETE RESPONSIBILITY OF THE JOB SITE CONDITIONS DURING THE COURSE OF
CONSTRUCTION OF THIS PROJECT, INCLUDING THE SAFETY OF ALL PERSONS AND PROPERTIES. THAT THESE
REQUIREMENTS SHALL APPLY CONTINUOUSLY AND NOT BE LIMITED TO NORMAL WORKING HOURS AND CONDITIONS. ENGINEERS HARMLESS FROM ANY AND ALL LIABILITY, REAL OR ALLEGED IN CONNECTION WITH THE PERFORMANCE

2. PRIOR TO THE BEGINNING OF ANY CONSTRUCTION AND THROUGHOUT THE COURSE OF CONSTRUCTION WORK. THE CONTRACTOR SHALL FULLY COMPLY WITH "CALIFORNIA OCCUPATIONAL SAFETY AND HEALTH" ACT OF 1973 INCLUDING ALL REVISIONS AND AMENDMENTS THERETO.

3. ALL WORK SHALL CONFORM TO THE LATEST EDITIONS OF G095,128 AND THE STANDARD "SPECIFICATIONS FOR PUBLIC WORKS CONSTRUCTION" AS ADOPTED BY THE CITY, COUNTY OR STATE AS MODIFIED BY STANDARD PLANS

4. THE EXISTENCE AND LOCATION OF UTILITIES AND OTHER AGENCY'S FACILITIES AS SHOWN HERON ARE OBJUSTED BY A SEARCH OF AVAILABLE RECORDS. OTHER FACILITIES MAY EXIST. THE CONTRACTOR SHALL VERIFY PRIOR TO THE START OF CONSTRUCTION AND SHALL USE EXTREME CARE AND PROTECTIVE MEASURES TO OR AGENCY FACILITIES WITHIN THE LIMITS OF WORK, WHETHER THEY ARE SHOWN ON THIS PLAN OR NOT.

5. THE CONTRACTOR SHALL NOTIFY THE CITY, COUNTY OR STATE ENGINEER INSPECTION DEPARTMENT, AT LEAST TWO DAYS BEFORE START OF ANY WORK REQUIRING THEIR INVOLVEMENT.

6. THE CITY, COUNTY OR STATE SHALL SPECIFY THE EXPIRATION PERIOD OF THE PERMIT FOR THIS CONSTRUCTION PROJECT.

7. The minimum cover for all conduits placed underground shall be 36 inches to the finished grade at all times.

8. THE CONTRACTOR SHALL TUNNEL ALL CURB AND GUTTERS AND BORE ALL CONCRETE DRIVEWAYS AND WALKWAYS AT THE DIRECTION OF THE CITY, COUNTY OR STATE ENGINEER.

ALL A.C AND/OR CONCRETE PAVEMENT SHALL BE REPLACED AT THE DIRECTION OF THE CITY, COUNTY OR STATE ENGINEERS.

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14. CONTRACTOR SHALL MAKE EXPLORATION EXCAVATIONS AND LOCATE EXISTING FACILITIES SUFFICIENTLY AHEAD OF CONSTRUCTION TO PERMIT REVISIONS TO PLANS IF REVISION IS NECESSARY BECAUSE OF LOCATION OF

15. THE LOCATIONS OF ALL EXISTING UTILITIES SHOWN ON THESE PLANS ARE FROM EXISTING RECORDS AND CORROBORATED, WHERE POSSIBLE, WITH FIELD TIES. THE CONTRACTOR IS RESPONSIBLE FOR CONFIRMING THE LOCATIONS SHOWN, BOTH HORIZONIAL AND VERTICALLY. PRIOR TO CONSTRUCTION, IF EXISTING LOCATIONS VAR SUBSTANTIALLY FROM THE PLANS. THE ENGINEER SHOULD BE NOTIFIED TO MAKE ANY CONSTRUCTION CHANGES

EROSION AND SEDIMENT CONTROL NOTES

TEMPORARY EROSION/SEDIMENT CONTROL PRIOR TO COMPLETION OF FINAL IMPROVEMENTS, SHALL BE PERFORMED BY THE CONTRACTOR OR QUALIFIED PERSON AS INDICATED BELOW:

1. ALL REQUIREMENTS OF THE CITY, COUNTY AND STATE "STORM WATER STANDARDS" MUST BE INCORPORATED INTO THE DESIGN AND CONSTRUCTION OF THE PROPOSED GRADING/IMPROVMENTS CONSISTENT WITH THE APPROVED STORM WATER POLLUTION PREVENTION PLAN (SWPPP), WATER QUALITY TECHNICAL REPORT (WQTR), AND/OR WATER POLLUTION CONTROL PLAN (WPCP).

2. FOR STORM DRAIN INLETS, PROVIDE A GRAVEL BAG SILT BASIN IMMEDIATELY UPSTREAM OF INLET AS INDICATED ON DETAILS.

3. FOR INLETS LOCATED AT SUMPS ADJACENT TO TOP OF SLOPES. THE CONTRACTOR SHALL ENSURE THAT WATER DRAINING TO THE SUMP IS DIRECTED INTO THE INLET AND THAT A MINIMUM OF 1.00° FREEBOARD EXISTS AND IS MAINTAINED ABOVE THE TOP OF THE INLET. IF FREEBOARD IS NOT PROVIDED BY GRADING SHOWN ON

4. THE CONTRACTOR OR QUALIFIED PERSON SHALL BE RESPONSIBLE FOR CLEANUP OF SILT AND MUD ON ADJACENT STREET(S) AND STORM DRAIN SYSTEM DUE TO CONSTRUCTION ACTIVITY.

5. THE CONTRACTOR OR QUALIFIED PERSON SHALL CHECK AND MAINTAIN ALL LINED AND UNLINED DITCHES AFTER EACH RAINFALL.

6. THE CONTRACTOR SHALL REMOVE SILT AND DEBRIS AFTER EACH MAJOR RAINFALL

B. THE CONTRACTOR SHALL RESTORE ALL EROSION/SEDIMENT CONTROL DEVICES TO WORKING ORDER TO THE SATISFACTION OF THE CITY ENGINEER OF RESIDENT ENGINEER AFTER EACH RUN-OFF PRODUCING RAINFALL.

). THE CONTRACTOR SHALL INSTALL ADDITIONAL EROSION/SEDIMENT CONTROL MEASURES AS MAY BE REQUIRED BY THE RESIDENT ENGINEER DUE TO UNCOMPLETED GRADING OPERATIONS OR UNFORESEEN CIRCUMSTANCES,

10. THE CONTRACTOR SHALL BE RESPONSIBLE AND SHALL TAKE NECESSARY PRECAUTIONS TO PREVENT PUBLIC TRESPASS ONTO AREAS WHERE IMPOUNDED WATERS CREATE A HAZARDOUS CONDITION.

11. ALL EROSION/SEDIMENT CONTROL MEASURES PROVIDED PER THE APPROVED GRADING PLAN SHALL BE INCORPORATED HERON. ALL EROSION/SEDIMENT CONTROL FOR INTERIM CONDITIONS SHALL BE DONE TO THE SATISFACTION OF THE RESIDENT ENGINEER.

12. GRADED AREAS AROUND THE PROJECT PERIMETER MUST DRAIN AWAY FROM THE FACE OF THE SLOPE AT THE CONCLUSION OF EACH WORKING DAY.

13. ALL REMOVABLE PROTECTIVE DEVICES SHOWN SHALL BE IN PLACE AT THE END OF EACH WORKING DAY WHEN RAIN IS IMMINENT.


14. THE CONTRACTOR SHALL ONLY GRADE, INCLUDING CLEARING AND GRUBBING FOR THE AREAS FOR WHICH THE CONTRACTOR OR QUALIFIED PERSON CAN PROVIDE EROSION/SEDIMENT CONTROL MEASURES.

15. THE CONTRACTOR SHALL ARRANGE FOR WEEKLY MEETINGS DURING OCTOBER 1ST TO APRIL 30TH FOR PROJECT TEAM (GENERAL CONTRACTOR, QUALIFIED PERSON, EROSION CONTROL SUBCONTRACTOR IF AN, ENGINEER OF WORK, OWNER/DEVELOPER AND THE RESIDENT ENGINEER) TO EVALUATE THE ADEQUACY OF THE EROSION/SEDIMENT CONTROL MEASURE AND OTHER RELATED CONSTRUCTION ACTIVITIES.

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	REV.	DATE	DESCRIPTION
	3	02/08/10	REVISION PER CALTRANS COMMENTS
	2	01/05/10	REVISION PER PG&E DESIGN CHANGE
1		11/11/09	REVISION PER EXTENET REQUESTED RAD CENTER CHANGE

CURRENT ISSUE DATE

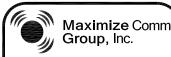

1351 POMONA ROAD SUITE 100 OFFICE: (909) 786-2170 FAX: (909) 992-3113

2

HWY8435-009B

SITE NAME & ADDRESS:

HIGHWAY 84/35 NETWORK NODE OO9B EL CORTE DE MADERA CREEK SKLYLINE BLVD

TOP OF WALL
TYPICAL
UNDER GROUND
UNDERWRITERS LABORATORY
UNLESS NOTED OTHERWISE
VERIFY IN FIELD
WIDE(WIDTH)
WITH WOOD

TOP OF PLATE (PARAPET)
TOP OF STEEL (SLAB)
TOP OF WALL

GENERAL NOTES

1. 120/240 POWER REQUIRED FOR 3-WIRE SERVICE.
2. GC TO REMOVE/CLEAN ALL DEBRIS, NAILS, STAPLES, OR NON-USED VERTICALS OFF THE POLE.
3. ALL CONSTRUCTION SHALL BE IN ACCORDANCE WITH MUNICIPAL, COUNTY, STATE, FEDERAL, GO95 AND G0128 STANDARDS AND REQUILATIONS.
4. CALL USA 48 HOURS PRIOR TO EXCAVATING AT (800) 422-4133.
5. ALL LANDSCAPING TO BE RESTORED TO ORIGINAL CONDITION OR BETTER.
6. ALL EQUIPMENT TO BE BONDED.

Call Before you Dlg! 1-800-227-2600

7. METERING CABINET REQUIRES 3'[.914M] CLEARANCE AT DOOR OPENING. 8. CAULK CABINET BASE AT PAD.

STANDARD GROUNDING NOTES:

5/8"x8"[.016x2.44M] ROD, CAD WELD BELOW GRADE

#6 GROUND AND BOND WIRE

. WOOD MOLDING, STAPLED EVERY 3'[.914M] AND AT EACH END . GROUNDS 3'[.914M] FROM POLE.

6. PLACE 3 #10GA WIRES FROM BREAKER TO METER BOX. STANDARD CONDUIT NOTES:

1. FOR UNDERGROUND USE SCHEDULE 40.
2. FOR RISERS USE SCHEDULE 80.
3. PLACE 2"[.051M] GALVANIZED STEEL CONDUIT FOR ANY CONDUIT UNDER 3"[.076M], STUB UP 10"[3.04M] THEN CONVERT TO SCHEDULE 80.
4. CONVERT 4"[.102M] CARRIER CONDUIT TO 3"[.076M] AT BASE OF POLE.
5. GC TO STUB UP POLE 10"[3.04M] w/3" POWER CONDUIT, POWER CO. TO CONVERT TROM 3"[.076M] SCH. 80 TO 2"[.051M] SCH. 80 FROM TOP OF STUB UP.

ALL CONDUIT WILL BE MAN DRILLED AND EQUIPPED WITH 3/8"[.010M] PULL ROPE.

MAINTAIN 40"[1.02M] MINIMUM COVER FOR ELECTRICAL CONDUIT.
 MAINTAIN 30"[7.62M] MINIMUM COVER FOR COMMUNICATIONS CONDUIT.
 SAND SHADING MINIMUM 1"[0.025M] UNDER CONDUITS, AND 6"[1.152M] COVERING ON TOP REQUIRED.
 ALL ELECTRICAL SERVICE CONDUITS FROM POWER COMPANY, WHETHER FROM POLES, TRANSFORMERS, OR OTHER LOCATIONS; WILL BE SLURRY BACKELIES.

5. IN STREET SLURRY TO GRADE AND MILL DOWN 1-1/2"[.038M] FOR AC CAP. 6. IN DIRT SLURRY 18"[.457M] FROM GRADE, AND FILL WITH 95% COMPACTION NATIVE SOIL FOR BALANCE.

PLACE WARNING TAPE IN TRENCH 12"[.305M] ABOVE ALL CONDUITS AND #18 WARNING TAPE ABOVE GROUND RING.

. NO BOLT THREADS TO PROTRUDE MORE THAN 1-1/2"[.038M]. . FILL ALL HOLES LEFT IN POLE FROM REARRANGEMENT OF CLIMBERS.

ALL CLIMB STEPS NEXT TO CONDUIT SHALL HAVE EXTENDED STEPS.

4. CABLE NOT TO IMPEDE 15"[.381M] CLEAR SPACE OFF POLE FACE

4. CABLE NOT TO IMPEDE 151_ASTIM] CLEAR SPACE OFF POLE FACE (12:00).
5. 90' SHORT SWEEPS UNDER ANTENNA ARM. ALL CABLES MUST ONLY TRANSITION ON THE INSIDE OR BOTTOM OF ARMS (NO CABLE ON TOP OF ARMS).
6. USE CABLE CLAMPS TO SECURE CABLE TO ARMS; PLACE 2"[0.51 M] CARRIER CABLE ID TAGS ON BOTH SIDES OF ARMS.
7. USE 90' CONNECTOR AT CABLE CONNECTION TO ANTENNAS.
8. PLACE GPS ON ARM WITH SOUTHERN SYLEXPOSURE AT MINIMUM.

S'[1.83M] FROM TRANSMIT ANTENNA, WHICH IS 24"[.61M] AWAY FROM CENTER OF POLE.

9. USE 1/2"[.013M] CABLE ON ANTENNAS UNLESS OTHERWISE

10. FILL VOID AROUND CABLES AT CONDUIT OPENING WITH FOAM SEALANT TO PREVENT WATER INTRUSION.

TOTAL	77.48 SQ. FT.
TOP GRADE	31'-3"
BOTTOM GRADE	26'-10"
METER/BREAKER AREA TOTAL	4.33 SQ. FT.
TOP GRADE	8'-0"
BOTTOM GRADE	7'-0"
BATTERY BACK-UP AREA TOTAL	16.25 SQ. FT.
TOP GRADE	11'-8"
BOTTOM GRADE	9'-6"
DELTA DECK AREA TOTAL	10.74 SQ. FT.
TOP GRADE	14'-7"
BOTTOM GRADE	12'-5"
DELTA DECK (FUT.) AREA TOTAL	10.74 SQ. FT.
TOP GRADE	17'-6"
BOTTOM GRADE	15'-4"
EXT. RISER SIZE	4"-ø
EXT. RISER LENGTH	15'-1"
EXT. RISER BTM GRADE	14'-5"
PWR RISER SIZE	1"-ø
PWR RISER LENGTH	11'-0"
PWR RISER BTM GRADE	8'-0"

WIND LOADING INFORMATION

antenna Sector	AZIMUTH	ANTENNA MAKE / MODEL	COAXIAL CABLE LENGTH	CABLES PER SECTOR	CABLE SIZE
SECTOR ALPHA	302*	KATHREIN 840 21410	47'-6"	2	1/2"
SECTOR BETA	125*	KATHREIN 840 21410	47'-6"	2	1/2"
SECTOR GAMMA	125	840 21410	47-6	2	1/2

NOTE:
CONTRACTOR TO FIELD VERIFY CABLE LENGTHS PRIOR TO ORDERING, FABRICATION, OR INSTALLATION OF CABLE:

WOODSIDE, CA 94062


IENERAL NOTES & SCHEDULE

SHEET NUMBER EVISION: 3

ABBREVIATION AND LEGEND

ROW CONSTRUCTION GENERAL NOTES

LOADING AND ANTENNA CABLE SCHEDULES

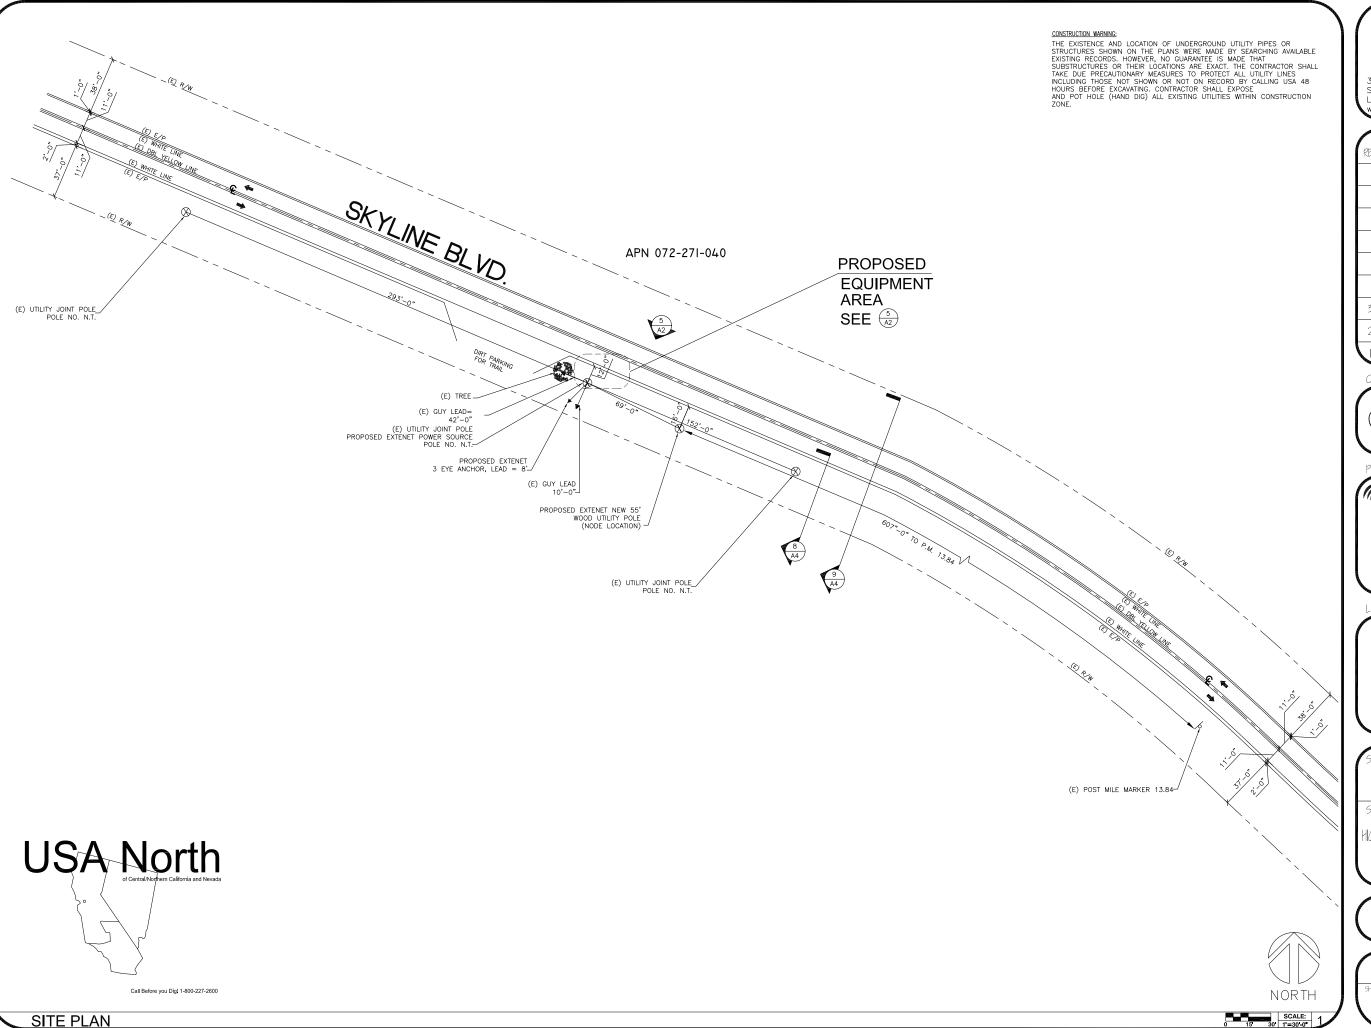



REV.	DATE	DESCRIPTION
3	02/08/10	REVISION PER CALTRANS COMMENTS
2	01/05/10	REVISION PER PG&E DESIGN CHANGE
	11/11/09	REVISION PER EXTENET REQUESTED RAD CENTER CHANGE

CURRENT ISSUE DATE:

02/08/10

PLANS PREPARED BY:



1351 POMONA ROAD SUITE 100 CORONA, CA 92882 OFFICE: (909) 786-2170 FAX: (909) 992-3113

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LICENSURE:

SITE NO.:

HWY8435-009B

SITE NAME & ADDRESS:

HGHWAY 84/35 NETWORK NODE 009E

EL CORTE DE MADERA CREEK SKLYLINE BLVD WOODSIDE, CA 94062

SHEET 111

SITE PLAN

DRAWN BY:	CHECKED BY:	APPROVED BY
Vä	AF	KM
SHEET NUMBER:		REVISION:


EXTENET MAKE-READY


- 1. INSTALL 40', CLASS 2, DOUGLAS FIR UTILITY POLE, PER SITE PLAN.
- 2. FLUSH MOUNT 4" PANEL ANTENNAS TOP AT 32'-2" GRADE. SECOND SET 1' BELOW PER ELEVATION.
- 3. INSTALL DELTA NODE RADIOS, BATTERY BACK-UP, METER AND ELEC. ENCLOSURE AT 3:00 POSITION W/MIN. 4" SPACING FROM POLE.
- 4. INSTALL 4" PVC SCH. 40 COAX RISER AT 2:00

POWER MAKE-READY


- 1. INSTALL TRANSFORMER AND SECONDARY POWER FOR SERVICE. PER PG&E DESIGN.
- 2. INSTALL 1" PVC SCH. 80 RISER W/WEATHER HEAD AT 2:00 (QUAD 4) POSITION.
- 3. PROVIDE 120/240V, 3-WIRE, SINGLE PHASE 100 AMP SERVICE TO 1" PG&E RISER TO EXTENET METER BOX FROM SECONDARY SERVICE POINT.


MAKE-READY NOTES

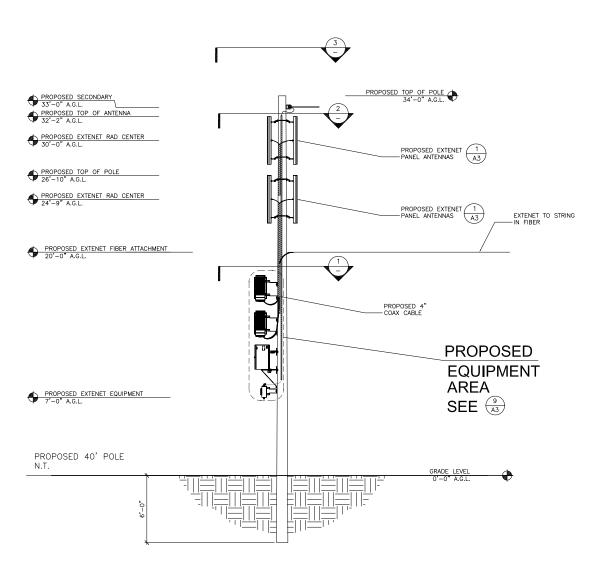

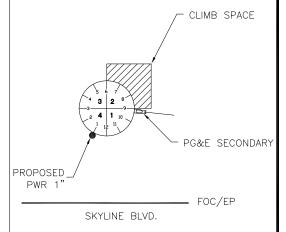

6 NOT USED

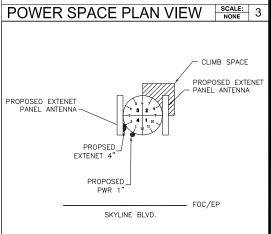

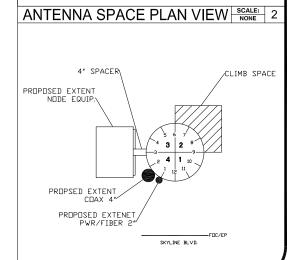



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REV.	DATE	DESCRIPTION
3	02/08/10	REVISION PER CALTRANS COMMENTS
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PLANS PREPARED BY:



1351 POMONA ROAD SUITE 100 CORONA, CA 92882 OFFICE: (909) 786-2170 FAX: (909) 992-3113

LICENSURE

HWY8435-009B SITE NAME & ADDRESS:


HIGHWAY 84/35 NETWORK NODE OO9E EL CORTE DE MADERA CREEK SKLYLINE BLVD WOODSIDE, CA 94062

SHEET NUMBER: EVISION: 7 3

ELEVATIONS & RISER DETAIL

SCALE: 1/4"=1'-0" 5 NODE POLE RISER DETAIL

PROPOSED ELEVATION NORTH

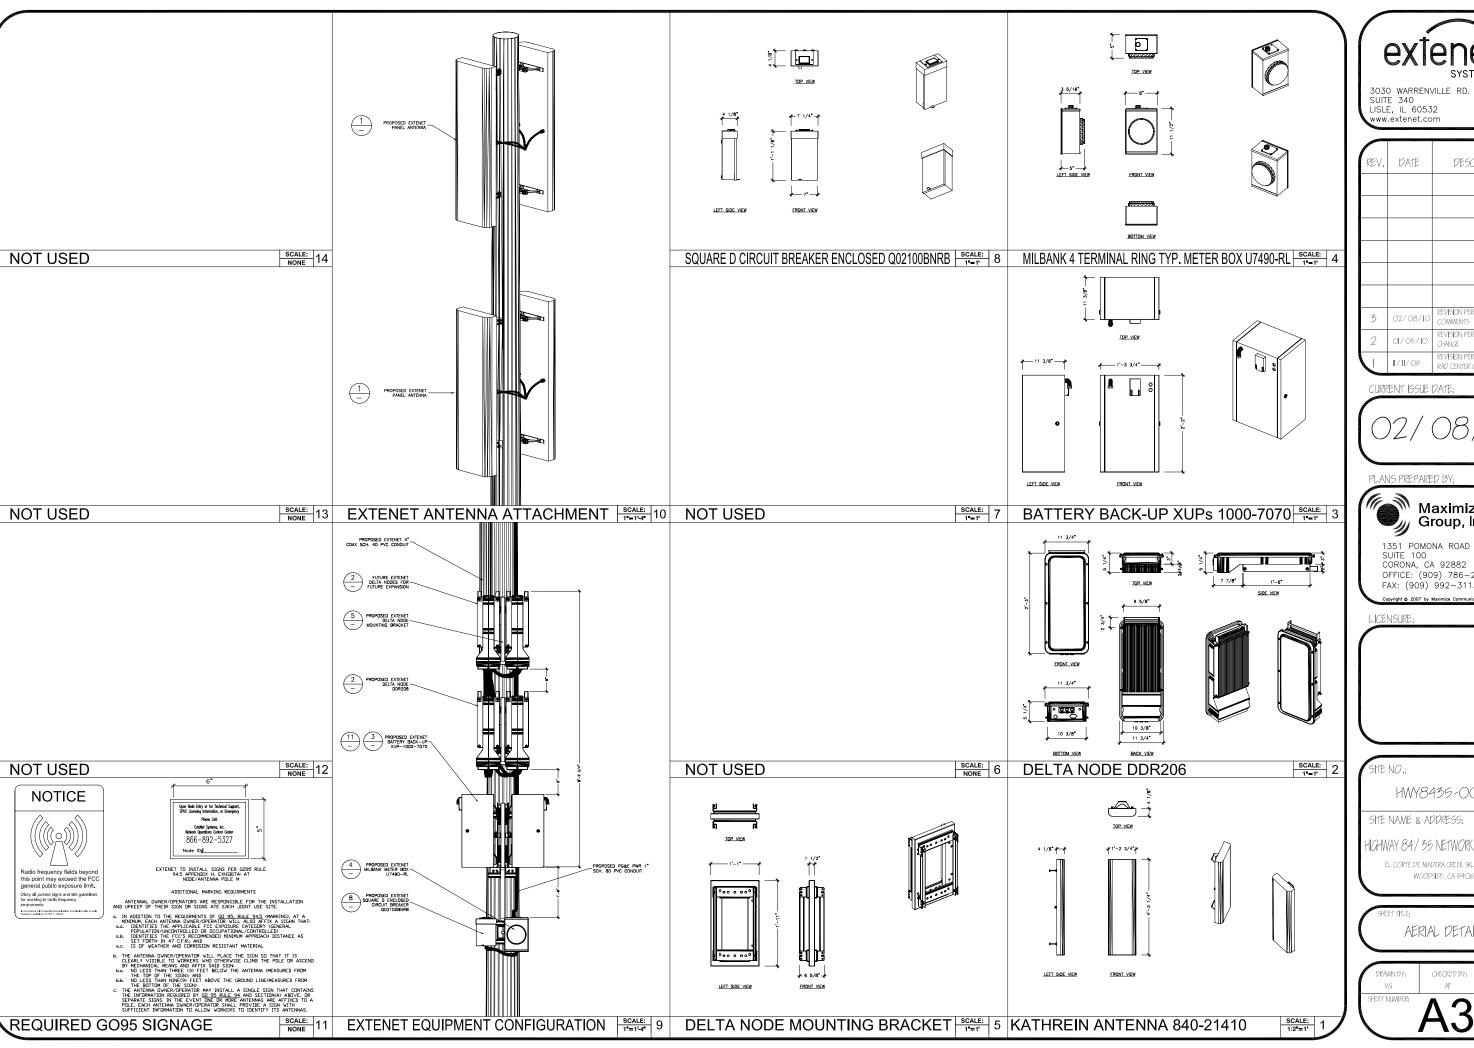

REV.	DATE	DESCRIPTION
3	02/08/10	REVISION PER CALTRANS COMMENTS
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	11/11/09	REVISION PER EXTENET REQUESTED. RAD CENTER CHANGE

CURRENT ISSUE DATE:



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HWY8435-009B


SITE NAME & ADDRESS:

EL CORTE DE MADERA CREEK SKLYLÎNE BLVD

WOODSIDE, CA 94062

AERIAL DETAILS

DRAWN BY: VG SHEET NUMBER:	CHECKED BY: AF	APPROVED BY: KM REVISION:
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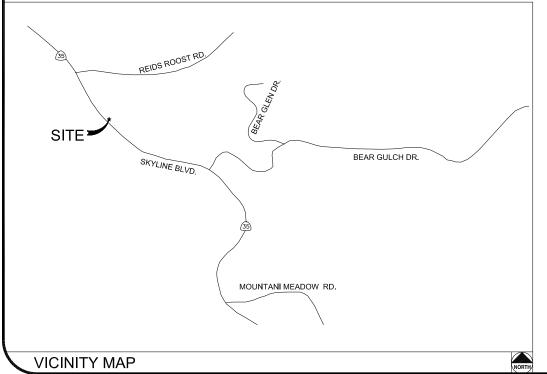


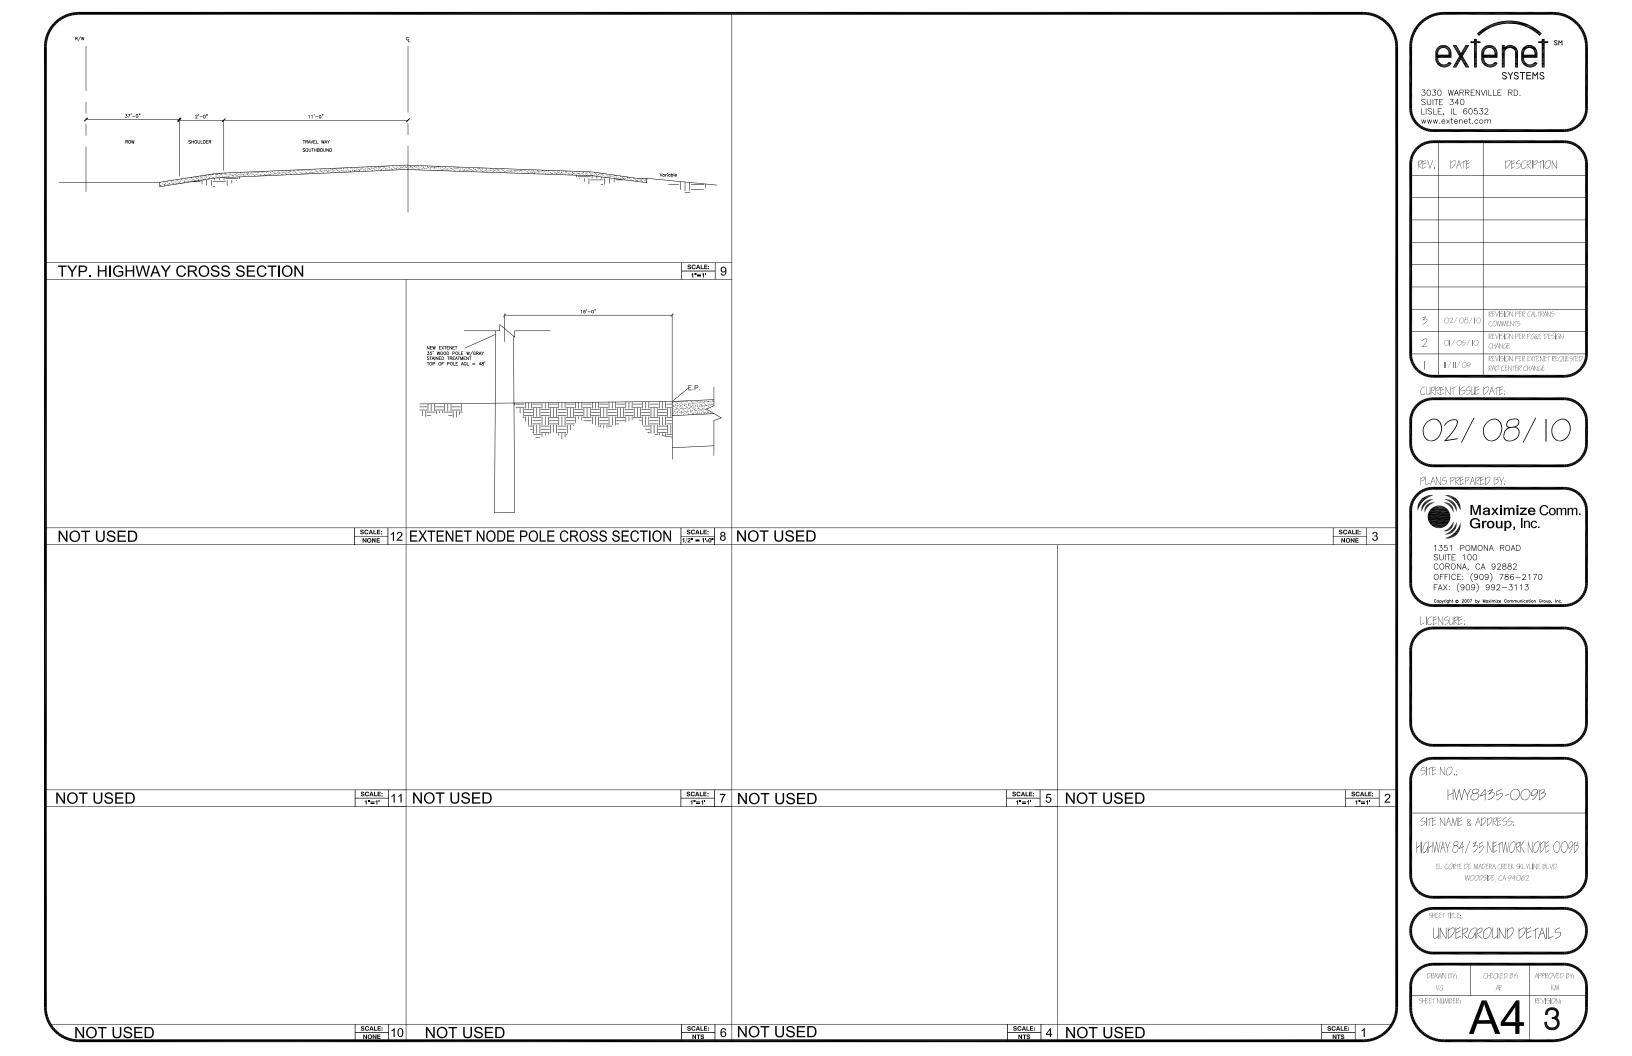HWY 35 - PROJECT

HWY8435 - 010B

POST MILE MARKER 13.53

15975 SKYLINE BLVD. (ACROSS STREET) WOODSIDE, CA 94062



CLIENT

EXTENET SYSTEMS, INC. 3030 WARRENVILLE RD. SUITE 340 LISLE, IL 60532 CONTACT JEFF FRYE PHONE 480-626-1271 FAX 504-285-1603

EXTENET SYSTEMS, INC. 3030 WARRENVILLE RD. SUITE 340 LISLE, IL 60532 CONTACT JEFF FRYE PHONE 480-626-1271 FAX 504-285-1603

ENGINEERING FIRM/SURVEYING

MAXIMIZE COMMUNICATION GROUP, INC. 1351 POMONA ROAD SUITE 100 CORONA, CA 92882 CONTACT KELL MCCABE PHONE 909–786–2170 FAX 909–992–3113

COORDINATES

CODE COMPLIANCE:

ALL WORK AND MATERIALS SHALL BE PERFORMED & INSTALLED IN ACCORDANCE WITH THE CURRENT EDITIONS OF THE FOLLOWING CODES AS ADOPTED BY LOCAL GOVERNING AUTHORITIES AND LOCAL/CITY/COUNTY ORDINANCES:

1. CALIFORNIA ADMINISTRATIVE CODE (INCLUDING TITLE 24 &

- 3. 2007 CALIFORNIA ELECTRICAL CODE.
- 3. BUILDING OFFICIALS AND CODE ADMINISTRATORS (BOCA).
- 4. UNIFORM PLUMBING & MECHANICAL CODES.
- 5. ANSI/EIA-222-F LIFE SAFETY CODE
- 6. CALIFORNIA GENERAL ORDER 95, 128 & 165.

	5 · · · · · · · · · · · · · · · · · · ·
SHEET	DESCRIPTION
T1	TITLE SHEET
T2	GENERAL CONSTRUCTION NOTE & ANTENNA CABLE SCHEDULE
A1	SITE PLAN
A2	UTILITY POLE ELEVATIONS/RISER DETAILS
А3	AERIAL DETAILS
A4	UNDERGROUND DETAILS
	N Page

SHEET INDEX



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	-1000		3800
	REV.	DATE	DESCRIPTION
	4	04/26/10	REVISION PER CALTRANS COMMENTS
	3	02/08/10	REVISION PER CALTRANS COMMENTS
	2	01/25/10	REVISION PER PA&E POWER DESIAN
'		11/11/09	REVISION PER EXTENET REQUESTED RAD CENTER CHANGE

CURRENT ISSUE DATE:





CORONA, CA 92882 OFFICE: (909) 786-2170 FAX: (909) 992-3113

i No.	LICENSURE:
	a.

. SITE NO.:

HWY8435-010B


SITE NAME & ADDRESS:

HGHWAY 84/35 NETWORK NODE OLOE

5975 SKYLINE BLVD. (ACROSS STREET) WOODSIDE CA 94062

TITLE SHEET

DRAWN BY:	CHECKED BY:	APPROVED BY
VG	AF	KM
SHEET NUMBER:		REVISION:

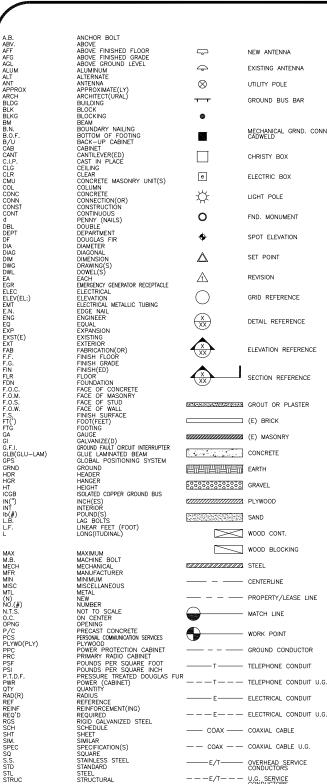

1. THE CONTRACTOR SHALL BE RESPONSIBLE FOR SURVEY MONUMENTS AND/OR VERTICAL CONTROL BENCHMARKS WHICH ARE DISTURBED OR DESTROYED BY CONSTRUCTION. A LAND SURVEYOR MUST FIELD LOCATE, REFERENCE, AND/OR PRESERVE ALL HISTORICAL OR CONTROLLING MONUMENTS PRIOR TO ANY EARTHMORK. IF DESTROYED, SUCH MONUMENTS SHALL BE REPLACED WITH APPROPRIATE MONUMENTS BY A LAND SURVEYOR. A CORNER RECORD OR RECORD OF SURVEY, AS APPROPRIATE, SHALL BE FILED AS REQUIRED BY THE PROPRESSIONAL LAIDS SURVEYOR.

NUMBER BE ISSUED BEFORE A "PERMT TO EXCAVATE" WILL BE VALID. FOR YOUR DIG ALERT I.D. NUMBER, CALL UNDERGROUND SERVICE ALERT, TOLL FREE 1-800-422-4133, TWO DAYS BEFORE YOU DIG.

CROSS THE PROPOSED TRENCH LINE AND MUST MAINTAIN A 1' MINIMUM VERTICAL CLEARANCE.

4. IF ANY EXISTING HARDSCAPE OR LANDSCAPE INDICATED ON THE APPROVE PLANS IS DAMAGED OR REMOVED DURING DEMOLITION OR CONSTRUCTION, IT SHALL BE REPAIRED AND/OR REPLACED IN KIND PER THE APPROVED PLANS.

5. CONTRACTOR SHALL REPLACE OR REPAIR ALL TRAFFIC SIGNAL LOOPS, CONDUIT, AND LANE STRIPING DAMAGED DURING CONSTRUCTION.

6. THIS PROJECT WILL BE INSPECTED BY ENGINEERING AND FIELD ENGINEERING DIVISION

7. MANHOLES OR COVERS SHALL BE LABELED EXTENET

8. CONTRACTOR SHALL IMPLEMENT AN EROSION CONTROL PROGRAM DURING THE PROJECT CONSTRUCTION ACTIVITIES. THE PROGRAM SHALL MEET THE APPLICABLE REQUIREMENTS OF THE STATE WATER RESOURCE CONTROL

9. THE CONTRACTOR SHALL HAVE EMERGENCY MATERIALS AND EQUIPMENT ON HAND FOR UNFORESEEN SITUATIONS, SUCH AS DAMAGE TO UNDERGROUND WATER, SEWER, AND STORM DRAIN FACILITIES WHEREBY FLOWS MAY GENERATE EROSION AND SEDIMENT POLLUTION.

1. INDEMNIFICATION CLAUSE: THE CONTRACTOR AGREES AND SHALL:
ASSUME SOLE AND COMPLETE RESPONSIBILITY OF THE JOB SITE CONDITIONS DURING THE COURSE OF
CONSTRUCTION OF THIS PROJECT, INCLUDING THE SAFETY OF ALL PERSONS AND PROPERTIES. THAT THESE
REQUIREMENTS SHALL APPLY CONTINUOUSLY AND NOT BE LIMITED TO NORMAL WORKING HOURS AND CONDITIONS. ENGINEERS HARMLESS FROM ANY AND ALL LIABILITY, REAL OR ALLEGED IN CONNECTION WITH THE PERFORMANCE

2. PRIOR TO THE BEGINNING OF ANY CONSTRUCTION AND THROUGHOUT THE COURSE OF CONSTRUCTION WORK. THE CONTRACTOR SHALL FULLY COMPLY WITH "CALIFORNIA OCCUPATIONAL SAFETY AND HEALTH" ACT OF 1973 INCLUDING ALL REVISIONS AND AMENDMENTS THERETO.

3. ALL WORK SHALL CONFORM TO THE LATEST EDITIONS OF G095,128 AND THE STANDARD "SPECIFICATIONS FOR PUBLIC WORKS CONSTRUCTION" AS ADOPTED BY THE CITY, COUNTY OR STATE AS MODIFIED BY STANDARD PLANS

4. THE EXISTENCE AND LOCATION OF UTILITIES AND OTHER AGENCY'S FACILITIES AS SHOWN HERON ARE OBJUSTED BY A SEARCH OF AVAILABLE RECORDS. OTHER FACILITIES MAY EXIST. THE CONTRACTOR SHALL VERIFY PRIOR TO THE START OF CONSTRUCTION AND SHALL USE EXTREME CARE AND PROTECTIVE MEASURES TO OR AGENCY FACILITIES WITHIN THE LIMITS OF WORK, WHETHER THEY ARE SHOWN ON THIS PLAN OR NOT.

5. THE CONTRACTOR SHALL NOTIFY THE CITY, COUNTY OR STATE ENGINEER INSPECTION DEPARTMENT, AT LEAST TWO DAYS BEFORE START OF ANY WORK REQUIRING THEIR INVOLVEMENT.

6. THE CITY, COUNTY OR STATE SHALL SPECIFY THE EXPIRATION PERIOD OF THE PERMIT FOR THIS CONSTRUCTION PROJECT.

7. The minimum cover for all conduits placed underground shall be 36 inches to the finished grade at all times.

8. THE CONTRACTOR SHALL TUNNEL ALL CURB AND GUTTERS AND BORE ALL CONCRETE DRIVEWAYS AND WALKWAYS AT THE DIRECTION OF THE CITY, COUNTY OR STATE ENGINEER.

ALL A.C AND/OR CONCRETE PAVEMENT SHALL BE REPLACED AT THE DIRECTION OF THE CITY, COUNTY OR STATE ENGINEERS.

WORK, SHALL BE REPLANTED AND/OR REPLACED SO AS TO RESTORE THE WORK SITE TO ITS ORIGINAL CONDITION

11. THE CONTRACTOR WILL BE RESPONSIBLE FOR THE PROCESSING OF ALL APPLICANT PERMIT FORMS ALONG WITH THE REQUIRED LIABILITY INSURANCE FORMS. CLEARLY DEMONSTRATING THAT EXTENET, THE CITY, COUNTY OR STATE IS ALSO INSURED WITH THE REQUIRED LIABILITY INSURANCE IN THE AMOUNT OF \$1,000,000.00 FOR THIS

12. VAULTS, PEDESTALS, CONDUITS AND OTHER TYPES OF SUBSTRUCTURE ARE EITHER SPECIFIED ON THIS PLAN OR WILL BE SPECIFIED BY THE CONSTRUCTION ENGINEER. ANY AND ALL DEVIATIONS FROM THE SPECIFIED TYPES OF MATERIAL MUST BE APPROVED BY THE SYSTEM ENGINEER, IN WRITING BEFORE INSTALLATION THEREOF.

13. THE CONTRACTOR SHALL VERIFY THE LOCATION OF ALL EXISTING UTILITIES IN INCLUDING SEWER LATERALS & WATER SERVICES TO INDIVIDUAL LOTS BOTH VERTICAL AND HORIZONTAL PRIOR TO COMMENCING IMPROVEMENT

14. CONTRACTOR SHALL MAKE EXPLORATION EXCAVATIONS AND LOCATE EXISTING FACILITIES SUFFICIENTLY AHEAD OF CONSTRUCTION TO PERMIT REVISIONS TO PLANS IF REVISION IS NECESSARY BECAUSE OF LOCATION OF

15. THE LOCATIONS OF ALL EXISTING UTILITIES SHOWN ON THESE PLANS ARE FROM EXISTING RECORDS AND CORROBORATED, WHERE POSSIBLE, WITH FIELD TIES. THE CONTRACTOR IS RESPONSIBLE FOR CONFIRMINT LOCATIONS SHOWN, BOTH HORIZONIAL AND VERTICALLY. PRIOR TO CONSTRUCTION, IF EXISTING LOCATIONS WAR SUBSTANTIALLY FROM THE PLANS. THE ENGINEER SHOULD BE NOTIFIED TO MAKE ANY CONSTRUCTION CHANGES

EROSION AND SEDIMENT CONTROL NOTES

TEMPORARY EROSION/SEDIMENT CONTROL PRIOR TO COMPLETION OF FINAL IMPROVEMENTS, SHALL BE PERFORMED BY THE CONTRACTOR OR QUALIFIED PERSON AS INDICATED BELOW:

1. ALL REQUIREMENTS OF THE CITY, COUNTY AND STATE "STORM WATER STANDARDS" MUST BE INCORPORATED INTO THE DESIGN AND CONSTRUCTION OF THE PROPOSED GRADING/IMPROVMENTS CONSISTENT WITH THE APPROVED STORM WATER POLLUTION PREVENTION PLAN (SWPPP), WATER QUALITY TECHNICAL REPORT (WQTR), AND/OR WATER POLLUTION CONTROL PLAN (WPCP).

2. FOR STORM DRAIN INLETS, PROVIDE A GRAVEL BAG SILT BASIN IMMEDIATELY UPSTREAM OF INLET AS INDICATED ON DETAILS.

3. FOR INLETS LOCATED AT SUMPS ADJACENT TO TOP OF SLOPES. THE CONTRACTOR SHALL ENSURE THAT WATER DRAINING TO THE SUMP IS DIRECTED INTO THE INLET AND THAT A MINIMUM OF 1.00° FREEBOARD EXISTS AND IS MAINTAINED ABOVE THE TOP OF THE INLET. IF FREEBOARD IS NOT PROVIDED BY GRADING SHOWN ON

4. THE CONTRACTOR OR QUALIFIED PERSON SHALL BE RESPONSIBLE FOR CLEANUP OF SILT AND MUD ON ADJACENT STREET(S) AND STORM DRAIN SYSTEM DUE TO CONSTRUCTION ACTIVITY.

5. THE CONTRACTOR OR QUALIFIED PERSON SHALL CHECK AND MAINTAIN ALL LINED AND UNLINED DITCHES AFTER EACH RAINFALL.

6. THE CONTRACTOR SHALL REMOVE SILT AND DEBRIS AFTER EACH MAJOR RAINFALL

B. THE CONTRACTOR SHALL RESTORE ALL EROSION/SEDIMENT CONTROL DEVICES TO WORKING ORDER TO THE SATISFACTION OF THE CITY ENGINEER OF RESIDENT ENGINEER AFTER EACH RUN-OFF PRODUCING RAINFALL.

). THE CONTRACTOR SHALL INSTALL ADDITIONAL EROSION/SEDIMENT CONTROL MEASURES AS MAY BE REQUIRED BY THE RESIDENT ENGINEER DUE TO UNCOMPLETED GRADING OPERATIONS OR UNFORESEEN CIRCUMSTANCES,

10. THE CONTRACTOR SHALL BE RESPONSIBLE AND SHALL TAKE NECESSARY PRECAUTIONS TO PREVENT PUBLIC TRESPASS ONTO AREAS WHERE IMPOUNDED WATERS CREATE A HAZARDOUS CONDITION.

11. ALL EROSION/SEDIMENT CONTROL MEASURES PROVIDED PER THE APPROVED GRADING PLAN SHALL BE INCORPORATED HERON. ALL EROSION/SEDIMENT CONTROL FOR INTERIM CONDITIONS SHALL BE DONE TO THE SATISFACTION OF THE RESIDENT ENGINEER.

12. GRADED AREAS AROUND THE PROJECT PERIMETER MUST DRAIN AWAY FROM THE FACE OF THE SLOPE AT THE CONCLUSION OF EACH WORKING DAY.

13. ALL REMOVABLE PROTECTIVE DEVICES SHOWN SHALL BE IN PLACE AT THE END OF EACH WORKING DAY WHEN RAIN IS IMMINENT.

14. THE CONTRACTOR SHALL ONLY GRADE, INCLUDING CLEARING AND GRUBBING FOR THE AREAS FOR WHICH THE CONTRACTOR OR QUALIFIED PERSON CAN PROVIDE EROSION/SEDIMENT CONTROL MEASURES.


15. THE CONTRACTOR SHALL ARRANGE FOR WEEKLY MEETINGS DURING OCTOBER 1ST TO APRIL 30TH FOR PROJECT TEAM (GENERAL CONTRACTOR, QUALIFIED PERSON, EROSION CONTROL SUBCONTRACTOR IF AN, ENGINEER OF WORK, OWNER/DEVELOPER AND THE RESIDENT ENGINEER) TO EVALUATE THE ADEQUACY OF THE EROSION/SEDIMENT CONTROL MEASURE AND OTHER RELATED CONSTRUCTION ACTIVITIES.

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	REV.	DATE	DESCRIPTION
	4	04/26/10	REVISION PER CALTRANS COMMENTS
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	2	01/25/10	REVISION PER PG&E POWER DESIGN
•		11/11/09	REVISION PER EXTENET REQUESTED RAD CENTER CHANGE

CURRENT ISSUE DATE

26,

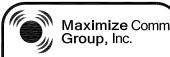

1351 POMONA ROAD SUITE 100 CORONA, CA 92882 OFFICE: (909) 786-2170 FAX: (909) 992-3113

2

GENERAL NOTES

1. 120/240 POWER REQUIRED FOR 3-WIRE SERVICE.
2. GC TO REMOVE/CLEAN ALL DEBRIS, NAILS, STAPLES, OR NON-USED VERTICALS OFF THE POLE.
3. ALL CONSTRUCTION SHALL BE IN ACCORDANCE WITH MUNICIPAL, COUNTY, STATE, FEDERAL, GO95 AND G0128 STANDARDS AND REQUILATIONS.
4. CALL USA 48 HOURS PRIOR TO EXCAVATING AT (800) 422-4133.
5. ALL LANDSCAPING TO BE RESTORED TO ORIGINAL CONDITION OR BETTER.
6. ALL EQUIPMENT TO BE BONDED.

Call Before you Dlg! 1-800-227-2600

USA North

7. METERING CABINET REQUIRES 3'[.914M] CLEARANCE AT DOOR OPENING. 8. CAULK CABINET BASE AT PAD.

STANDARD GROUNDING NOTES:

5/8"x8"[.016x2.44M] ROD, CAD WELD BELOW GRADE

#6 GROUND AND BOND WIRE

. WOOD MOLDING, STAPLED EVERY 3'[.914M] AND AT EACH END . GROUNDS 3'[.914M] FROM POLE. 6. PLACE 3 #10GA WIRES FROM BREAKER TO METER BOX.

STANDARD CONDUIT NOTES:

1. FOR UNDERGROUND USE SCHEDULE 40.
2. FOR RISERS USE SCHEDULE 80.
3. PLACE 2"[.051M] GALVANIZED STEEL CONDUIT FOR ANY CONDUIT UNDER 3"[.076M], STUB UP 10"[3.04M] THEN CONVERT TO SCHEDULE 80.
4. CONVERT 4"[.102M] CARRIER CONDUIT TO 3"[.076M] AT BASE OF POLE.
5. GC TO STUB UP POLE 10"[3.04M] w/3" POWER CONDUIT, POWER CO. TO CONVERT TROM 3"[.076M] SCH. 80 TO 2"[.051M] SCH. 80 FROM TOP OF STUB UP.

ALL CONDUIT WILL BE MAN DRILLED AND EQUIPPED WITH 3/8"[.010M] PULL ROPE.

MAINTAIN 40"[1.02M] MINIMUM COVER FOR ELECTRICAL CONDUIT.
 MAINTAIN 30"[7.62M] MINIMUM COVER FOR COMMUNICATIONS CONDUIT.
 SAND SHADING MINIMUM 1"[0.025M] UNDER CONDUITS, AND 6"[1.152M] COVERING ON TOP REQUIRED.
 ALL ELECTRICAL SERVICE CONDUITS FROM POWER COMPANY, WHETHER FROM POLES, TRANSFORMERS, OR OTHER LOCATIONS; WILL BE SLURRY BACKELIES.

5. IN STREET SLURRY TO GRADE AND MILL DOWN 1-1/2"[.038M] FOR AC CAP. 6. IN DIRT SLURRY 18"[.457M] FROM GRADE, AND FILL WITH 95% COMPACTION NATIVE SOIL FOR BALANCE.

PLACE WARNING TAPE IN TRENCH 12"[.305M] ABOVE ALL CONDUITS AND #18 WARNING TAPE ABOVE GROUND RING.

. NO BOLT THREADS TO PROTRUDE MORE THAN 1-1/2"[.038M]. . FILL ALL HOLES LEFT IN POLE FROM REARRANGEMENT OF CLIMBERS.

ALL CLIMB STEPS NEXT TO CONDUIT SHALL HAVE EXTENDED STEPS.

4. CABLE NOT TO IMPEDE 15"[.381M] CLEAR SPACE OFF POLE FACE

4. CABLE NOT TO IMPEDE 151_ASTIM] CLEAR SPACE OFF POLE FACE (12:00).
5. 90' SHORT SWEEPS UNDER ANTENNA ARM. ALL CABLES MUST ONLY TRANSITION ON THE INSIDE OR BOTTOM OF ARMS (NO CABLE ON TOP OF ARMS).
6. USE CABLE CLAMPS TO SECURE CABLE TO ARMS; PLACE 2"[0.51 M] CARRIER CABLE ID TAGS ON BOTH SIDES OF ARMS.
7. USE 90' CONNECTOR AT CABLE CONNECTION TO ANTENNAS.
8. PLACE GPS ON ARM WITH SOUTHERN SYLEXPOSURE AT MINIMUM.

S'[1.83M] FROM TRANSMIT ANTENNA, WHICH IS 24"[.61M] AWAY FROM CENTER OF POLE.

9. USE 1/2"[.013M] CABLE ON ANTENNAS UNLESS OTHERWISE

10. FILL VOID AROUND CABLES AT CONDUIT OPENING WITH FOAM SEALANT TO PREVENT WATER INTRUSION.

ANTENNA/WOOD ARM AREA TOTAL	77.48 SQ. FT.
TOP GRADE	29'-9"
BOTTOM GRADE	25'-5"
METER/BREAKER AREA TOTAL	4.33 SQ. FT.
TOP GRADE	8'-0"
BOTTOM GRADE	7'-0"
BATTERY BACK-UP AREA TOTAL	16.25 SQ. FT.
TOP GRADE	11'-8"
BOTTOM GRADE	9'-6"
DELTA DECK AREA TOTAL	10.74 SQ. FT.
TOP GRADE	14'-7"
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DELTA DECK (FUT.) AREA TOTAL	10.74 SQ. FT.
TOP GRADE	17'-6"
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EXT. RISER SIZE	4"-ø
EXT. RISER LENGTH	28'-1"
EXT. RISER BTM GRADE	14'-5"
PWR RISER SIZE	1"-ø
PWR RISER LENGTH	14'-0"
PWR RISER BTM GRADE	8'-0"

WIND LOADING INFORMATION

		ANTENNA & CABLE	SCHEDULE		
ANTENNA SECTOR	AZIMUTH	ANTENNA MAKE / MODEL	COAXIAL CABLE LENGTH	CABLES PER SECTOR	CABLE SIZE
SECTOR ALPHA	316'	KATHREIN 840 21410	45'-9"	2	1/2"
SECTOR BETA	127*	KATHREIN 840 21410	45'-9"	2	1/2"
SECTOR GAMMA					

NOTE: CONTRACTOR TO FIELD VERIFY CABLE LENGTHS PRIOR TO ORDERING, FABRICATION, OR INSTALLATION OF CABLES

HWY8435-010B

SITE NAME & ADDRESS:

HIGHWAY 84/35 NETWORK NODE OLOB

15975 SKYLINE BLVD, (ACROSS STREET) WOODS DE, CA 94062

IENERAL NOTES & SCHEDULE

KM SHEET NUMBER EVISION:

ABBREVIATION AND LEGEND

---E/T--- U.G. SERVICE CONDUCTORS

THICK(NESS)


WOOD

TOP OF PLATE (PARAPET)
TOP OF STEEL (SLAB)
TOP OF WALL

TOP OF WALL
TYPICAL
UNDER GROUND
UNDERWRITERS LABORATORY
UNLESS NOTED OTHERWISE
VERIFY IN FIELD
WIDE(WIDTH)
WITH

ROW CONSTRUCTION GENERAL NOTES

LOADING AND ANTENNA CABLE SCHEDULES

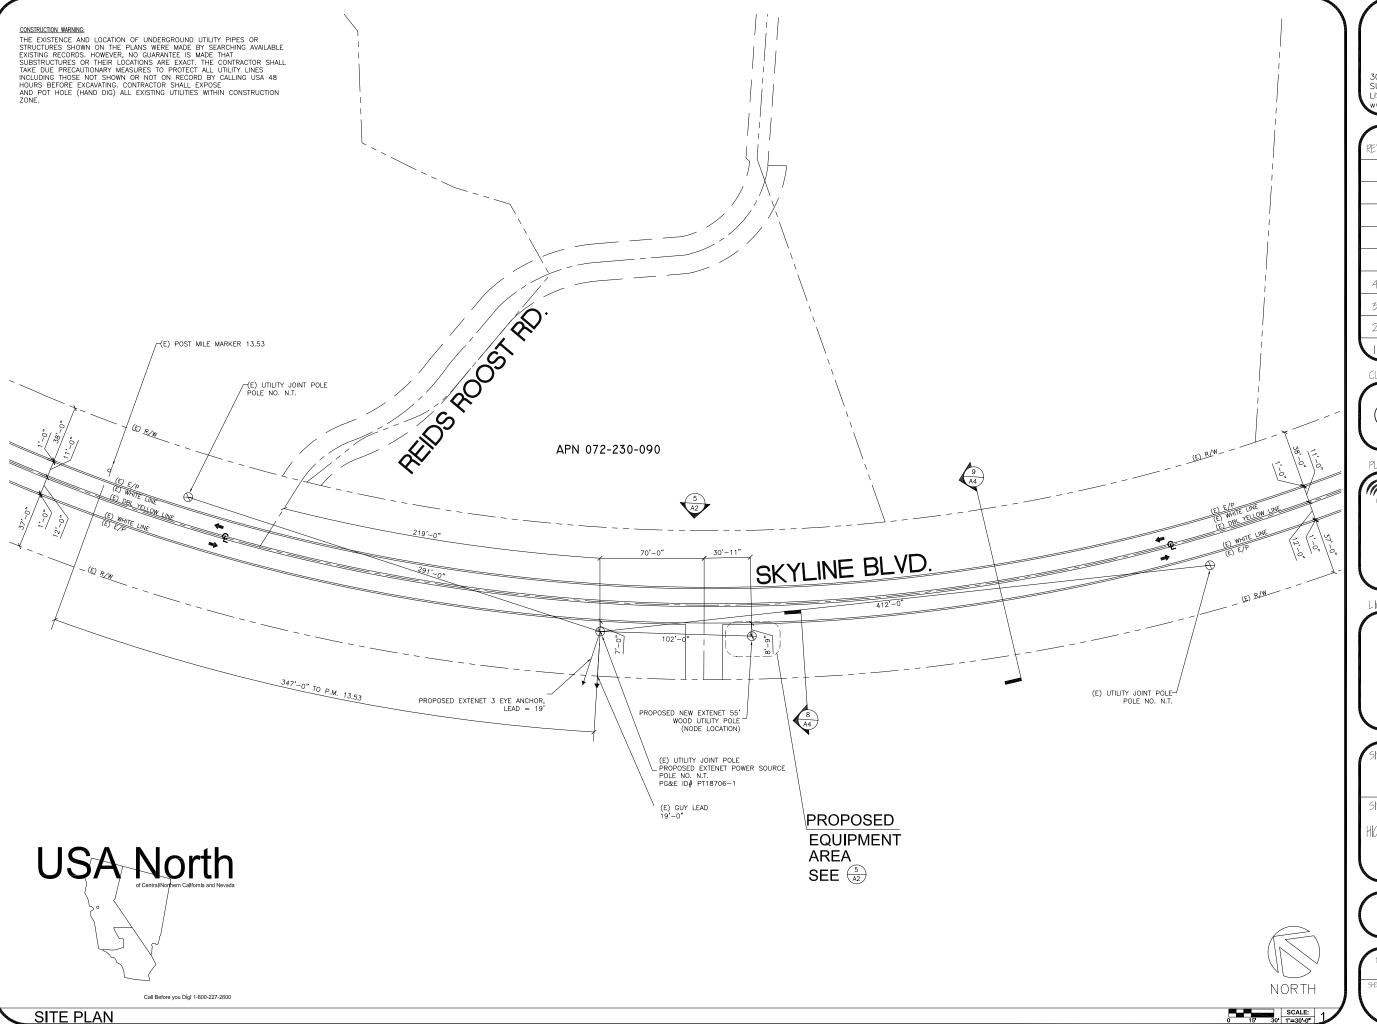



REV.	DATE	DESCRIPTION
4	04/26/10	REVISION PER CALTRANS COMMENTS
3	02/08/10	REVISION PER CALTRANS COMMENTS
2	01/25/10	REVISION PER PG&E POWER DESIGN
	11/11/09	REVISION PER EXTENET REQUESTED RAD CENTER CHANGE

CURRENT ISSUE DATE:

)4/26/

PLANS PREPARED BY:



1351 POMONA ROAD SUITE 100 CORONA, CA 92882 OFFICE: (909) 786-2170 FAX: (909) 992-3113

LICENSURE

SITE NO.:

HWY8435-010B


SITE NAME & ADDRESS:

HIGHWAY 84/35 NETWORK NODE OLOB

15975 SKYLINE BLVD. (ACROSS STREET) WOODSIDE, CA 94062

SITE PLAN

EVISION:

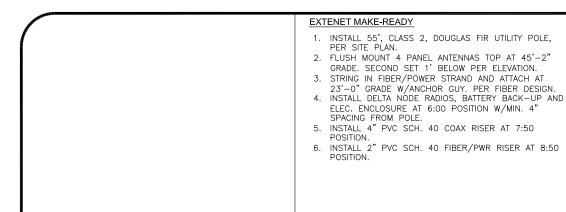

NORTH POLE ELEVATION

POWER MAKE-READY

- STRING IN SECONDARY POWER FROM PG&E POLE APPROX. 102' NORTH WEST OF PROPOSED NODE POLE. (SEE SITE PLAN/POWER DESIGN)
 INSTALL TRANSFORMER AND SECONDARY POWER FOR
- SERVICE, PER PG&E DESIGN.
- 3. INSTALL 2" PVC SCH. 80 RISER W/WEATHER HEAD AT
- 8:50 (QUAD 1) POSITION.

 4. PROVIDE 120/240V, 3—WIRE, SINGLE PHASE 100 AMP SERVICE TO 2" PG&E RISER TO EXTENET METER BOX FROM SECONDARY POWER AT 47'-0" GRADE.



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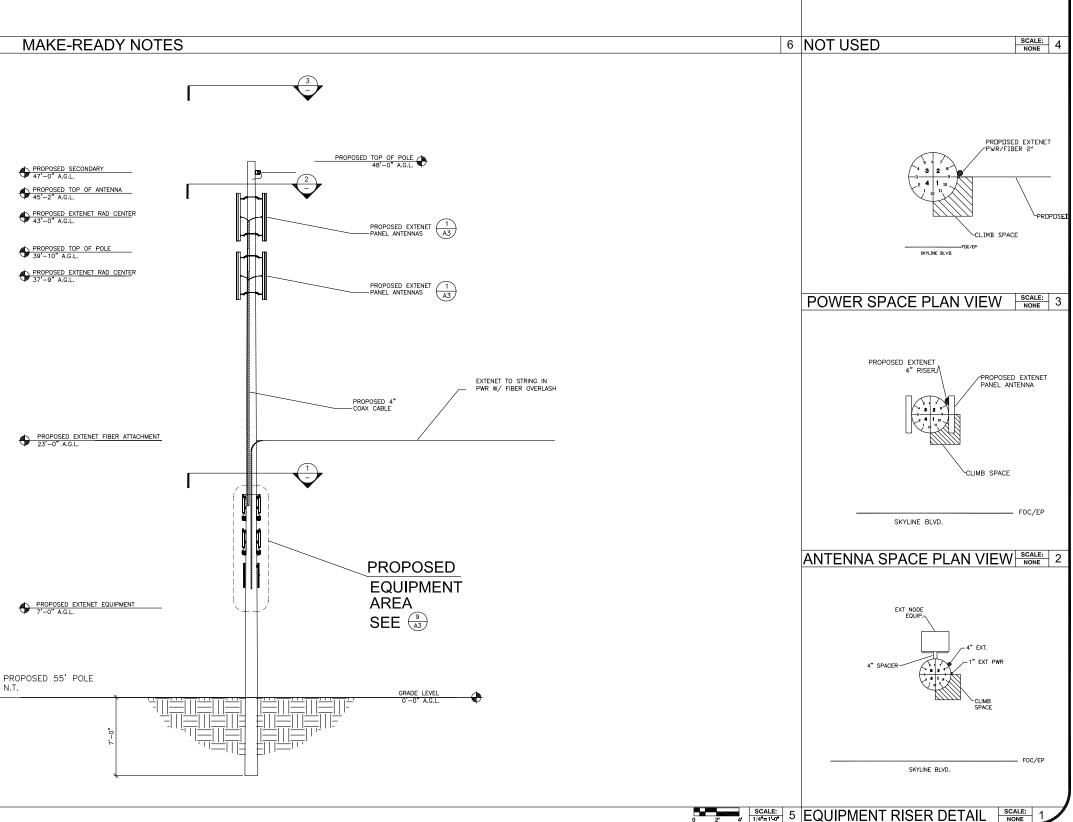
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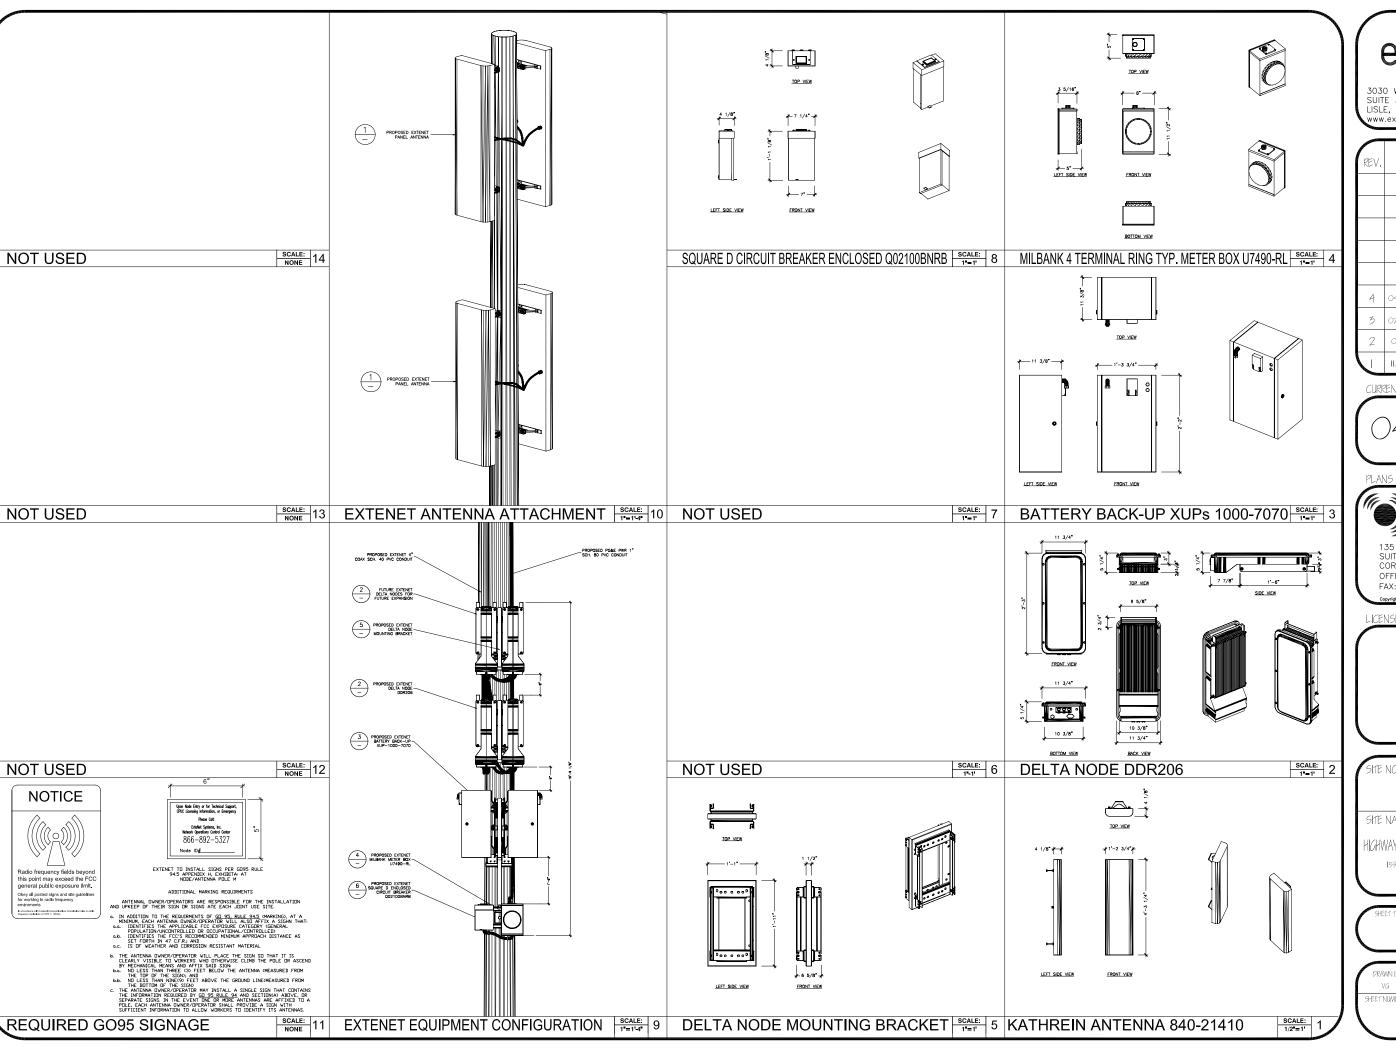
HIGHWAY 84/35 NETWORK NODE OLOB

15975 SKYLINE BLVD. (ACROSS STREET) WOODSIDE, CA 94062

ELEVATIONS & RISER DETAIL

EVISION:







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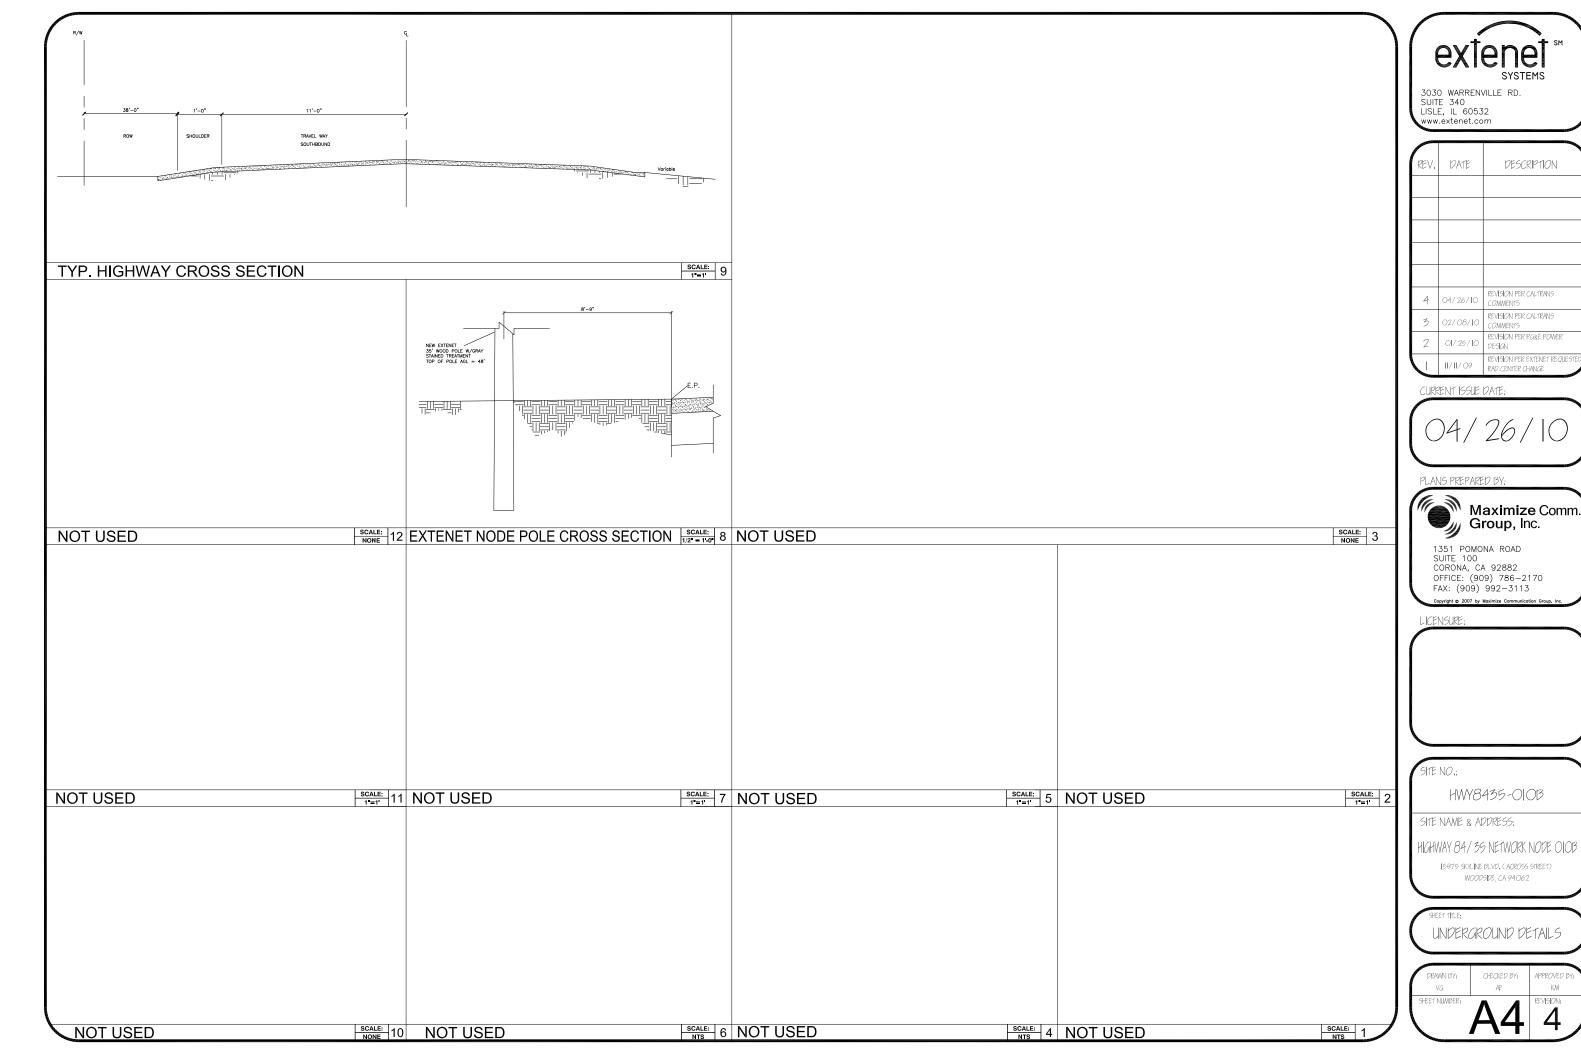
HWY8435-010B

SITE NAME & ADDRESS:

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AERIAL DETAILS


Va	CHECKED BY: AF	APPROVED BY: KM
SHEET NUMBER	73	REVISION:





SYSTEMS

HWY 35 - PROJECT HWY8435 - 011A POST MILE MARKER 13.13 16075 SKYLINE BLVD. WOODSIDE, CA 94062

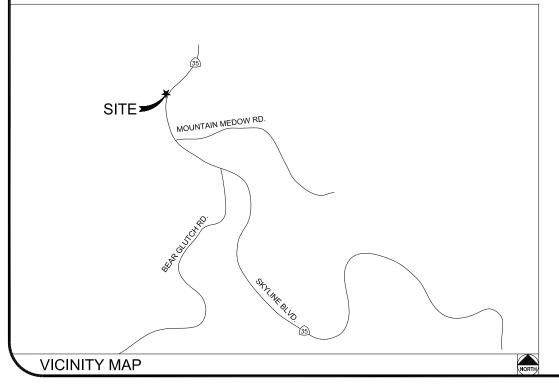

CLIENT

EXTENET SYSTEMS, INC. 3030 WARRENVILLE RD. SUITE 340 LISLE, IL 60532 CONTACT JEFF FRYE PHONE 480-626-1271 FAX 504-285-1603

EXTENET SYSTEMS, INC.
3030 WARRENVILLE RD.
SUITE 340
LISLE, IL 60532
CONTACT JEFF FRYE
PHONE 480-626-1271
FAX 504-285-1603

ENGINEERING FIRM/SURVEYING

MAXIMIZE COMMUNICATION GROUP, INC. MAXIMIZE COMMUNICATION 1351 POMONA ROAD SUITE 100 CORONA, CA 92882 CONTACT KELLI McCABE PHONE 909-786-2170 FAX 909-992-3113

COORDINATES

CODE COMPLIANCE:

ALL WORK AND MATERIALS SHALL BE PERFORMED & INSTALLED IN ACCORDANCE WITH THE CURRENT EDITIONS OF THE FOLLOWING CODES AS ADOPTED BY LOCAL GOVERNING AUTHORITIES AND LOCAL/CITY/COUNTY ORDINANCES:

1. CALIFORNIA ADMINISTRATIVE CODE (INCLUDING TITLE 24 &

- 2. 2007 CALIFORNIA BUILDING CODE.
- 3. 2007 CALIFORNIA ELECTRICAL CODE.
- 3. BUILDING OFFICIALS AND CODE ADMINISTRATORS (BOCA).
- 4. UNIFORM PLUMBING & MECHANICAL CODES.
- 5. ANSI/EIA-222-F LIFE SAFETY CODE
- 6. CALIFORNIA GENERAL ORDER 95, 128 & 165.

SHEET INDEX	
SHEET	DESCRIPTION
T1	TITLE SHEET
T2	GENERAL CONSTRUCTION NOTE & ANTENNA CABLE SCHEDULE
A1	SITE PLAN
A1.2	PLAN AND PROFILE
A2	UTILITY POLE ELEVATIONS/RISER DETAILS
A3	AERIAL DETAILS
A4	UNDERGROUND DETAILS
	NS Control of the Con



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HWY8435-011A


SITE NAME & ADDRESS:

11GHWAY 84/35 NETWORK NODE OOII

WOODSIDE CA 94062

TITLE SHEET

KM EVISION: 3

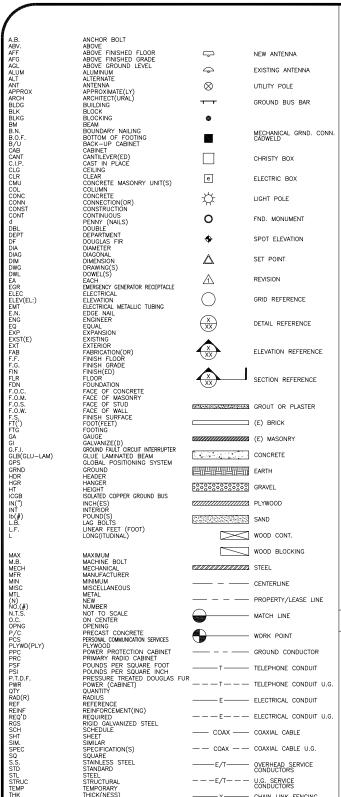

1. THE CONTRACTOR SHALL BE RESPONSIBLE FOR SURVEY MONUMENTS AND/OR VERTICAL CONTROL BENCHMARKS WHICH ARE DISTURBED OR DESTROYED BY CONSTRUCTION. A LAND SURVEYOR MUST FIELD LOCATE, REFERENCE, AND/OR PRESERVE ALL HISTORICAL OR CONTROLLING MONUMENTS PRIOR TO ANY EARTHMORK. IF DESTROYED, SUCH MONUMENTS SHALL BE REPLACED WITH APPROPRIATE MONUMENTS BY A LAND SURVEYOR. A CORNER RECORD OR RECORD OF SURVEY, AS APPROPRIATE, SHALL BE FILED AS REQUIRED BY THE PROPRESSIONAL LAURS SURVEYOR.

NUMBER BE ISSUED BEFORE A "PERMT TO EXCAVATE" WILL BE VALID. FOR YOUR DIG ALERT I.D. NUMBER, CALL UNDERGROUND SERVICE ALERT, TOLL FREE 1-800-422-4133, TWO DAYS BEFORE YOU DIG.

CROSS THE PROPOSED TRENCH LINE AND MUST MAINTAIN A 1' MINIMUM VERTICAL CLEARANCE.

4. IF ANY EXISTING HARDSCAPE OR LANDSCAPE INDICATED ON THE APPROVE PLANS IS DAMAGED OR REMOVED DURING DEMOLITION OR CONSTRUCTION, IT SHALL BE REPAIRED AND/OR REPLACED IN KIND PER THE APPROVED PLANS.

5. CONTRACTOR SHALL REPLACE OR REPAIR ALL TRAFFIC SIGNAL LOOPS, CONDUIT, AND LANE STRIPING DAMAGED DURING CONSTRUCTION.

6. THIS PROJECT WILL BE INSPECTED BY ENGINEERING AND FIELD ENGINEERING DIVISION

7. MANHOLES OR COVERS SHALL BE LABELED EXTENET

8. CONTRACTOR SHALL IMPLEMENT AN EROSION CONTROL PROGRAM DURING THE PROJECT CONSTRUCTION ACTIVITIES. THE PROGRAM SHALL MEET THE APPLICABLE REQUIREMENTS OF THE STATE WATER RESOURCE CONTROL

9. THE CONTRACTOR SHALL HAVE EMERGENCY MATERIALS AND EQUIPMENT ON HAND FOR UNFORESEEN SITUATIONS, SUCH AS DAMAGE TO UNDERGROUND WATER, SEWER, AND STORM DRAIN FACILITIES WHEREBY FLOWS MAY GENERATE EROSION AND SEDIMENT POLLUTION.

USA North

1. INDEMNIFICATION CLAUSE: THE CONTRACTOR AGREES AND SHALL:
ASSUME SOLE AND COMPLETE RESPONSIBILITY OF THE JOB SITE CONDITIONS DURING THE COURSE OF
CONSTRUCTION OF THIS PROJECT, INCLUDING THE SAFETY OF ALL PERSONS AND PROPERTIES. THAT THESE
REQUIREMENTS SHALL APPLY CONTINUOUSLY AND NOT BE LIMITED TO NORMAL WORKING HOURS AND CONDITIONS. THE CONTRACTOR FURTHER ACREES TO DEFEND INDEMNITY AND HOLD EXTENET REPRESENTATIVES AND ENGINEERS HARMLESS FROM ANY AND ALL LIABILITY, REAL OR ALLEGED IN CONNECTION WITH THE PERFORMANCE

2. PRIOR TO THE BEGINNING OF ANY CONSTRUCTION AND THROUGHOUT THE COURSE OF CONSTRUCTION WORK. THE CONTRACTOR SHALL FULLY COMPLY WITH "CALIFORNIA OCCUPATIONAL SAFETY AND HEALTH" ACT OF 1973 INCLUDING ALL REVISIONS AND AMENDMENTS THERETO.

3. ALL WORK SHALL CONFORM TO THE LATEST EDITIONS OF G095,128 AND THE STANDARD "SPECIFICATIONS FOR PUBLIC WORKS CONSTRUCTION" AS ADOPTED BY THE CITY, COUNTY OR STATE AS MODIFIED BY STANDARD PLANS

4. THE EXISTENCE AND LOCATION OF UTILITIES AND OTHER AGENCY'S FACILITIES AS SHOWN HERON ARE OBTAINED BY A SEARCH OF AVAILABLE RECORDS. OTHER FACILITIES MAY SOSTS. THE CONTRACTOR SHALL VERIFY PRIOR TO THE START OF CONSTRUCTION AND SHALL USE EXTREME CARE AND PROTECTIVE MEASURES TO OR AGENCY FACILITIES WITHIN THE LIMITS OF WORK, WHETHER THEY ARE SHOWN ON THIS PLAN OR NOT.

5. THE CONTRACTOR SHALL NOTIFY THE CITY, COUNTY OR STATE ENGINEER INSPECTION DEPARTMENT, AT LEAST TWO DAYS BEFORE START OF ANY WORK REQUIRING THEIR INVOLVEMENT.

6. THE CITY, COUNTY OR STATE SHALL SPECIFY THE EXPIRATION PERIOD OF THE PERMIT FOR THIS CONSTRUCTION PROJECT.

7. The minimum cover for all conduits placed underground shall be 36 inches to the finished grade at all times.

8. THE CONTRACTOR SHALL TUNNEL ALL CURB AND GUTTERS AND BORE ALL CONCRETE DRIVEWAYS AND WALKWAYS AT THE DIRECTION OF THE CITY, COUNTY OR STATE ENGINEER.

ALL A.C AND/OR CONCRETE PAVEMENT SHALL BE REPLACED AT THE DIRECTION OF THE CITY, COUNTY OR STATE ENGINEERS.

WORK, SHALL BE REPLANTED AND/OR REPLACED SO AS TO RESTORE THE WORK SITE TO ITS ORIGINAL CONDITION

11. THE CONTRACTOR WILL BE RESPONSIBLE FOR THE PROCESSING OF ALL APPLICANT PERMIT FORMS ALONG WITH THE REQUIRED LIABILITY INSURANCE FORMS. CLEARLY DEMONSTRATING THAT EXTENET, THE CITY, COUNTY OR STATE IS ALSO INSURED WITH THE REQUIRED LIABILITY INSURANCE IN THE AMOUNT OF \$1,000,000.00 FOR THIS

12. VAULTS, PEDESTALS, CONDUITS AND OTHER TYPES OF SUBSTRUCTURE ARE EITHER SPECIFIED ON THIS PLAN OR WILL BE SPECIFIED BY THE CONSTRUCTION ENGINEER. ANY AND ALL DEVIATIONS FROM THE SPECIFIED TYPES OF MATERIAL MUST BE APPROVED BY THE SYSTEM ENGINEER, IN WRITING BEFORE INSTALLATION THEREOF.

13. THE CONTRACTOR SHALL VERIFY THE LOCATION OF ALL EXISTING UTILITIES IN INCLUDING SEWER LATERALS & WATER SERVICES TO INDIVIDUAL LOTS BOTH VERTICAL AND HORIZONTAL PRIOR TO COMMENCING IMPROVEMENT

14. CONTRACTOR SHALL MAKE EXPLORATION EXCAVATIONS AND LOCATE EXISTING FACILITIES SUFFICIENTLY AHEAD OF CONSTRUCTION TO PERMIT REVISIONS TO PLANS IF REVISION IS NECESSARY BECAUSE OF LOCATION OF

15. THE LOCATIONS OF ALL EXISTING UTILITIES SHOWN ON THESE PLANS ARE FROM EXISTING RECORDS AND CORROBORATED, WHERE POSSIBLE, WITH FIELD TIES. THE CONTRACTOR IS RESPONSIBLE FOR CONFIRMING THE LOCATIONS SHOWN, BOTH HORIZONIAL AND VERTICALLY. PRIOR TO CONSTRUCTION, IF EXISTING LOCATIONS VAR SUBSTANTIALLY FROM THE PLANS. THE ENGINEER SHOULD BE NOTIFIED TO MAKE ANY CONSTRUCTION CHANGES

EROSION AND SEDIMENT CONTROL NOTES

TEMPORARY EROSION/SEDIMENT CONTROL PRIOR TO COMPLETION OF FINAL IMPROVEMENTS, SHALL BE PERFORMED BY THE CONTRACTOR OR QUALIFIED PERSON AS INDICATED BELOW:

1. ALL REQUIREMENTS OF THE CITY, COUNTY AND STATE "STORM WATER STANDARDS" MUST BE INCORPORATED INTO THE DESIGN AND CONSTRUCTION OF THE PROPOSED GRADING/IMPROVMENTS CONSISTENT WITH THE APPROVED STORM WATER POLLUTION PREVENTION PLAN (SWPPP), WATER QUALITY TECHNICAL REPORT (WQTR), AND/OR WATER POLLUTION CONTROL PLAN (WPCP).

2. FOR STORM DRAIN INLETS, PROVIDE A GRAVEL BAG SILT BASIN IMMEDIATELY UPSTREAM OF INLET AS INDICATED ON DETAILS.

3. FOR INLETS LOCATED AT SUMPS ADJACENT TO TOP OF SLOPES. THE CONTRACTOR SHALL ENSURE THAT WATER PORNING TO THE SUMP IS DIRECTED INTO THE INLET AND THAT A MINIMUM OF 1.00' FREEBOARD EXISTS AND IS MAINTAINED ABOVE THE TOP OF THE INLET. IF FREEDOARD IS NOT PROVIDED BY GRADIOS SHOWN ON THESE PLANS THE CONTRACTOR SHALL PROVIDE IT VIA TEMPORARY MEASURES, I.E. GRAVEL BAGS OR DIKES.

4. THE CONTRACTOR OR QUALIFIED PERSON SHALL BE RESPONSIBLE FOR CLEANUP OF SILT AND MUD ON ADJACENT STREET(S) AND STORM DRAIN SYSTEM DUE TO CONSTRUCTION ACTIVITY.

5. THE CONTRACTOR OR QUALIFIED PERSON SHALL CHECK AND MAINTAIN ALL LINED AND UNLINED DITCHES AFTER EACH RAINFALL.

6. THE CONTRACTOR SHALL REMOVE SILT AND DEBRIS AFTER EACH MAJOR RAINFALL

B. THE CONTRACTOR SHALL RESTORE ALL EROSION/SEDIMENT CONTROL DEVICES TO WORKING ORDER TO THE SATISFACTION OF THE CITY ENGINEER OF RESIDENT ENGINEER AFTER EACH RUN-OFF PRODUCING RAINFALL.

THE CONTRACTOR SHALL INSTALL ADDITIONAL EROSION/SEDIMENT CONTROL MEASURES AS MAY BE REQUIRED BY THE RESIDENT ENGINEER DUE TO UNCOMPLETED GRADING OPERATIONS OR UNFORESEEN CIRCUMSTANCES,

10. THE CONTRACTOR SHALL BE RESPONSIBLE AND SHALL TAKE NECESSARY PRECAUTIONS TO PREVENT PUBLIC TRESPASS ONTO AREAS WHERE IMPOUNDED WATERS CREATE A HAZARDOUS CONDITION.

11. ALL EROSION/SEDIMENT CONTROL MEASURES PROVIDED PER THE APPROVED GRADING PLAN SHALL BE NCORPORATED HERON. ALL EROSION/SEDIMENT CONTROL FOR INTERIM CONDITIONS SHALL BE DONE TO THE SATISFACTION OF THE RESIDENT ENGINEER.

12. GRADED AREAS AROUND THE PROJECT PERIMETER MUST DRAIN AWAY FROM THE FACE OF THE SLOPE AT THE CONCLUSION OF EACH WORKING DAY.

13. ALL REMOVABLE PROTECTIVE DEVICES SHOWN SHALL BE IN PLACE AT THE END OF EACH WORKING DAY WHEN RAIN IS IMMINENT.

14. THE CONTRACTOR SHALL ONLY GRADE, INCLUDING CLEARING AND GRUBBING FOR THE AREAS FOR WHICH THE CONTRACTOR OR QUALIFIED PERSON CAN PROVIDE EROSION/SEDIMENT CONTROL MEASURES.

15. THE CONTRACTOR SHALL ARRANGE FOR WEEKLY MEETINGS DURING OCTOBER 1ST TO APRIL 30TH FOR PROJECT TEAM (GENERAL CONTRACTOR, QUALIFIED PERSON, EROSION CONTROL SUBCONTRACTOR IF AN, ENGINEER OF WORK, OWNER/DEVELOPER AND THE RESIDENT ENGINEER) TO EVALUATE THE ADEQUACY OF THE EROSION/SEDIMENT CONTROL MEASURE AND OTHER RELATED CONSTRUCTION ACTIVITIES.

ANTENNA & CABLE SCHEDULE

24

25

2

2

MAKE / MODEL

840 21410

KATHREIN

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26,



1351 POMONA ROAD SUITE 100 CORONA, CA 92882 OFFICE: (909) 786-2170 FAX: (909) 992-3113

2

CABLE SIZE

1/2"

1/2"

HWY8435-011A

SITE NAME & ADDRESS:

HGHWAY 84/35 NETWORK NODE OOHA

16075 SKYLINE BLVD. WOODSIDE CA 94062

IENERAL NOTES & SCHEDULE

DRAWN BY:	CHECKED BY: AF	APPROVED E
SHEET NUMBER:	T2	3

Call Before you Dlg! 1-800-227-2600

GENERAL NOTES

1. 120/240 POWER REQUIRED FOR 3-WIRE SERVICE.
2. GC TO REMOVE/CLEAN ALL DEBRIS, NAILS, STAPLES, OR NON-USED VERTICALS OFF THE POLE.
3. ALL CONSTRUCTION SHALL BE IN ACCORDANCE WITH MUNICIPAL, COUNTY, STATE, FEDERAL, GO95 AND G0128 STANDARDS AND REQUILATIONS.
4. CALL USA 48 HOURS PRIOR TO EXCAVATING AT (800) 422-4133.
5. ALL LANDSCAPING TO BE RESTORED TO ORIGINAL CONDITION OR BETTER.
6. ALL EQUIPMENT TO BE BONDED.

7. METERING CABINET REQUIRES 3'[.914M] CLEARANCE AT DOOR OPENING. 8. CAULK CABINET BASE AT PAD.

STANDARD GROUNDING NOTES:

5/8"x8'[.016x2.44M] ROD, CAD WELD BELOW GRADE #6 GROUND AND BOND WIRE

. WOOD MOLDING, STAPLED EVERY 3'[.914M] AND AT EACH END

6. PLACE 3 #10GA WIRES FROM BREAKER TO METER BOX.

STANDARD CONDUIT NOTES:

. FOR UNDERGROUND USE SCHEDULE 40. . FOR RISERS USE SCHEDULE 80.

2. FUN RISENS USE SCHEUULE 80.

3. PLACE 2", OSTM) GALVANIZED STEEL CONDUIT FOR ANY CONDUIT UNDER 3", O.76M), STUB UP 10", 3.04M) THEN CONVERT TO SCHEDULE 80.

4. CONVERT 4", 102M) CARRIER CONDUIT TO 3", 0.76M) AT BASE OF POLE.

5. GC TO STUB UP POLE 10", 3.04M) W/3" POWER CONDUIT, POWER CO. TO CONVERT FROM 3", 0.76M) SCH. 80 TO 2", 0.51M] SCH. 80 FROM TOP OF STUB UP.

ALL CONDUIT WILL BE MAN DRILLED AND EQUIPPED WITH 3/8"[.010M] PULL ROPE.

MAINTAIN 40"[1.02M] MINIMUM COVER FOR ELECTRICAL CONDUIT.
 MAINTAIN 30"[7.62M] MINIMUM COVER FOR COMMUNICATIONS CONDUIT.
 SAND SHADING MINIMUM 1"[0.025M] UNDER CONDUITS, AND 6"[1.152M] COVERING ON TOP REQUIRED.
 ALL ELECTRICAL SERVICE CONDUITS FROM POWER COMPANY, WHETHER FROM POLES, TRANSFORMERS, OR OTHER LOCATIONS; WILL BE SLURRY BACKELIES.

5. IN STREET SLURRY TO GRADE AND MILL DOWN 1-1/2"[.038M] FOR AC CAP. 6. IN DIRT SLURRY 18"[.457M] FROM GRADE, AND FILL WITH 95% COMPACTION NATIVE SOIL FOR BALANCE.

PLACE WARNING TAPE IN TRENCH 12"[.305M] ABOVE ALL CONDUITS AND #18 WARNING TAPE ABOVE GROUND RING.

. NO BOLT THREADS TO PROTRUDE MORE THAN 1-1/2"[.038M]. . FILL ALL HOLES LEFT IN POLE FROM REARRANGEMENT OF CLIMBERS.

ALL CLIMB STEPS NEXT TO CONDUIT SHALL HAVE EXTENDED STEPS.

4. CABLE NOT TO IMPEDE 15"[.381M] CLEAR SPACE OFF POLE FACE

4. CABLE NOT TO IMPEDE 151_ASTIM] CLEAR SPACE OFF POLE FACE (12:00).
5. 90' SHORT SWEEPS UNDER ANTENNA ARM. ALL CABLES MUST ONLY TRANSITION ON THE INSIDE OR BOTTOM OF ARMS (NO CABLE ON TOP OF ARMS).
6. USE CABLE CLAMPS TO SECURE CABLE TO ARMS; PLACE 2"[0.51 M] CARRIER CABLE ID TAGS ON BOTH SIDES OF ARMS.
7. USE 90' CONNECTOR AT CABLE CONNECTION TO ANTENNAS.
8. PLACE GPS ON ARM WITH SOUTHERN SY EXPOSURE AT MINIMUM.

S'[1.83M] FROM TRANSMIT ANTENNA, WHICH IS 24"[.61M] AWAY FROM CENTER OF POLE.

9. USE 1/2"[.013M] CABLE ON ANTENNAS UNLESS OTHERWISE

FILL VOID AROUND CABLES AT CONDUIT OPENING WITH FOAM SEALANT TO PREVENT WATER INTRUSION.

TOTAL ANIENNA/WOOD ARM AREA	77.48 SQ. FT.	
TOP GRADE	38'-3"	
BOTTOM GRADE	34'-0"	
METER/BREAKER AREA TOTAL	4.33 SQ. FT.	
TOP GRADE	8'-0"	
BOTTOM GRADE	7'-0"	
BATTERY BACK-UP AREA TOTAL	16.25 SQ. FT.	
TOP GRADE	11'-8"	
BOTTOM GRADE	9'-6"	
DELTA DECK AREA TOTAL	10.74 SQ. FT.	
TOP GRADE	14'-7"	
BOTTOM GRADE 12'-5"		
DELTA DECK (FUT.) AREA TOTAL	10.74 SQ. FT.	
TOP GRADE	17'-6"	
BOTTOM GRADE	15'-4"	
EXT. RISER SIZE	4"ø	
EXT. RISER LENGTH	23'-9"	
EXT. RISER BTM GRADE	15'-11"	
PWR RISER SIZE	2"ø	
PWR RISER LENGTH 8'-0"		
PWR RISER BTM GRADE	0'-0"	

ANTENNA/WOOD ARM AREA TOTAL	77.48 SQ. FT.
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PWR RISER SIZE	2"ø
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LOADING AND ANTENNA CABLE SCHEDULES

ANTENNA SECTOR

AI PHA


SECTOR

AZIMUTH

TOP OF PLATE (PARAPET)
TOP OF STEEL (SLAB)
TOP OF WALL

TOP OF WALL
TYPICAL
UNDER GROUND
UNDERWRITERS LABORATORY
UNLESS NOTED OTHERWISE
VERIFY IN FIELD
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WITH

WOOD

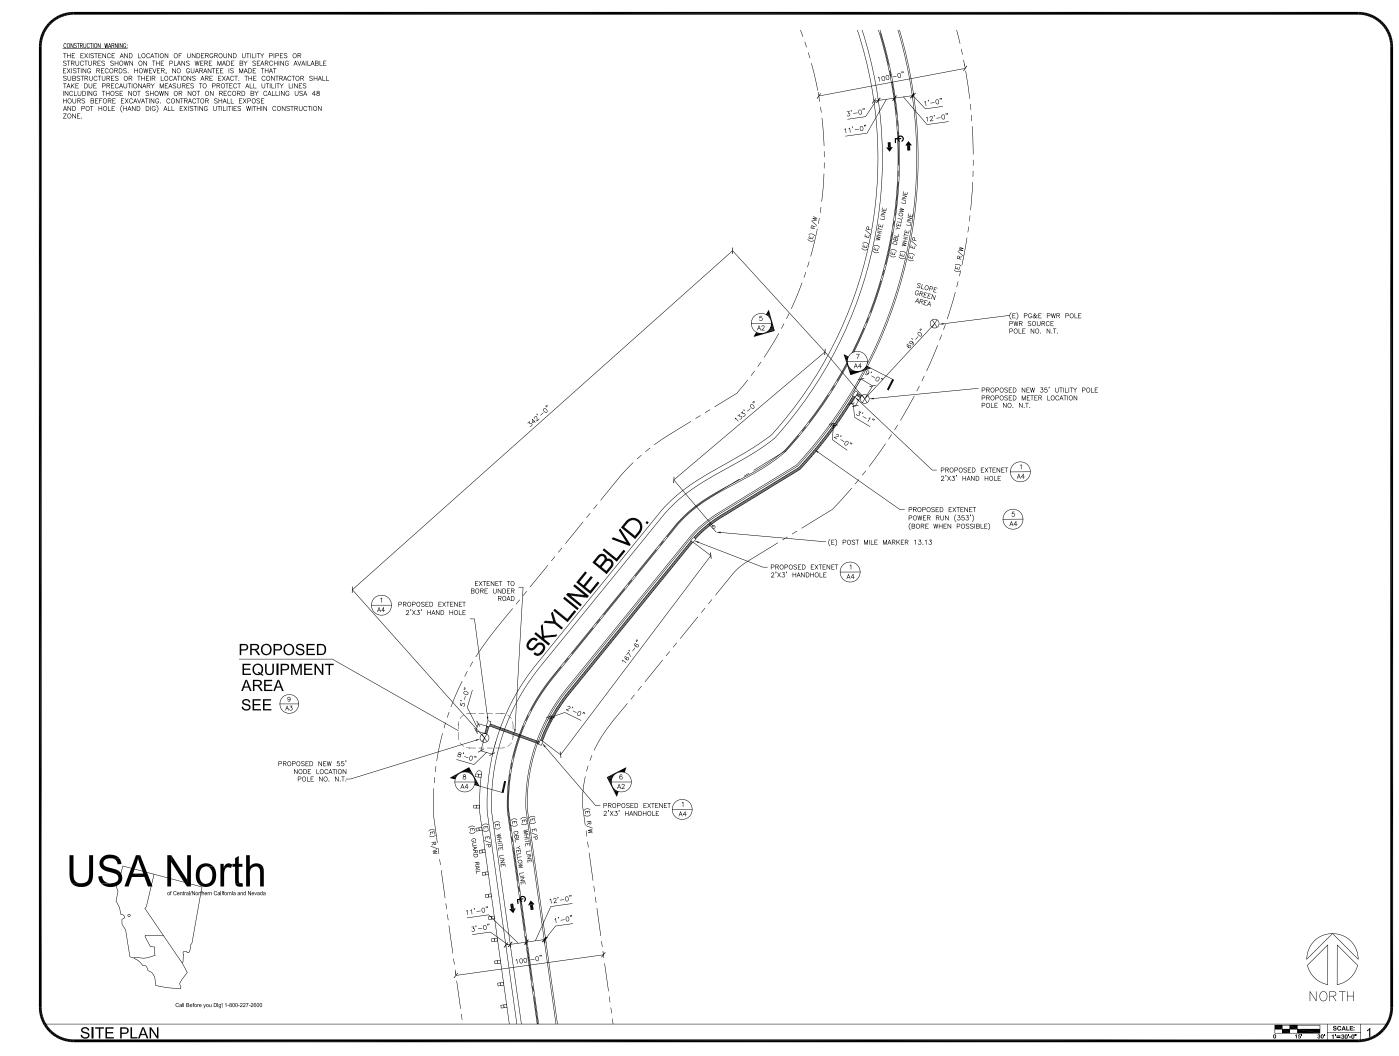



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PLANS PREPARED BY:



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LICENSURE:



SITE NO.:

HWY8435-011A

SITE NAME & ADDRESS:

HIGHWAY 84/35 NETWORK NODE OOIIA

16075 SKYLINE BLVD. WOODSIDE, CA 94062

SHEET 11

SITE PLAN

DRAWN BY: MG	CHECKED BY: AF	APPROVED BY
SHEET NUMBER	7 4	REVISION:


CONSTRUCTION WARNING:

THE EXISTENCE AND LOCATION OF UNDERGROUND UTILITY PIPES OR STRUCTURES SHOWN ON THE PLANS WERE MADE BY SEARCHING AVAILABLE EXISTING RECORDS. HOWEVER, NO GUARANTEE IS MADE THAT SUBSTRUCTURES OR THEIR LOCATIONS ARE EXACT. THE CONTRACTOR SHALL TAKE DUE PRECAUTIONARY MEASURES TO PROTECT ALL UTILITY LINES INCLUDING THOSE NOT SHOWN OR NOT ON RECORD BY CALLING USA 48 HOURS BEFORE EXCAVATING. CONTRACTOR SHALL EXPOSE AND POT HOLE (HAND DIG) ALL EXISTING UTILITIES WITHIN CONSTRUCTION ZONE.



Call Before you Dig! 1-800-227-2600

EXTENET NEW FACILITIES PROFILE

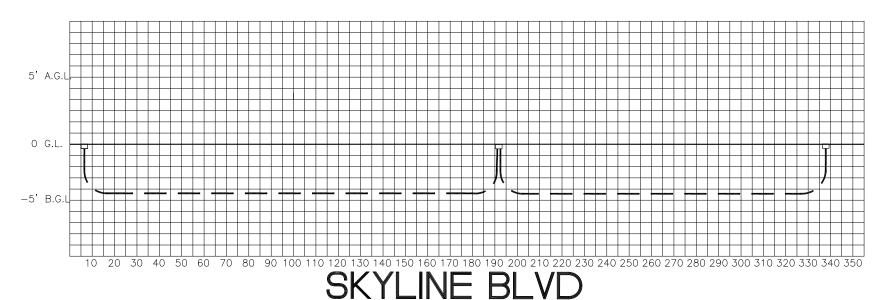

ME) DEL YELLON LINE SKYLINE BLVD. (E) DEL VELLON LINE




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ackslash	11/11/09	REVISION PER EXTENET REQUESTED RAD CENTER CHANGE

CURRENT ISSUE DATE:

04/26/10

PLANS PREPARED BY

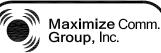

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SITE NO.:

HWY8435-011A

SITE NAME & ADDRESS:

HIGHWAY 84/35 NETWORK NODE OOIIA

16075 SKYLINE BLVD. WOODSIDE, CA 94062

PLAN AND PROFILE

DRAWN BY: MG SHEET NUMBER:_	CHECKED BY: AF	APPROVED BY: KM REVISION:
A	1.2	3 /

PLAN AND PROFILE

PROPOSED NEW NODE POLE PROPOSED TOP OF POLE 48'-0" A.G.L. MAKE-READY NOTES PROPOSED EXTENET TOP OF ANTENNA 42'-2" A.G.L. PROPOSED EXTENET RAD CENTER 40'-0" A.G.L. PROPOSED EXTENET 1 KATHREIN ANTENNAS A3 PROPOSED EXTENET TOP OF ANTENNA 36'-10" A.G.L. PROPOSED EXTENET RAD CENTER 34'-9" A.G.I. PROPOSED EXTENET 1 KATHREIN ANTENNAS A3 PROPOSED EXTENET -4" SCH. 40 PVC RISER FUTURE EXTENET DELTA NODES -FOR FUTURE EXPANSION A3 PROPOSED EXTENET DELTA NODES **PROPOSED** PROPOSED $\begin{pmatrix} 7 \\ A3 \end{pmatrix} \begin{pmatrix} 3 \\ A3 \end{pmatrix}$ **EQUIPMENT** -EXTENET XUP'S **AREA** SEE (9) PROPOSED EXTENET -2" FIBER RISER PROPOSED EXTENET 2" PWR RISER PROPOSED NEW 55' POLE CLASS 2 N.T. PROPOSED ELEVATION WEST

EXTENET MAKE-READY

- INSTALL NEW 55' CLASS 2 NODE POLE IN ROW (SEE SITE PLAN FOR LOCATION) POLE IS CUSTOMER OWNED.
- 2. INSTALL NEW 35' CLASS 3 SERVICE POLE IN ROW. METER TO BE SET ON SERVICE POLE(SEE SITE PLAN
- 3. FLUSH MOUNT TOP OF ANTENNA AT 42'-2" GRADE, (2) 51" PANEL ANT. (KATHREIN 840 21410) ON NODE POLE. ALSO ADD SECOND SET OF ANTENNAS AT 36'-10" GRADE.
- 4. INSTALL EXTENET NODE EQUIPMENT TO STAND-OFF BRACKET (4" OFF OF POLE) AT THE 3:00 POSITION (BETWEEN QUAD. 3-4) ON NODE POLE
- 5. INSTALL METER TO STAND-OFF BRACKET (4" OFF OF THE POLE) TO SERVICE POLE AT 3:00 POSITION.
- (BETWEEN QUAD 1-2) 6. INSTALL 4" EXT CONDUIT AT 2:00 POSITION ON NODE
- 7. INSTALL 2" EXT. CONDUIT AT 2:50 POSITION ON SERVICE POLE
- 8. INSTALL 2" EXT FIBER CONDUIT AT 12:00 POSITION ON NODE POLE
- 9. INSTALL 2" EXT. PWR CONDUIT AT 1:00 POSITION ON NODE POLE
- STRING IN EXTENET FIBER AND ATTACH AT PER FIBER CONTRACTOR GRADE.

POWER MAKE-READY

- 1. PG&E TO STRING IN SECONDARY POWER TO EXTENET SERVICE POLE IN ROW APPROX 69' WEST OF PG&E POLE LOCATION. (SEE SITE PLAN FOR LOCATION)
- 2. INSTALL 2" PG&E CONDUIT AT 1:00 (QUAD 1) POSITION (WITH WEATHER HEAD)
- PROVIDE 120/240 3-WIRE SINGLE PHASE, 100 AMP SERVICE TO 1" PG&E CONDUIT TO EXTENET METER BOX FROM SECONDARY.



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JCENSURE

CLIMB SPACE

PROPOSED EXTENET ANTENNAS

FOC/EF

FOC/EF

HWY8435-011A


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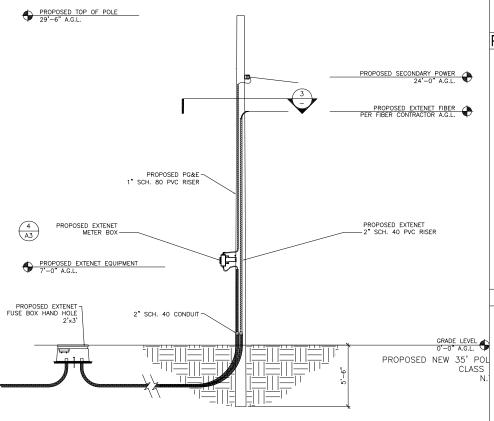
HGHWAY 84/35 NETWORK NODE OOHA 16075 SKYLINE BLVD.

WOODSIDE, CA 94062

LEVATIONS & RISER DETAIL:

SHEET NUMBER EVISION: 3



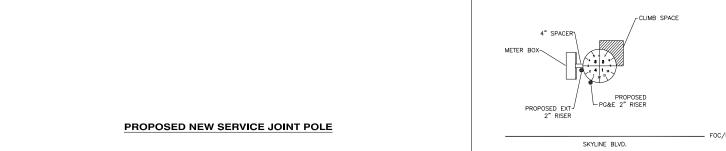


POWER/SERVICE POLE RISE DETAIL SCALE: 3 PROPOSED EXTENET SKYLINE BLVD. COMMUNICATION SPACE PLAN VIEW | SCALE: | 2 EXTENET NODE EQUIP

4" EXT-2" EXT PWR-2" EXT FIBER-

SCALE: 5 EQUIP. SPACE PLAN VIEW SCALE: NONE

PROPOSED ELEVATION NORTH EAST

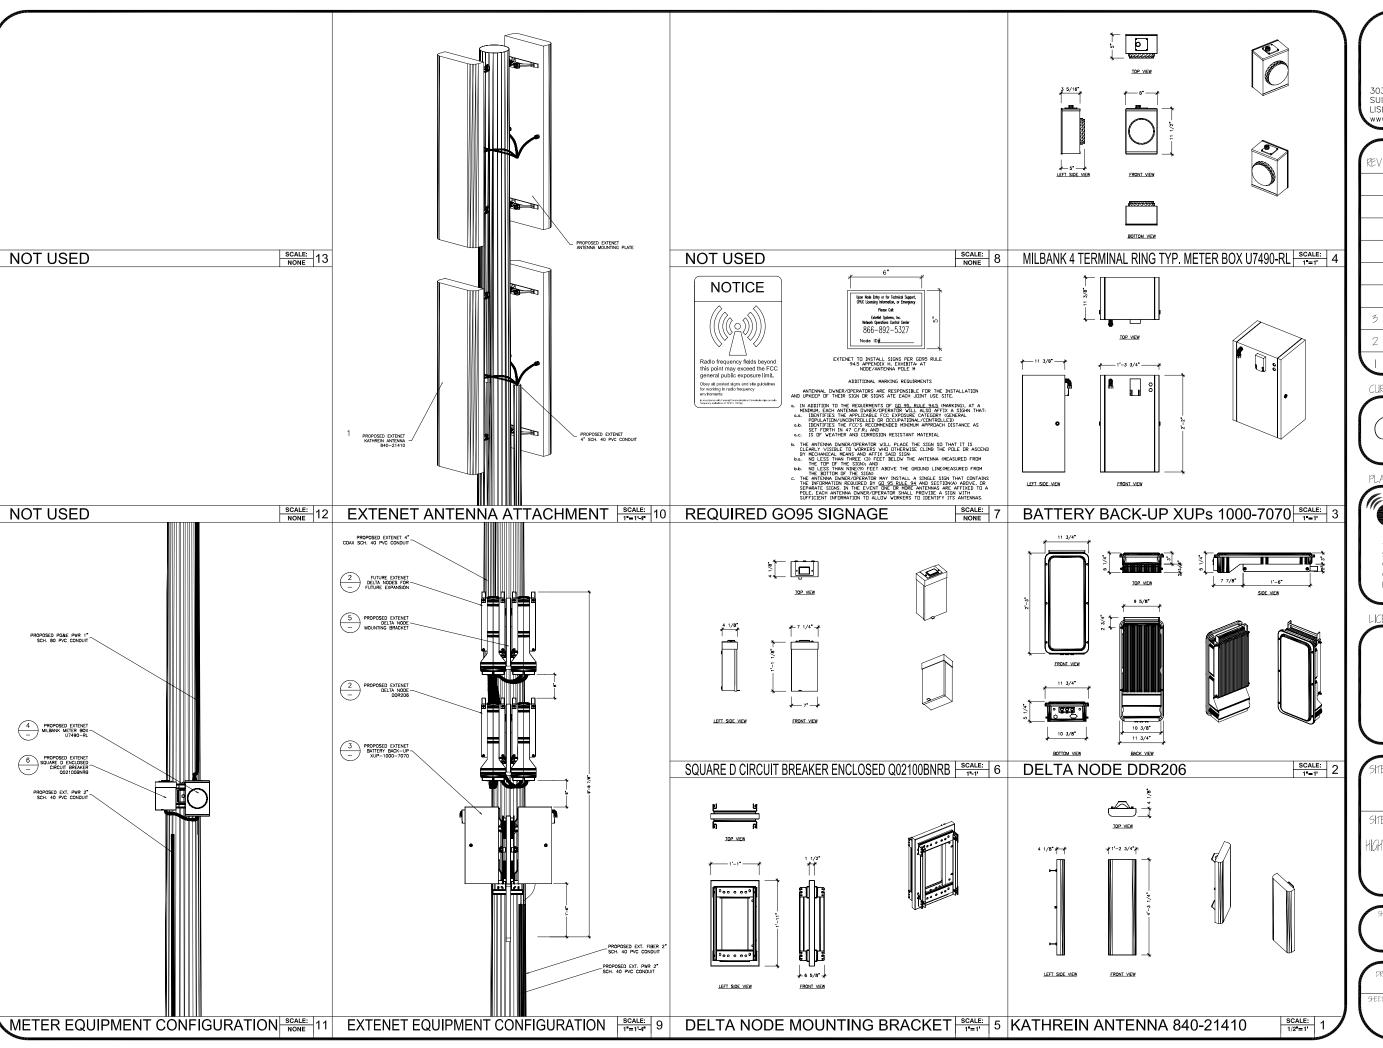



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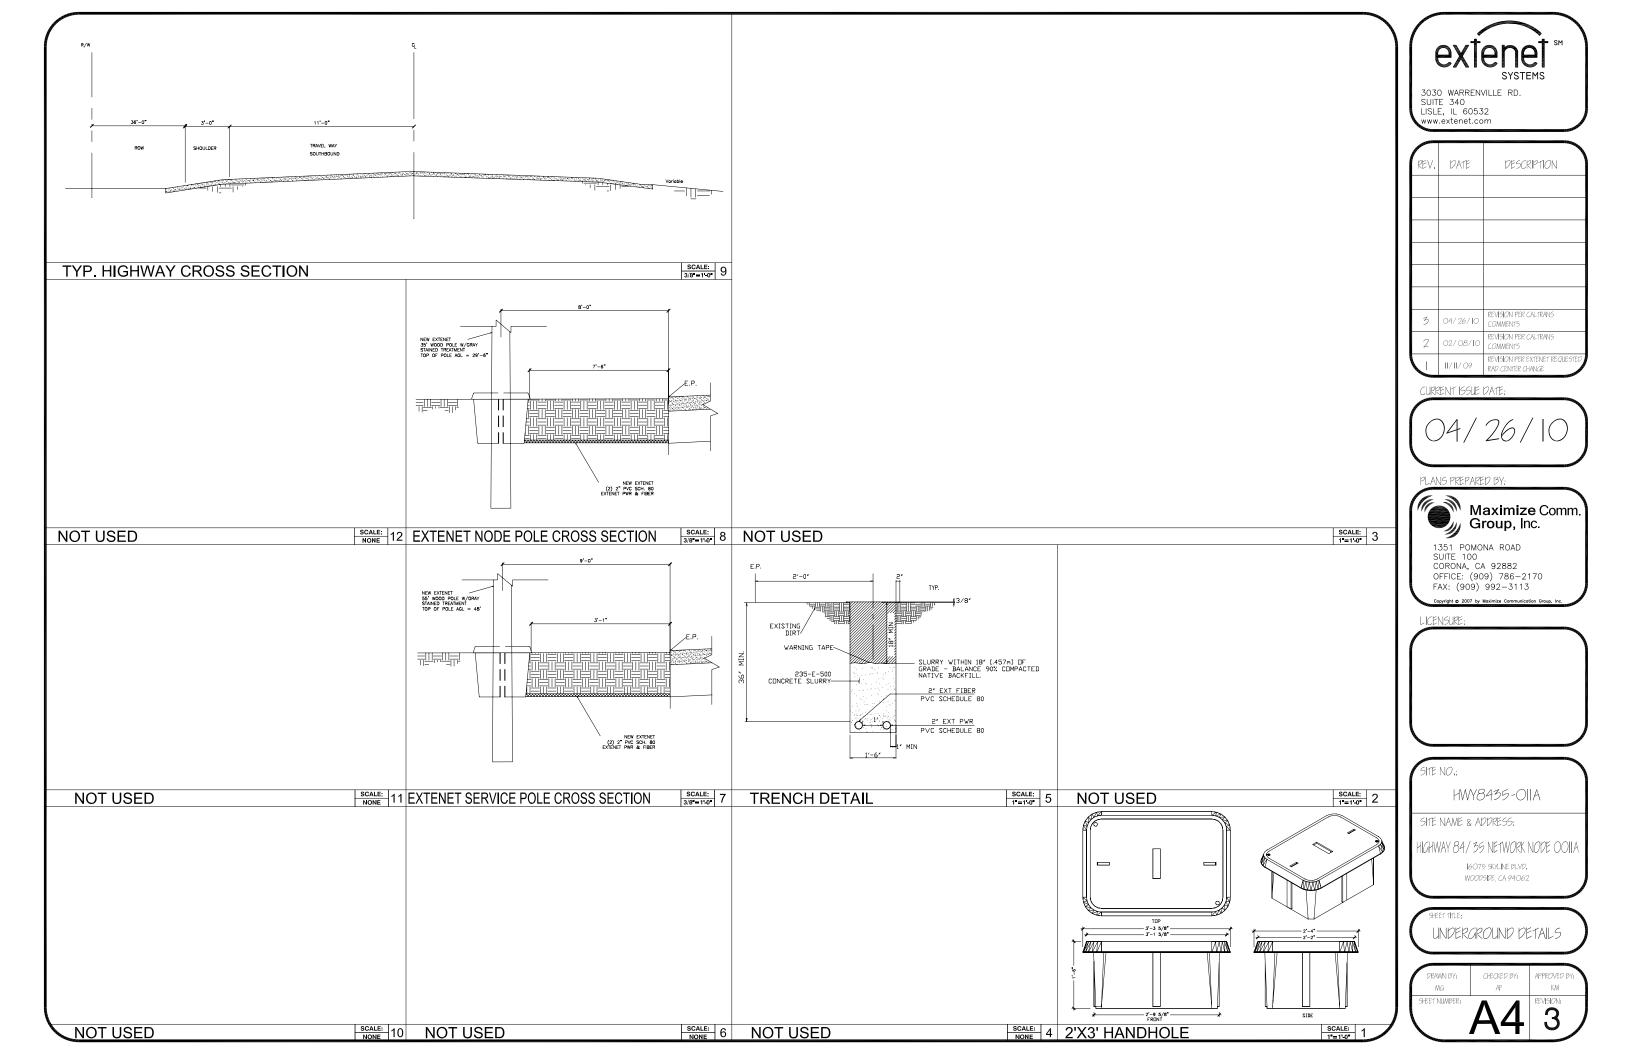
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16075 SKYLINE BLVD. WOODSIDE, CA 94062

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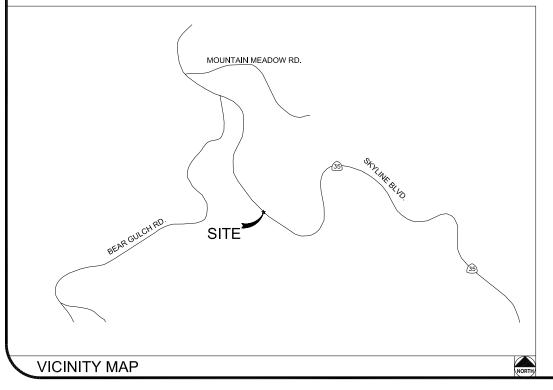
AERIAL DETAILS

DRAWN BY: MG	CHECKED BY: AF	APPROVED BY:
SHEET NUMBER:	A3	3





HWY 35 - PROJECT HWY8435 - 012B POST MILE MARKER 12.60 30 MPH SIGN SKYLINE BLVD. WOODSIDE, CA 94062



CLIENT

EXTENET SYSTEMS, INC. 3030 WARRENVILLE RD. SUITE 340 LISLE, IL 60532 CONTACT JEFF FRYE PHONE 480-626-1271 FAX 504-285-1603

EXTENET SYSTEMS, INC. 3030 WARRENVILLE RD. SUITE 340 LISLE, IL 60532 CONTACT JEFF FRYE PHONE 480-626-1271 FAX 504-285-1603

ENGINEERING FIRM/SURVEYING

MAXIMIZE COMMUNICATION GROUP, INC. MAXIMIZE COMMUNICATIO 1351 POMONA ROAD SUITE 100 CORONA, CA 92882 CONTACT KELLI McCABE PHONE 909-786-2170 FAX 909-992-3113

COORDINATES

CODE COMPLIANCE:

ALL WORK AND MATERIALS SHALL BE PERFORMED & INSTALLED IN ACCORDANCE WITH THE CURRENT EDITIONS OF THE FOLLOWING CODES AS ADOPTED BY LOCAL GOVERNING AUTHORITIES AND LOCAL/CITY/COUNTY ORDINANCES:

1. CALIFORNIA ADMINISTRATIVE CODE (INCLUDING TITLE 24 &

- 3. 2007 CALIFORNIA ELECTRICAL CODE.
- 3. BUILDING OFFICIALS AND CODE ADMINISTRATORS (BOCA).
- 4. UNIFORM PLUMBING & MECHANICAL CODES.
- 5. ANSI/EIA-222-F LIFE SAFETY CODE
- 6. CALIFORNIA GENERAL ORDER 95, 128 & 165.

	SHEET INDEX				
SHEET	DESCRIPTION				
T1	TITLE SHEET				
T2	GENERAL CONSTRUCTION NOTE & ANTENNA CABLE SCHEDULE				
A1	SITE PLAN				
A2	UTILITY POLE ELEVATIONS/RISER DETAILS				
A3	AERIAL DETAILS				
A4	UNDERGROUND DETAILS				



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CURRENT ISSUE DATE:





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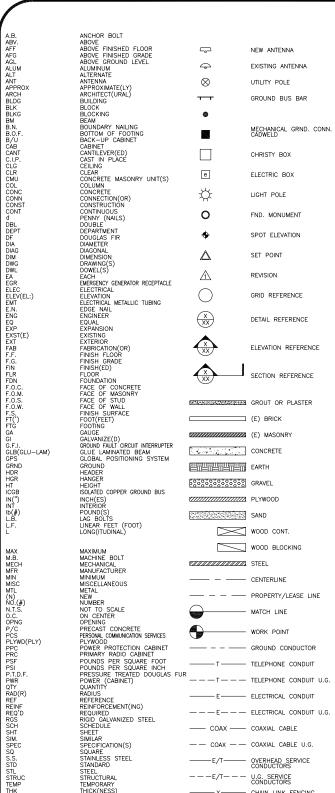
SITE NAME & ADDRESS:

HIGHWAY 84/35 NETWORK NODE OI 2E

30 MPH SIGN SKYLINE BLVD. WOODSIDE CA 94062

TITLE SHEET

AF	KM
	REVISION:



1. THE CONTRACTOR SHALL BE RESPONSIBLE FOR SURVEY MONUMENTS AND/OR VERTICAL CONTROL BENCHMARKS WHICH ARE DISTURBED OR DESTROYED BY CONSTRUCTION. A LAND SURVEYOR MUST FIELD LOCATE, REFERENCE, AND/OR PRESERVE ALL HISTORICAL OR CONTROLLING MONUMENTS PRIOR TO ANY EARTHMORK. IF DESTROYED, SUCH MONUMENTS SHALL BE REPLACED WITH APPROPRIATE MONUMENTS BY A LAND SURVEYOR. A CORNER RECORD OR RECORD OF SURVEY, AS APPROPRIATE, SHALL BE FILED AS REQUIRED BY THE PROPRESSIONAL LAIDS SURVEYOR.

NUMBER BE ISSUED BEFORE A "PERMT TO EXCAVATE" WILL BE VALID. FOR YOUR DIG ALERT I.D. NUMBER, CALL UNDERGROUND SERVICE ALERT, TOLL FREE 1-800-422-4133, TWO DAYS BEFORE YOU DIG.

CROSS THE PROPOSED TRENCH LINE AND MUST MAINTAIN A 1' MINIMUM VERTICAL CLEARANCE.

4. IF ANY EXISTING HARDSCAPE OR LANDSCAPE INDICATED ON THE APPROVE PLANS IS DAMAGED OR REMOVED DURING DEMOLITION OR CONSTRUCTION, IT SHALL BE REPAIRED AND/OR REPLACED IN KIND PER THE APPROVED PLANS.

5. CONTRACTOR SHALL REPLACE OR REPAIR ALL TRAFFIC SIGNAL LOOPS, CONDUIT, AND LANE STRIPING DAMAGED DURING CONSTRUCTION.

6. THIS PROJECT WILL BE INSPECTED BY ENGINEERING AND FIELD ENGINEERING DIVISION

7. MANHOLES OR COVERS SHALL BE LABELED EXTENET

8. CONTRACTOR SHALL IMPLEMENT AN EROSION CONTROL PROGRAM DURING THE PROJECT CONSTRUCTION ACTIVITIES. THE PROGRAM SHALL MEET THE APPLICABLE REQUIREMENTS OF THE STATE WATER RESOURCE CONTROL

9. THE CONTRACTOR SHALL HAVE EMERGENCY MATERIALS AND EQUIPMENT ON HAND FOR UNFORESEEN SITUATIONS, SUCH AS DAMAGE TO UNDERGROUND WATER, SEWER, AND STORM DRAIN FACILITIES WHEREBY FLOWS MAY GENERATE EROSION AND SEDIMENT POLLUTION.

USA North

ENGINEERS HARMLESS FROM ANY AND ALL LIABILITY, REAL OR ALLEGED IN CONNECTION WITH THE PERFORMANCE 2. PRIOR TO THE BEGINNING OF ANY CONSTRUCTION AND THROUGHOUT THE COURSE OF CONSTRUCTION WORK. THE CONTRACTOR SHALL FULLY COMPLY WITH "CALIFORNIA OCCUPATIONAL SAFETY AND HEALTH" ACT OF 1973 INCLUDING ALL REVISIONS AND AMENDMENTS THERETO.

3. ALL WORK SHALL CONFORM TO THE LATEST EDITIONS OF G095,128 AND THE STANDARD "SPECIFICATIONS FOR PUBLIC WORKS CONSTRUCTION" AS ADOPTED BY THE CITY, COUNTY OR STATE AS MODIFIED BY STANDARD PLANS

1. INDEMNIFICATION CLAUSE: THE CONTRACTOR AGREES AND SHALL:
ASSUME SOLE AND COMPLETE RESPONSIBILITY OF THE JOB SITE CONDITIONS DURING THE COURSE OF
CONSTRUCTION OF THIS PROJECT, INCLUDING THE SAFETY OF ALL PERSONS AND PROPERTIES. THAT THESE
REQUIREMENTS SHALL APPLY CONTINUOUSLY AND NOT BE LIMITED TO NORMAL WORKING HOURS AND CONDITIONS.

4. THE EXISTENCE AND LOCATION OF UTILITIES AND OTHER AGENCY'S FACILITIES AS SHOWN HERON ARE OBJUSTED BY A SEARCH OF AVAILABLE RECORDS. OTHER FACILITIES MAY EXIST. THE CONTRACTOR SHALL VERIFY PRIOR TO THE START OF CONSTRUCTION AND SHALL USE EXTREME CARE AND PROTECTIVE MEASURES TO OR AGENCY FACILITIES WITHIN THE LIMITS OF WORK, WHETHER THEY ARE SHOWN ON THIS PLAN OR NOT.

5. THE CONTRACTOR SHALL NOTIFY THE CITY, COUNTY OR STATE ENGINEER INSPECTION DEPARTMENT, AT LEAST TWO DAYS BEFORE START OF ANY WORK REQUIRING THEIR INVOLVEMENT.

6. THE CITY, COUNTY OR STATE SHALL SPECIFY THE EXPIRATION PERIOD OF THE PERMIT FOR THIS CONSTRUCTION PROJECT.

7. THE MINIMUM COVER FOR ALL CONDUITS PLACED UNDERGROUND SHALL BE 36 INCHES TO THE FINISHED GRADE AT ALL TIMES.

8. THE CONTRACTOR SHALL TUNNEL ALL CURB AND GUTTERS AND BORE ALL CONCRETE DRIVEWAYS AND WALKWAYS AT THE DIRECTION OF THE CITY, COUNTY OR STATE ENGINEER.

ALL A.C AND/OR CONCRETE PAVEMENT SHALL BE REPLACED AT THE DIRECTION OF THE CITY, COUNTY OR STATE ENGINEERS.

WORK, SHALL BE REPLANTED AND/OR REPLACED SO AS TO RESTORE THE WORK SITE TO ITS ORIGINAL CONDITION

11. THE CONTRACTOR WILL BE RESPONSIBLE FOR THE PROCESSING OF ALL APPLICANT PERMIT FORMS ALONG WITH THE REQUIRED LIABILITY INSURANCE FORMS. CLEARLY DEMONSTRATING THAT EXTENET, THE CITY, COUNTY OR STATE IS ALSO INSURED WITH THE REQUIRED LIABILITY INSURANCE IN THE AMOUNT OF \$1,000,000.00 FOR THIS

12. VAULTS, PEDESTALS, CONDUITS AND OTHER TYPES OF SUBSTRUCTURE ARE EITHER SPECIFIED ON THIS PLAN OR WILL BE SPECIFIED BY THE CONSTRUCTION ENGINEER. ANY AND ALL DEVIATIONS FROM THE SPECIFIED TYPES OF MATERIAL MUST BE APPROVED BY THE SYSTEM ENGINEER, IN WRITING BEFORE INSTALLATION THEREOF.

13. THE CONTRACTOR SHALL VERIFY THE LOCATION OF ALL EXISTING UTILITIES IN INCLUDING SEWER LATERALS & WATER SERVICES TO INDIVIDUAL LOTS BOTH VERTICAL AND HORIZONTAL PRIOR TO COMMENCING IMPROVEMENT

14. CONTRACTOR SHALL MAKE EXPLORATION EXCAVATIONS AND LOCATE EXISTING FACILITIES SUFFICIENTLY AHEAD OF CONSTRUCTION TO PERMIT REVISIONS TO PLANS IF REVISION IS NECESSARY BECAUSE OF LOCATION OF

15. THE LOCATIONS OF ALL EXISTING UTILITIES SHOWN ON THESE PLANS ARE FROM EXISTING RECORDS AND CORROBORATED, WHERE POSSIBLE, WITH FIELD TIES. THE CONTRACTOR IS RESPONSIBLE FOR CONFIRMINT LOCATIONS SHOWN, BOTH HORIZONIAL AND VERTICALLY. PRIOR TO CONSTRUCTION, IF EXISTING LOCATIONS WAR SUBSTANTIALLY FROM THE PLANS. THE ENGINEER SHOULD BE NOTIFIED TO MAKE ANY CONSTRUCTION CHANGES

EROSION AND SEDIMENT CONTROL NOTES

TEMPORARY EROSION/SEDIMENT CONTROL PRIOR TO COMPLETION OF FINAL IMPROVEMENTS, SHALL BE PERFORMED BY THE CONTRACTOR OR QUALIFIED PERSON AS INDICATED BELOW:

1. ALL REQUIREMENTS OF THE CITY, COUNTY AND STATE "STORM WATER STANDARDS" MUST BE INCORPORATED INTO THE DESIGN AND CONSTRUCTION OF THE PROPOSED GRADING/IMPROVMENTS CONSISTENT WITH THE APPROVED STORM WATER POLLUTION PREVENTION PLAN (SWPPP), WATER QUALITY TECHNICAL REPORT (WQTR), AND/OR WATER POLLUTION CONTROL PLAN (WPCP).

2. FOR STORM DRAIN INLETS, PROVIDE A GRAVEL BAG SILT BASIN IMMEDIATELY UPSTREAM OF INLET AS INDICATED ON DETAILS.

3. FOR INLETS LOCATED AT SUMPS ADJACENT TO TOP OF SLOPES. THE CONTRACTOR SHALL ENSURE THAT WATER DRAINING TO THE SUMP IS DIRECTED INTO THE INLET AND THAT A MINIMUM OF 1.00° FREEBOARD EXISTS AND IS MAINTAINED ABOVE THE TOP OF THE INLET. IF FREEBOARD IS NOT PROVIDED BY GRADING SHOWN ON

4. THE CONTRACTOR OR QUALIFIED PERSON SHALL BE RESPONSIBLE FOR CLEANUP OF SILT AND MUD ON ADJACENT STREET(S) AND STORM DRAIN SYSTEM DUE TO CONSTRUCTION ACTIVITY.

5. THE CONTRACTOR OR QUALIFIED PERSON SHALL CHECK AND MAINTAIN ALL LINED AND UNLINED DITCHES AFTER EACH RAINFALL.

6. THE CONTRACTOR SHALL REMOVE SILT AND DEBRIS AFTER EACH MAJOR RAINFALL

B. THE CONTRACTOR SHALL RESTORE ALL EROSION/SEDIMENT CONTROL DEVICES TO WORKING ORDER TO THE SATISFACTION OF THE CITY ENGINEER OF RESIDENT ENGINEER AFTER EACH RUN-OFF PRODUCING RAINFALL.

9. THE CONTRACTOR SHALL INSTALL ADDITIONAL EROSION/SEDIMENT CONTROL MEASURES AS MAY BE REQUIRED BY THE RESIDENT ENGINEER DUE TO UNCOMPLETED GRADING OPERATIONS OR UNFORESEEN CIRCUMSTANCES,

10. THE CONTRACTOR SHALL BE RESPONSIBLE AND SHALL TAKE NECESSARY PRECAUTIONS TO PREVENT PUBLIC TRESPASS ONTO AREAS WHERE IMPOUNDED WATERS CREATE A HAZARDOUS CONDITION.

11. ALL EROSION/SEDIMENT CONTROL MEASURES PROVIDED PER THE APPROVED GRADING PLAN SHALL BE INCORPORATED HERON. ALL EROSION/SEDIMENT CONTROL FOR INTERIM CONDITIONS SHALL BE DONE TO THE SATISFACTION OF THE RESIDENT BEGINEER.

12. GRADED AREAS AROUND THE PROJECT PERIMETER MUST DRAIN AWAY FROM THE FACE OF THE SLOPE AT THE CONCLUSION OF EACH WORKING DAY.


13. ALL REMOVABLE PROTECTIVE DEVICES SHOWN SHALL BE IN PLACE AT THE END OF EACH WORKING DAY WHEN RAIN IS IMMINENT.

14. THE CONTRACTOR SHALL ONLY GRADE, INCLUDING CLEARING AND GRUBBING FOR THE AREAS FOR WHICH THE CONTRACTOR OR QUALIFIED PERSON CAN PROVIDE EROSION/SEDIMENT CONTROL MEASURES.

15. THE CONTRACTOR SHALL ARRANGE FOR WEEKLY MEETINGS DURING OCTOBER 1ST TO APRIL 30TH FOR PROJECT TEAM (GENERAL CONTRACTOR, QUALIFIED PERSON, EROSION CONTROL SUBCONTRACTOR IF AN, ENGINEER OF WORK, OWNER/DEVELOPER AND THE RESIDENT ENGINEER) TO EVALUATE THE ADEQUACY OF THE EROSION/SEDIMENT CONTROL MEASURE AND OTHER RELATED CONSTRUCTION ACTIVITIES.

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2

GENERAL NOTES

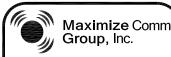1. 120/240 POWER REQUIRED FOR 3-WIRE SERVICE.
2. GC TO REMOVE/CLEAN ALL DEBRIS, NAILS, STAPLES, OR NON-USED VERTICALS OFF THE POLE.
3. ALL CONSTRUCTION SHALL BE IN ACCORDANCE WITH MUNICIPAL, COUNTY, STATE, FEDERAL, GO95 AND G0128 STANDARDS AND REQUILATIONS.
4. CALL USA 48 HOURS PRIOR TO EXCAVATING AT (800) 422-4133.
5. ALL LANDSCAPING TO BE RESTORED TO ORIGINAL CONDITION OR BETTER.
6. ALL EQUIPMENT TO BE BONDED.

Call Before you Dlg! 1-800-227-2600

7. METERING CABINET REQUIRES 3'[.914M] CLEARANCE AT DOOR OPENING. 8. CAULK CABINET BASE AT PAD.

STANDARD GROUNDING NOTES:

5/8"x8"[.016x2.44M] ROD, CAD WELD BELOW GRADE

#6 GROUND AND BOND WIRE . WOOD MOLDING, STAPLED EVERY 3'[.914M] AND AT EACH END . GROUNDS 3'[.914M] FROM POLE.

6. PLACE 3 #10GA WIRES FROM BREAKER TO METER BOX.

STANDARD CONDUIT NOTES:

1. FOR UNDERGROUND USE SCHEDULE 40.
2. FOR RISERS USE SCHEDULE 80.
3. PLACE 2"[.051M] GALVANIZED STEEL CONDUIT FOR ANY CONDUIT UNDER 3"[.076M], STUB UP 10"[3.04M] THEN CONVERT TO SCHEDULE 80.
4. CONVERT 4"[.102M] CARRIER CONDUIT TO 3"[.076M] AT BASE OF POLE.
5. GC TO STUB UP POLE 10"[3.04M] w/3" POWER CONDUIT, POWER CO. TO CONVERT TROM 3"[.076M] SCH. 80 TO 2"[.051M] SCH. 80 FROM TOP OF STUB UP.

ALL CONDUIT WILL BE MAN DRILLED AND EQUIPPED WITH 3/8"[.010M] PULL ROPE.

MAINTAIN 40"[1.02M] MINIMUM COVER FOR ELECTRICAL CONDUIT.
 MAINTAIN 30"[7.62M] MINIMUM COVER FOR COMMUNICATIONS CONDUIT.
 SAND SHADING MINIMUM 1"[0.025M] UNDER CONDUITS, AND 6"[1.152M] COVERING ON TOP REQUIRED.
 ALL ELECTRICAL SERVICE CONDUITS FROM POWER COMPANY, WHETHER FROM POLES, TRANSFORMERS, OR OTHER LOCATIONS; WILL BE SLURRY BACKELIES.

5. IN STREET SLURRY TO GRADE AND MILL DOWN 1-1/2"[.038M] FOR AC CAP. 6. IN DIRT SLURRY 18"[.457M] FROM GRADE, AND FILL WITH 95% COMPACTION NATIVE SOIL FOR BALANCE.

PLACE WARNING TAPE IN TRENCH 12"[.305M] ABOVE ALL CONDUITS AND #18 WARNING TAPE ABOVE GROUND RING.

. NO BOLT THREADS TO PROTRUDE MORE THAN 1-1/2"[.038M]. . FILL ALL HOLES LEFT IN POLE FROM REARRANGEMENT OF CLIMBERS.

ALL CLIMB STEPS NEXT TO CONDUIT SHALL HAVE EXTENDED STEPS.

4. CABLE NOT TO IMPEDE 15"[.381M] CLEAR SPACE OFF POLE FACE

4. CABLE NOT TO IMPEDE 151_ASTIM] CLEAR SPACE OFF POLE FACE (12:00).
5. 90' SHORT SWEEPS UNDER ANTENNA ARM. ALL CABLES MUST ONLY TRANSITION ON THE INSIDE OR BOTTOM OF ARMS (NO CABLE ON TOP OF ARMS).
6. USE CABLE CLAMPS TO SECURE CABLE TO ARMS; PLACE 2"[0.51 M] CARRIER CABLE ID TAGS ON BOTH SIDES OF ARMS.
7. USE 90' CONNECTOR AT CABLE CONNECTION TO ANTENNAS.
8. PLACE GPS ON ARM WITH SOUTHERN SYLEXPOSURE AT MINIMUM.

S'[1.83M] FROM TRANSMIT ANTENNA, WHICH IS 24"[.61M] AWAY FROM CENTER OF POLE. 9. USE 1/2"[.013M] CABLE ON ANTENNAS UNLESS OTHERWISE

10. FILL VOID AROUND CABLES AT CONDUIT OPENING WITH FOAM SEALANT TO PREVENT WATER INTRUSION.

TOTAL	77.48 SQ. FT.		
TOP GRADE	27'-3"		
BOTTOM GRADE	22'-11"		
METER/BREAKER AREA TOTAL	4.33 SQ. FT.		
TOP GRADE	8'-0"		
BOTTOM GRADE	7'-0"		
BATTERY BACK-UP AREA TOTAL	16.25 SQ. FT.		
TOP GRADE	11'-8"		
BOTTOM GRADE	9'-6"		
DELTA DECK AREA TOTAL	10.74 SQ. FT.		
TOP GRADE	14'-7"		
BOTTOM GRADE	12'-5"		
DELTA DECK (FUT.) AREA TOTAL	10.74 SQ. FT.		
TOP GRADE	17'-6"		
BOTTOM GRADE	15'-4"		
EXT. RISER SIZE	4"-ø		
EXT. RISER LENGTH	28'-1"		
EXT. RISER BTM GRADE	14'-5"		
PWR RISER SIZE	1"-ø		
PWR RISER LENGTH	15'-8"		
PWR RISER BTM GRADE	8'-2"		

WIND LOADING INFORMATION

			2011011	010150	
ANTENNA SECTOR	AZIMUTH	ANTENNA MAKE / MODEL	COAXIAL CABLE LENGTH	CABLES PER SECTOR	CABLE SIZE
SECTOR ALPHA	324	KATHREIN 840 21410	42'-5"	2	1/2"
SECTOR BETA	131*	KATHREIN 840 21410	42'-5"	2	1/2"
SECTOR GAMMA					

INCILE; CONTRACTOR TO FIELD VERIFY CABLE LENGTHS PRIOR TO ORDERING, FABRICATION, OR INSTALLATION OF CABLES

HWY8435-012B

SITE NAME & ADDRESS:

HIGHWAY 84/35 NETWORK NODE OI 2B 30 MPH SIGN SKYLINE BLVD.

WOODSIDE, CA 94062

IENERAL NOTES & SCHEDULE

SHEET NUMBER EVISION: 3


ROW CONSTRUCTION GENERAL NOTES

LOADING AND ANTENNA CABLE SCHEDULES

TOP OF PLATE (PARAPET)
TOP OF STEEL (SLAB)
TOP OF WALL

TOP OF WALL
TYPICAL
UNDER GROUND
UNDERWRITERS LABORATORY
UNLESS NOTED OTHERWISE
VERIFY IN FIELD
WIDE(WIDTH)
WITH

WOOD

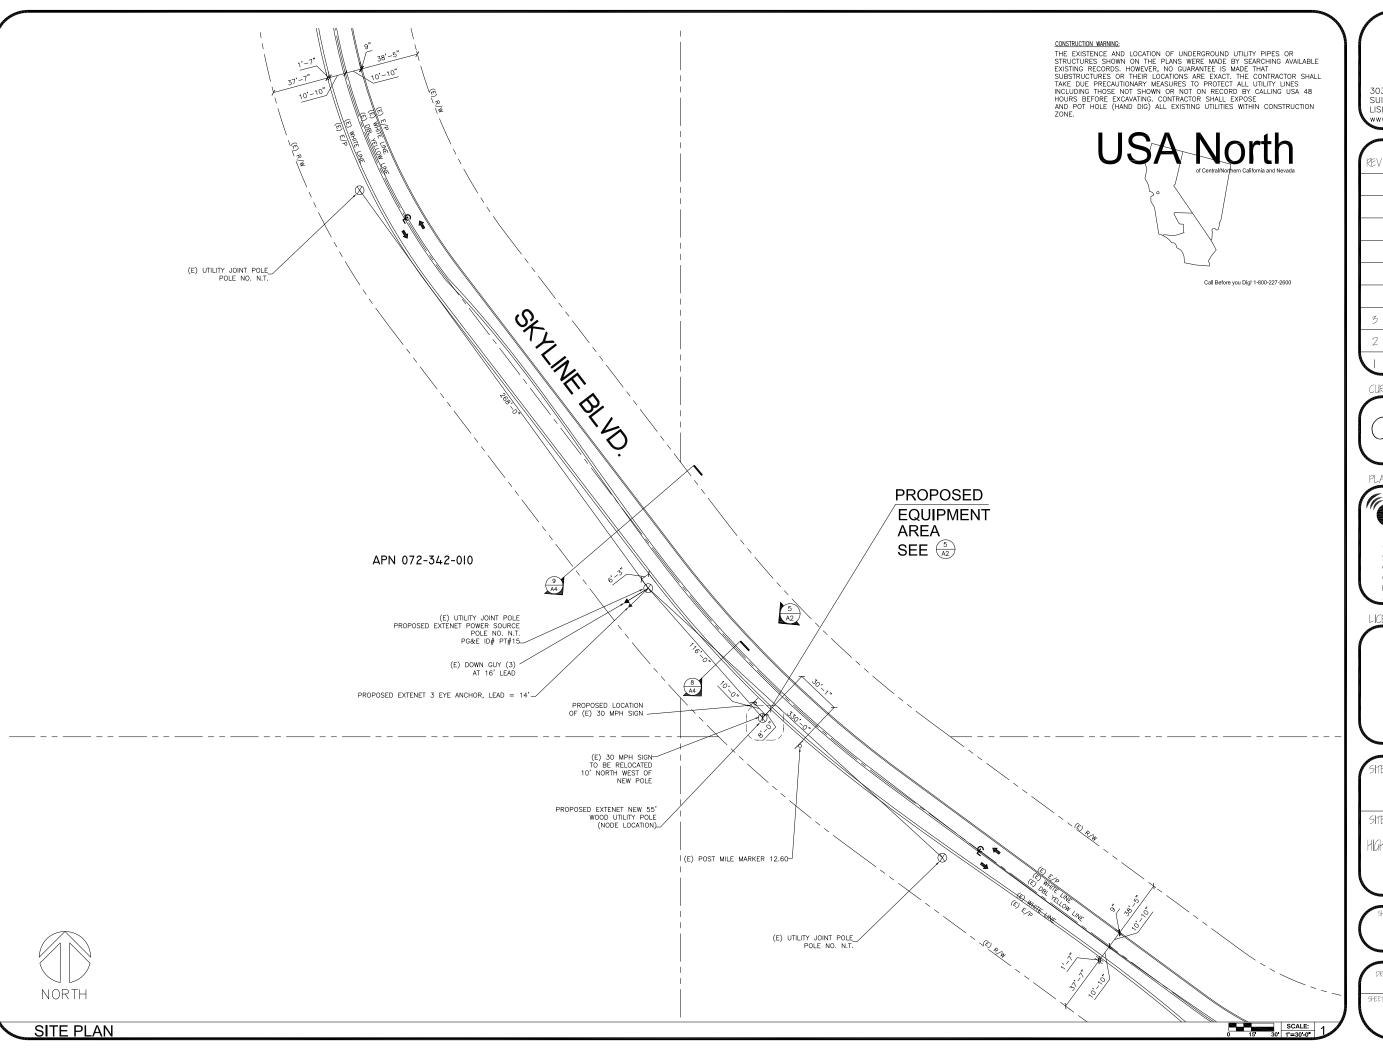




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CURRENT ISSUE DATE:

PLANS PREPARED BY:

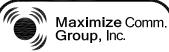

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HWY8435-012B

SITE NAME & ADDRESS:

HIGHWAY 84/35 NETWORK NODE OI2B

30 MPH SIGN SKYLINE BLVD. WOODSIDE, CA 94062

SITE PLAN

DRAWN BY: VG	CHECKED BY: AF	APPROVED BY:
SHEET NUMBER:	۸ ۸	REVISION:

EXTENET MAKE-READY

- INSTALL 55', CLASS 2, DOUGLAS FIR UTILITY POLE, PER SITE PLAN.
- 2. FLUSH MOUNT 4 PANEL ANTENNAS TOP AT 45'-2" GRADE. SECOND SET 1' BELOW PER ELEVATION.
- 3. STRING IN FIBER/POWER STRAND AND ATTACH AT 25'-0" GRADE W/ANCHOR GUY. PER FIBER DESIGN.
 4. INSTALL DELTA NODE RADIOS, BATTERY BACK-UP AND ELEC. ENCLOSURE AT 3:00 POSITION W/MIN. 4"
- SPACING FROM POLE. 5. INSTALL 4" PVC SCH. 40 COAX RISER AT 1:30

PROPOSED EXTENET FIBER ATTACHMENT 25'-0" A.G.L.

PROPOSED EXTENET EQUIPMENT
7'-0" A.G.L.

PROPOSED 55' POLE N.T.

6. INSTALL 2" PVC SCH. 40 FIBER/PWR RISER AT 1:00

POWER MAKE-READY

- STRING IN SECONDARY POWER FROM PG&E POLE APPROX. 116' NORTH WEST OF PROPOSED NODE POLE. (SEE SITE PLAN/POWER DESIGN)
 INSTALL TRANSFORMER AND SECONDARY POWER FOR
- SERVICE, PER PG&E DESIGN.
- 3. INSTALL 1" PVC SCH. 80 RISER W/WEATHER HEAD AT
- 1:00 (QUAD 1) POSITION.

 4. PROVIDE 120/240V, 3-WIRE, SINGLE PHASE 100 AMP SERVICE TO 1" PG&E RISER TO EXTENET METER BOX FROM SECONDARY POWER AT 47'-0" GRADE.

PROPOSED

EQUIPMENT

AREA

SEE (9)



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REV.	DATE	DESCRIPTION
3	02/08/10	REVISION PER CALTRANS COMMENTS
2	01/25/10	REVISION PER PG&E POWER DESIGN
	11/11/09	REVISION PER EXTENET REQUESTED

CURRENT ISSUE DATE:

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1351 POMONA ROAD SUITE 100 CORONA, CA 92882 OFFICE: (909) 786-2170 FAX: (909) 992-3113

PROPOSED EXTENET PANEL ANTENNA

_ FOC/EP


CLIMB SPACE

HWY8435-012B SITE NAME & ADDRESS: HIGHWAY 84/35 NETWORK NODE OI2B

30 MPH SIGN SKYLINE BLVD. WOODSIDE, CA 94062

ELEVATIONS & RISER DETAIL

SHEET NUMBER: EVISION: 3

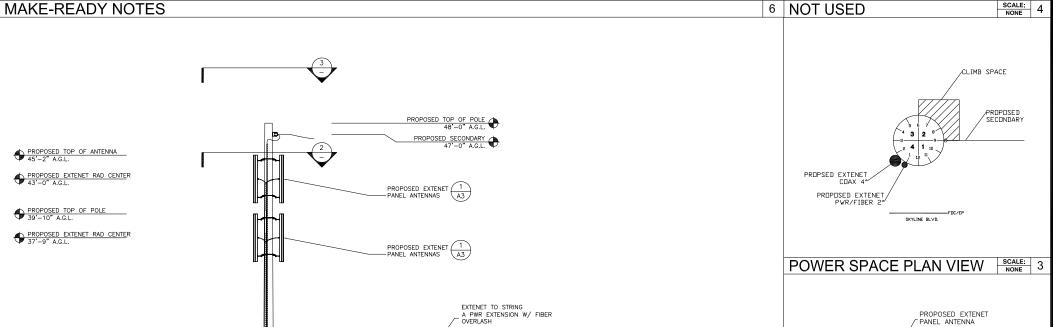

NORTH EAST POLE ELEVATION

SCALE: 5 EQUIPMENT RISER DETAIL

PROPSED EXTENET PROPOSED EXTENET PWR/FIBER 2*


PROPOSED EXTENET


PROPOSED EXTENSE NODE EQUIP

SKYLINE BLVD.

EXTENET ANTENNA PLAN VIEW


SKYLINE BLVD.

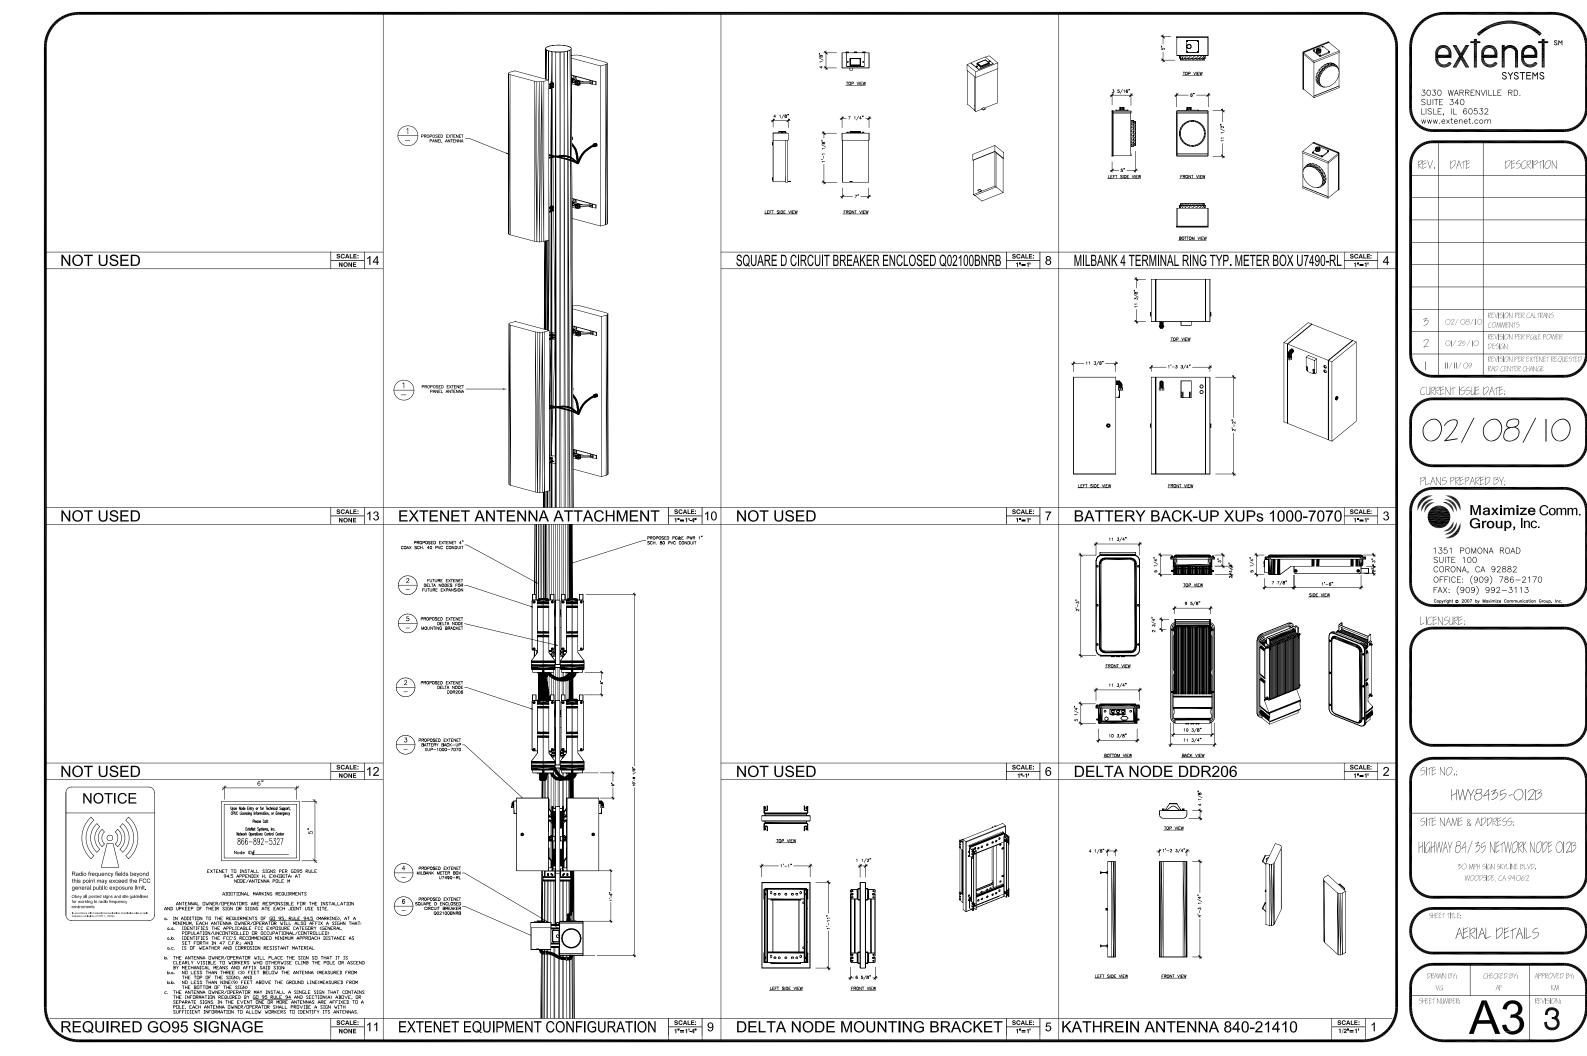

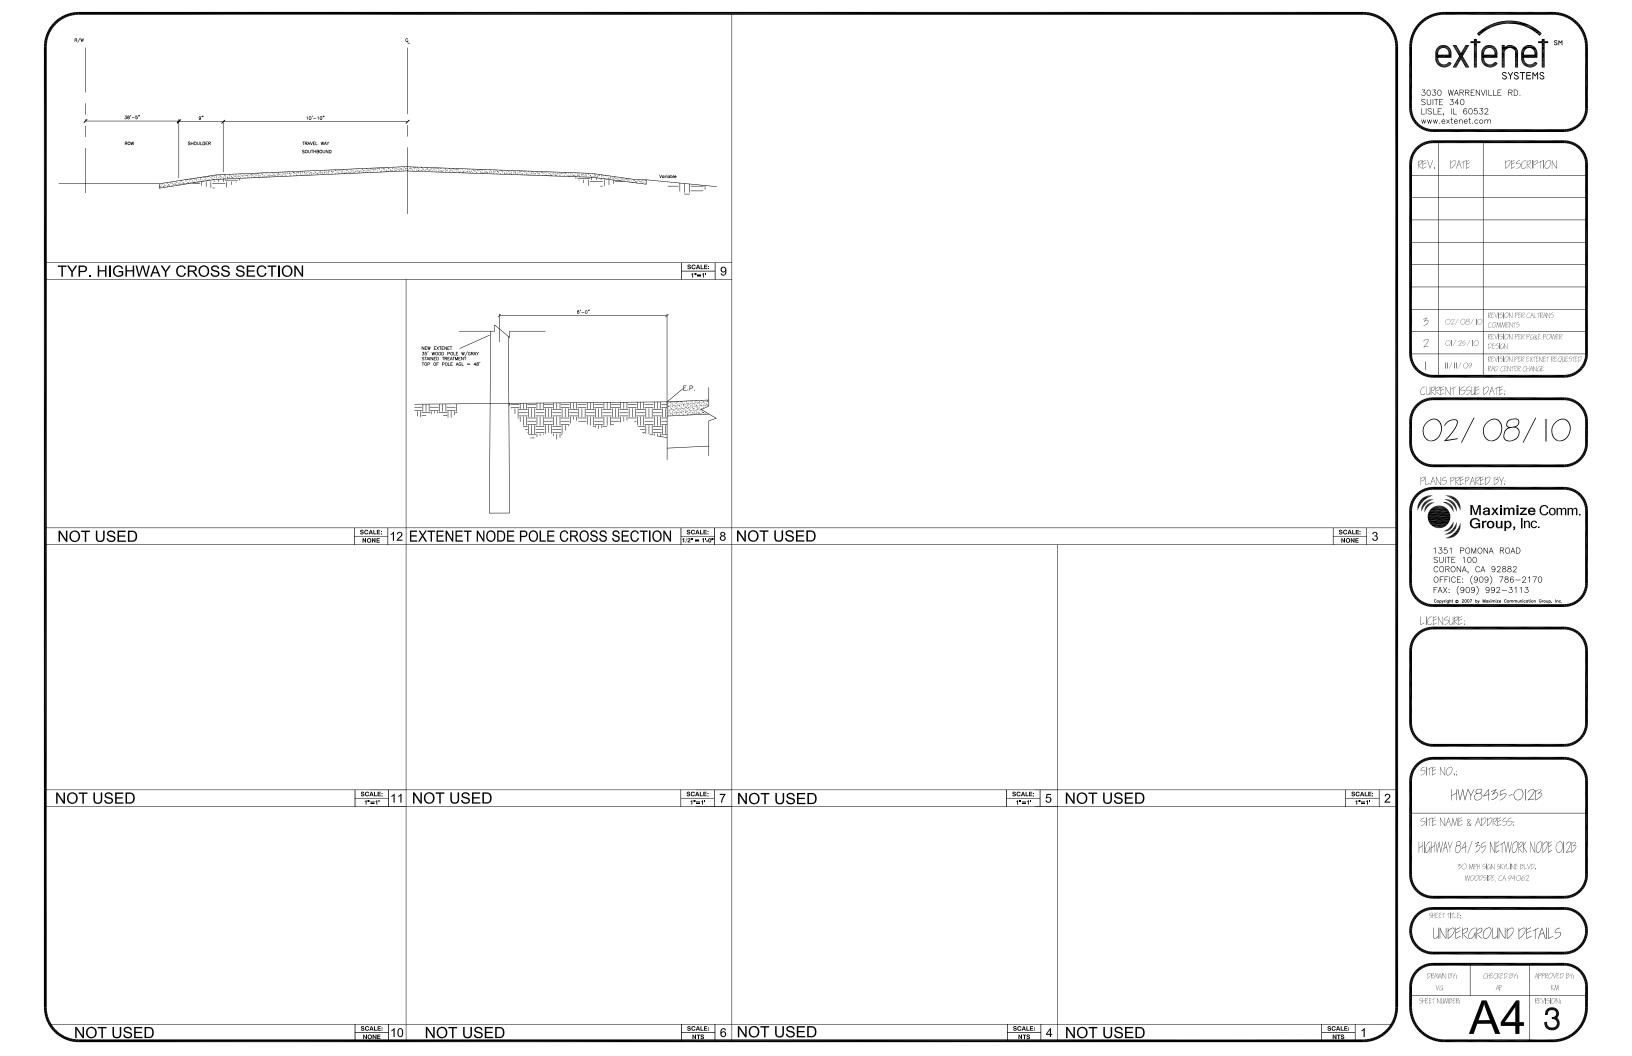



HWY 35 - PROJECT HWY8435 - 013B **POST MILE MARKER 12.24** 16301 SKYLINE BLVD. WOODSIDE, CA 94062

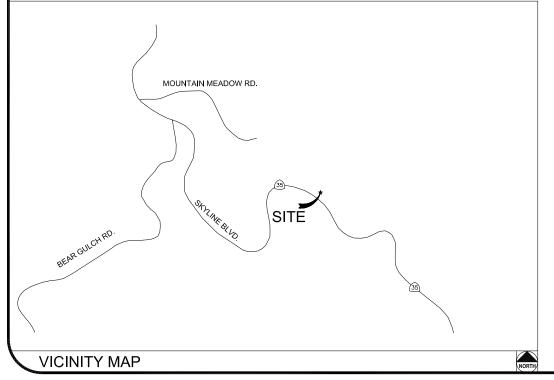

CLIENT

EXTENET SYSTEMS, INC. 3030 WARRENVILLE RD. SUITE 340 LISLE, IL 60532 CONTACT JEFF FRYE PHONE 480-626-1271 FAX 504-285-1603

EXTENET SYSTEMS, INC. 3030 WARRENVILLE RD. SUITE 340 LISLE, IL 60532 CONTACT JEFF FRYE PHONE 480-626-1271 FAX 504-285-1603

ENGINEERING FIRM/SURVEYING

MAXIMIZE COMMUNICATION GROUP, INC. MAXIMIZE COMMUNICATIO 1351 POMONA ROAD SUITE 100 CORONA, CA 92882 CONTACT KELLI McCABE PHONE 909-786-2170 FAX 909-992-3113

COORDINATES

CODE COMPLIANCE:

ALL WORK AND MATERIALS SHALL BE PERFORMED & INSTALLED IN ACCORDANCE WITH THE CURRENT EDITIONS OF THE FOLLOWING CODES AS ADOPTED BY LOCAL GOVERNING AUTHORITIES AND LOCAL/CITY/COUNTY ORDINANCES:

1. CALIFORNIA ADMINISTRATIVE CODE (INCLUDING TITLE 24 &

- 3. 2007 CALIFORNIA ELECTRICAL CODE.
- 3. BUILDING OFFICIALS AND CODE ADMINISTRATORS (BOCA).
- 4. UNIFORM PLUMBING & MECHANICAL CODES.
- 5. ANSI/EIA-222-F LIFE SAFETY CODE
- 6. CALIFORNIA GENERAL ORDER 95, 128 & 165.

	SHEET INDEX
SHEET	DESCRIPTION
T1	TITLE SHEET
T2	GENERAL CONSTRUCTION NOTE & ANTENNA CABLE SCHEDULE
A1	SITE PLAN
A2	UTILITY POLE ELEVATIONS/RISER DETAILS
A3	AERIAL DETAILS
A4	UNDERGROUND DETAILS
-	, same



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CURRENT ISSUE DATE:



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HWY8435-013B


SITE NAME & ADDRESS:

HIGHWAY 84/35 NETWORK NODE OI3E

WOODSIDE CA 94062

TITLE SHEET

KM EVISION: 3

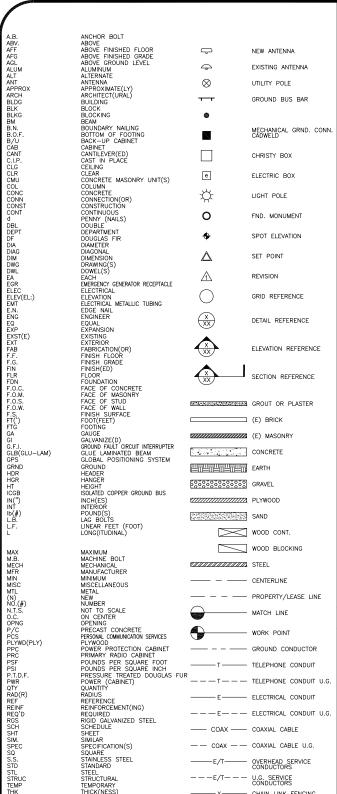

1. THE CONTRACTOR SHALL BE RESPONSIBLE FOR SURVEY MONUMENTS AND/OR VERTICAL CONTROL BENCHMARKS WHICH ARE DISTURBED OR DESTROYED BY CONSTRUCTION. A LAND SURVEYOR MUST FIELD LOCATE, REFERENCE, AND/OR PRESERVE ALL HISTORICAL OR CONTROLLING MONUMENTS PRIOR TO ANY EARTHMORK. IF DESTROYED, SUCH MONUMENTS SHALL BE REPLACED WITH APPROPRIATE MONUMENTS BY A LAND SURVEYOR. A CORNER RECORD OR RECORD OF SURVEY, AS APPROPRIATE, SHALL BE FILED AS REQUIRED BY THE PROPRESSIONAL LAIDS SURVEYOR.

NUMBER BE ISSUED BEFORE A "PERMT TO EXCAVATE" WILL BE VALID. FOR YOUR DIG ALERT I.D. NUMBER, CALL UNDERGROUND SERVICE ALERT, TOLL FREE 1-800-422-4133, TWO DAYS BEFORE YOU DIG.

CROSS THE PROPOSED TRENCH LINE AND MUST MAINTAIN A 1' MINIMUM VERTICAL CLEARANCE.

4. IF ANY EXISTING HARDSCAPE OR LANDSCAPE INDICATED ON THE APPROVE PLANS IS DAMAGED OR REMOVED DURING DEMOLITION OR CONSTRUCTION, IT SHALL BE REPAIRED AND/OR REPLACED IN KIND PER THE APPROVED PLANS.

5. CONTRACTOR SHALL REPLACE OR REPAIR ALL TRAFFIC SIGNAL LOOPS, CONDUIT, AND LANE STRIPING DAMAGED DURING CONSTRUCTION.

6. THIS PROJECT WILL BE INSPECTED BY ENGINEERING AND FIELD ENGINEERING DIVISION

7. MANHOLES OR COVERS SHALL BE LABELED EXTENET

8. CONTRACTOR SHALL IMPLEMENT AN EROSION CONTROL PROGRAM DURING THE PROJECT CONSTRUCTION ACTIVITIES. THE PROGRAM SHALL MEET THE APPLICABLE REQUIREMENTS OF THE STATE WATER RESOURCE CONTROL

9. THE CONTRACTOR SHALL HAVE EMERGENCY MATERIALS AND EQUIPMENT ON HAND FOR UNFORESEEN SITUATIONS, SUCH AS DAMAGE TO UNDERGROUND WATER, SEWER, AND STORM DRAIN FACILITIES WHEREBY FLOWS MAY GENERATE EROSION AND SEDIMENT POLLUTION.

USA North

Call Before you Dlg! 1-800-227-2600

1. INDEMNIFICATION CLAUSE: THE CONTRACTOR AGREES AND SHALL:
ASSUME SOLE AND COMPLETE RESPONSIBILITY OF THE JOB SITE CONDITIONS DURING THE COURSE OF
CONSTRUCTION OF THIS PROJECT, INCLUDING THE SAFETY OF ALL PERSONS AND PROPERTIES. THAT THESE
REQUIREMENTS SHALL APPLY CONTINUOUSLY AND NOT BE LIMITED TO NORMAL WORKING HOURS AND CONDITIONS. ENGINEERS HARMLESS FROM ANY AND ALL LIABILITY, REAL OR ALLEGED IN CONNECTION WITH THE PERFORMANCE

2. PRIOR TO THE BEGINNING OF ANY CONSTRUCTION AND THROUGHOUT THE COURSE OF CONSTRUCTION WORK. THE CONTRACTOR SHALL FULLY COMPLY WITH "CALIFORNIA OCCUPATIONAL SAFETY AND HEALTH" ACT OF 1973 INCLUDING ALL REVISIONS AND AMENDMENTS THERETO.

3. ALL WORK SHALL CONFORM TO THE LATEST EDITIONS OF G095,128 AND THE STANDARD "SPECIFICATIONS FOR PUBLIC WORKS CONSTRUCTION" AS ADOPTED BY THE CITY, COUNTY OR STATE AS MODIFIED BY STANDARD PLANS

4. THE EXISTENCE AND LOCATION OF UTILITIES AND OTHER AGENCY'S FACILITIES AS SHOWN HERON ARE OBJUSTED BY A SEARCH OF AVAILABLE RECORDS. OTHER FACILITIES MAY EXIST. THE CONTRACTOR SHALL VERIFY PRIOR TO THE START OF CONSTRUCTION AND SHALL USE EXTREME CARE AND PROTECTIVE MEASURES TO OR AGENCY FACILITIES WITHIN THE LIMITS OF WORK, WHETHER THEY ARE SHOWN ON THIS PLAN OR NOT.

5. THE CONTRACTOR SHALL NOTIFY THE CITY, COUNTY OR STATE ENGINEER INSPECTION DEPARTMENT, AT LEAST TWO DAYS BEFORE START OF ANY WORK REQUIRING THEIR INVOLVEMENT.

6. THE CITY, COUNTY OR STATE SHALL SPECIFY THE EXPIRATION PERIOD OF THE PERMIT FOR THIS CONSTRUCTION PROJECT.

7. THE MINIMUM COVER FOR ALL CONDUITS PLACED UNDERGROUND SHALL BE 36 INCHES TO THE FINISHED GRADE AT ALL TIMES.

8. THE CONTRACTOR SHALL TUNNEL ALL CURB AND GUTTERS AND BORE ALL CONCRETE DRIVEWAYS AND WALKWAYS AT THE DIRECTION OF THE CITY, COUNTY OR STATE ENGINEER.

ALL A.C AND/OR CONCRETE PAVEMENT SHALL BE REPLACED AT THE DIRECTION OF THE CITY, COUNTY OR STATE ENGINEERS.

WORK, SHALL BE REPLANTED AND/OR REPLACED SO AS TO RESTORE THE WORK SITE TO ITS ORIGINAL CONDITION

11. THE CONTRACTOR WILL BE RESPONSIBLE FOR THE PROCESSING OF ALL APPLICANT PERMIT FORMS ALONG WITH THE REQUIRED LIABILITY INSURANCE FORMS. CLEARLY DEMONSTRATING THAT EXTENET, THE CITY, COUNTY OR STATE IS ALSO INSURED WITH THE REQUIRED LIABILITY INSURANCE IN THE AMOUNT OF \$1,000,000.00 FOR THIS

12. VAULTS, PEDESTALS, CONDUITS AND OTHER TYPES OF SUBSTRUCTURE ARE EITHER SPECIFIED ON THIS PLAN OR WILL BE SPECIFIED BY THE CONSTRUCTION ENGINEER. ANY AND ALL DEVIATIONS FROM THE SPECIFIED TYPES OF MATERIAL MUST BE APPROVED BY THE SYSTEM ENGINEER, IN WRITING BEFORE INSTALLATION THEREOF.

13. THE CONTRACTOR SHALL VERIFY THE LOCATION OF ALL EXISTING UTILITIES IN INCLUDING SEWER LATERALS & WATER SERVICES TO INDIVIDUAL LOTS BOTH VERTICAL AND HORIZONTAL PRIOR TO COMMENCING IMPROVEMENT

14. CONTRACTOR SHALL MAKE EXPLORATION EXCAVATIONS AND LOCATE EXISTING FACILITIES SUFFICIENTLY AHEAD OF CONSTRUCTION TO PERMIT REVISIONS TO PLANS IF REVISION IS NECESSARY BECAUSE OF LOCATION OF

15. THE LOCATIONS OF ALL EXISTING UTILITIES SHOWN ON THESE PLANS ARE FROM EXISTING RECORDS AND CORROBORATED, WHERE POSSIBLE, WITH FIELD TIES. THE CONTRACTOR IS RESPONSIBLE FOR CONFIRMINT LOCATIONS SHOWN, BOTH HORIZONIAL AND VERTICALLY. PRIOR TO CONSTRUCTION, IF EXISTING LOCATIONS WAR SUBSTANTIALLY FROM THE PLANS. THE ENGINEER SHOULD BE NOTIFIED TO MAKE ANY CONSTRUCTION CHANGES

EROSION AND SEDIMENT CONTROL NOTES

TEMPORARY EROSION/SEDIMENT CONTROL PRIOR TO COMPLETION OF FINAL IMPROVEMENTS, SHALL BE PERFORMED BY THE CONTRACTOR OR QUALIFIED PERSON AS INDICATED BELOW:

1. ALL REQUIREMENTS OF THE CITY, COUNTY AND STATE "STORM WATER STANDARDS" MUST BE INCORPORATED INTO THE DESIGN AND CONSTRUCTION OF THE PROPOSED GRADING/IMPROVMENTS CONSISTENT WITH THE APPROVED STORM WATER POLLUTION PREVENTION PLAN (SWPPP), WATER QUALITY TECHNICAL REPORT (WQTR), AND/OR WATER POLLUTION CONTROL PLAN (WPCP).

2. FOR STORM DRAIN INLETS, PROVIDE A GRAVEL BAG SILT BASIN IMMEDIATELY UPSTREAM OF INLET AS INDICATED ON DETAILS.

3. FOR INLETS LOCATED AT SUMPS ADJACENT TO TOP OF SLOPES. THE CONTRACTOR SHALL ENSURE THAT WATER DRAINING TO THE SUMP IS DIRECTED INTO THE INLET AND THAT A MINIMUM OF 1.00° FREEBOARD EXISTS AND IS MAINTAINED ABOVE THE TOP OF THE INLET. IF FREEBOARD IS NOT PROVIDED BY GRADING SHOWN ON

4. THE CONTRACTOR OR QUALIFIED PERSON SHALL BE RESPONSIBLE FOR CLEANUP OF SILT AND MUD ON ADJACENT STREET(S) AND STORM DRAIN SYSTEM DUE TO CONSTRUCTION ACTIVITY.

5. THE CONTRACTOR OR QUALIFIED PERSON SHALL CHECK AND MAINTAIN ALL LINED AND UNLINED DITCHES AFTER EACH RAINFALL.

6. THE CONTRACTOR SHALL REMOVE SILT AND DEBRIS AFTER EACH MAJOR RAINFALL

B. THE CONTRACTOR SHALL RESTORE ALL EROSION/SEDIMENT CONTROL DEVICES TO WORKING ORDER TO THE SATISFACTION OF THE CITY ENGINEER OF RESIDENT ENGINEER AFTER EACH RUN-OFF PRODUCING RAINFALL.

). THE CONTRACTOR SHALL INSTALL ADDITIONAL EROSION/SEDIMENT CONTROL MEASURES AS MAY BE REQUIRED BY THE RESIDENT ENGINEER DUE TO UNCOMPLETED GRADING OPERATIONS OR UNFORESEEN CIRCUMSTANCES,

10. THE CONTRACTOR SHALL BE RESPONSIBLE AND SHALL TAKE NECESSARY PRECAUTIONS TO PREVENT PUBLIC TRESPASS ONTO AREAS WHERE IMPOUNDED WATERS CREATE A HAZARDOUS CONDITION.

11. ALL EROSION/SEDIMENT CONTROL MEASURES PROVIDED PER THE APPROVED GRADING PLAN SHALL BE INCORPORATED HERON. ALL EROSION/SEDIMENT CONTROL FOR INTERIM CONDITIONS SHALL BE DONE TO THE SATISFACTION OF THE RESIDENT ENGINEER.

12. GRADED AREAS AROUND THE PROJECT PERIMETER MUST DRAIN AWAY FROM THE FACE OF THE SLOPE AT THE CONCLUSION OF EACH WORKING DAY.

13. ALL REMOVABLE PROTECTIVE DEVICES SHOWN SHALL BE IN PLACE AT THE END OF EACH WORKING DAY WHEN RAIN IS IMMINENT.

14. THE CONTRACTOR SHALL ONLY GRADE, INCLUDING CLEARING AND GRUBBING FOR THE AREAS FOR WHICH THE CONTRACTOR OR QUALIFIED PERSON CAN PROVIDE EROSION/SEDIMENT CONTROL MEASURES.

15. THE CONTRACTOR SHALL ARRANGE FOR WEEKLY MEETINGS DURING OCTOBER 1ST TO APRIL 30TH FOR PROJECT TEAM (GENERAL CONTRACTOR, QUALIFIED PERSON, EROSION CONTROL SUBCONTRACTOR IF AN, ENGINEER OF WORK, OWNER/DEVELOPER AND THE RESIDENT ENGINEER) TO EVALUATE THE ADEQUACY OF THE EROSION/SEDIMENT CONTROL MEASURE AND OTHER RELATED CONSTRUCTION ACTIVITIES.

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2

GENERAL NOTES

1. 120/240 POWER REQUIRED FOR 3-WIRE SERVICE.
2. GC TO REMOVE/CLEAN ALL DEBRIS, NAILS, STAPLES, OR NON-USED VERTICALS OFF THE POLE.
3. ALL CONSTRUCTION SHALL BE IN ACCORDANCE WITH MUNICIPAL, COUNTY, STATE, FEDERAL, GO95 AND G0128 STANDARDS AND REQUILATIONS.
4. CALL USA 48 HOURS PRIOR TO EXCAVATING AT (800) 422-4133.
5. ALL LANDSCAPING TO BE RESTORED TO ORIGINAL CONDITION OR BETTER.
6. ALL EQUIPMENT TO BE BONDED.

7. METERING CABINET REQUIRES 3'[.914M] CLEARANCE AT DOOR OPENING. 8. CAULK CABINET BASE AT PAD.

STANDARD GROUNDING NOTES:

5/8"x8"[.016x2.44M] ROD, CAD WELD BELOW GRADE

#6 GROUND AND BOND WIRE

. WOOD MOLDING, STAPLED EVERY 3'[.914M] AND AT EACH END . GROUNDS 3'[.914M] FROM POLE.

6. PLACE 3 #10GA WIRES FROM BREAKER TO METER BOX.

STANDARD CONDUIT NOTES:

1. FOR UNDERGROUND USE SCHEDULE 40.
2. FOR RISERS USE SCHEDULE 80.
3. PLACE 2"[.051M] GALVANIZED STEEL CONDUIT FOR ANY CONDUIT UNDER 3"[.076M], STUB UP 10"[3.04M] THEN CONVERT TO SCHEDULE 80.
4. CONVERT 4"[.102M] CARRIER CONDUIT TO 3"[.076M] AT BASE OF POLE.
5. GC TO STUB UP POLE 10"[3.04M] w/3" POWER CONDUIT, POWER CO. TO CONVERT TROM 3"[.076M] SCH. 80 TO 2"[.051M] SCH. 80 FROM TOP OF STUB UP.

ALL CONDUIT WILL BE MAN DRILLED AND EQUIPPED WITH 3/8"[.010M] PULL ROPE.

MAINTAIN 40"[1.02M] MINIMUM COVER FOR ELECTRICAL CONDUIT.
 MAINTAIN 30"[7.62M] MINIMUM COVER FOR COMMUNICATIONS CONDUIT.
 SAND SHADING MINIMUM 1"[0.025M] UNDER CONDUITS, AND 6"[1.152M] COVERING ON TOP REQUIRED.
 ALL ELECTRICAL SERVICE CONDUITS FROM POWER COMPANY, WHETHER FROM POLES, TRANSFORMERS, OR OTHER LOCATIONS; WILL BE SLURRY BACKELIES.

5. IN STREET SLURRY TO GRADE AND MILL DOWN 1-1/2"[.038M] FOR AC CAP. 6. IN DIRT SLURRY 18"[.457M] FROM GRADE, AND FILL WITH 95% COMPACTION NATIVE SOIL FOR BALANCE. PLACE WARNING TAPE IN TRENCH 12"[.305M] ABOVE ALL CONDUITS AND #18 WARNING TAPE ABOVE GROUND RING.

. NO BOLT THREADS TO PROTRUDE MORE THAN 1-1/2"[.038M]. . FILL ALL HOLES LEFT IN POLE FROM REARRANGEMENT OF CLIMBERS.

ALL CLIMB STEPS NEXT TO CONDUIT SHALL HAVE EXTENDED STEPS.

4. CABLE NOT TO IMPEDE 15"[.381M] CLEAR SPACE OFF POLE FACE

4. CABLE NOT TO IMPEDE 151_ASTIM] CLEAR SPACE OFF POLE FACE (12:00).
5. 90' SHORT SWEEPS UNDER ANTENNA ARM. ALL CABLES MUST ONLY TRANSITION ON THE INSIDE OR BOTTOM OF ARMS (NO CABLE ON TOP OF ARMS).
6. USE CABLE CLAMPS TO SECURE CABLE TO ARMS; PLACE 2"[0.51 M] CARRIER CABLE ID TAGS ON BOTH SIDES OF ARMS.
7. USE 90' CONNECTOR AT CABLE CONNECTION TO ANTENNAS.
8. PLACE GPS ON ARM WITH SOUTHERN SYLEXPOSURE AT MINIMUM.

S'[1.83M] FROM TRANSMIT ANTENNA, WHICH IS 24"[.61M] AWAY FROM CENTER OF POLE.

9. USE 1/2"[.013M] CABLE ON ANTENNAS UNLESS OTHERWISE

10. FILL VOID AROUND CABLES AT CONDUIT OPENING WITH FOAM SEALANT TO PREVENT WATER INTRUSION.

ANTENNA/WOOD ARM AREA TOTAL	77.48 SQ. FT.	
TOP GRADE	24'-0"	
BOTTOM GRADE	19'-8"	
METER/BREAKER AREA TOTAL	4.33 SQ. FT.	
TOP GRADE	8'-0"	
BOTTOM GRADE	7'-0"	
BATTERY BACK-UP AREA TOTAL	16.25 SQ. FT.	
TOP GRADE	11'-8"	
BOTTOM GRADE	9'-6"	
DELTA DECK AREA TOTAL	10.74 SQ. FT.	
TOP GRADE	14'-7"	
BOTTOM GRADE	12'-5"	
DELTA DECK (FUT.) AREA TOTAL	10.74 SQ. FT.	
TOP GRADE	17'-6"	
BOTTOM GRADE	15'-4"	
EXT. RISER SIZE	4"−ø	
EXT. RISER LENGTH	28'-1"	
EXT. RISER BTM GRADE	14'-5"	
PWR RISER SIZE	1"-ø	
PWR RISER LENGTH	15'-0"	
PWR RISER BTM GRADE	8'-7"	

WIND LOADING INFORMATION

ANTENNA & CABLE SCHEDULE					
ANTENNA SECTOR			COAXIAL CABLE LENGTH	CABLES PER SECTOR	CABLE SIZE
SECTOR ALPHA	311*	KATHREIN 840 21410	41'-6"	2	1/2"
SECTOR BETA			41'-6"	2	1/2"
SECTOR GAMMA					
NOTE:			•	•	

NOTE:
CONTRACTOR TO FIELD VERIFY CABLE LENGTHS PRIOR TO ORDERING, FABRICATION, OR INSTALLATION OF CABLE:

HWY8435-013B

SITE NAME & ADDRESS:

HIGHWAY 84/35 NETWORK NODE OI3B

16301 SKYLINE BLVD WOODSIDE, CA 94062

IENERAL NOTES & SCHEDULE

SHEET NUMBER EVISION: 3


ROW CONSTRUCTION GENERAL NOTES

LOADING AND ANTENNA CABLE SCHEDULES

TOP OF PLATE (PARAPET)
TOP OF STEEL (SLAB)
TOP OF WALL

TOP OF WALL
TYPICAL
UNDER GROUND
UNDERWRITERS LABORATORY
UNLESS NOTED OTHERWISE
VERIFY IN FIELD
WIDE(WIDTH)
WITH

WOOD

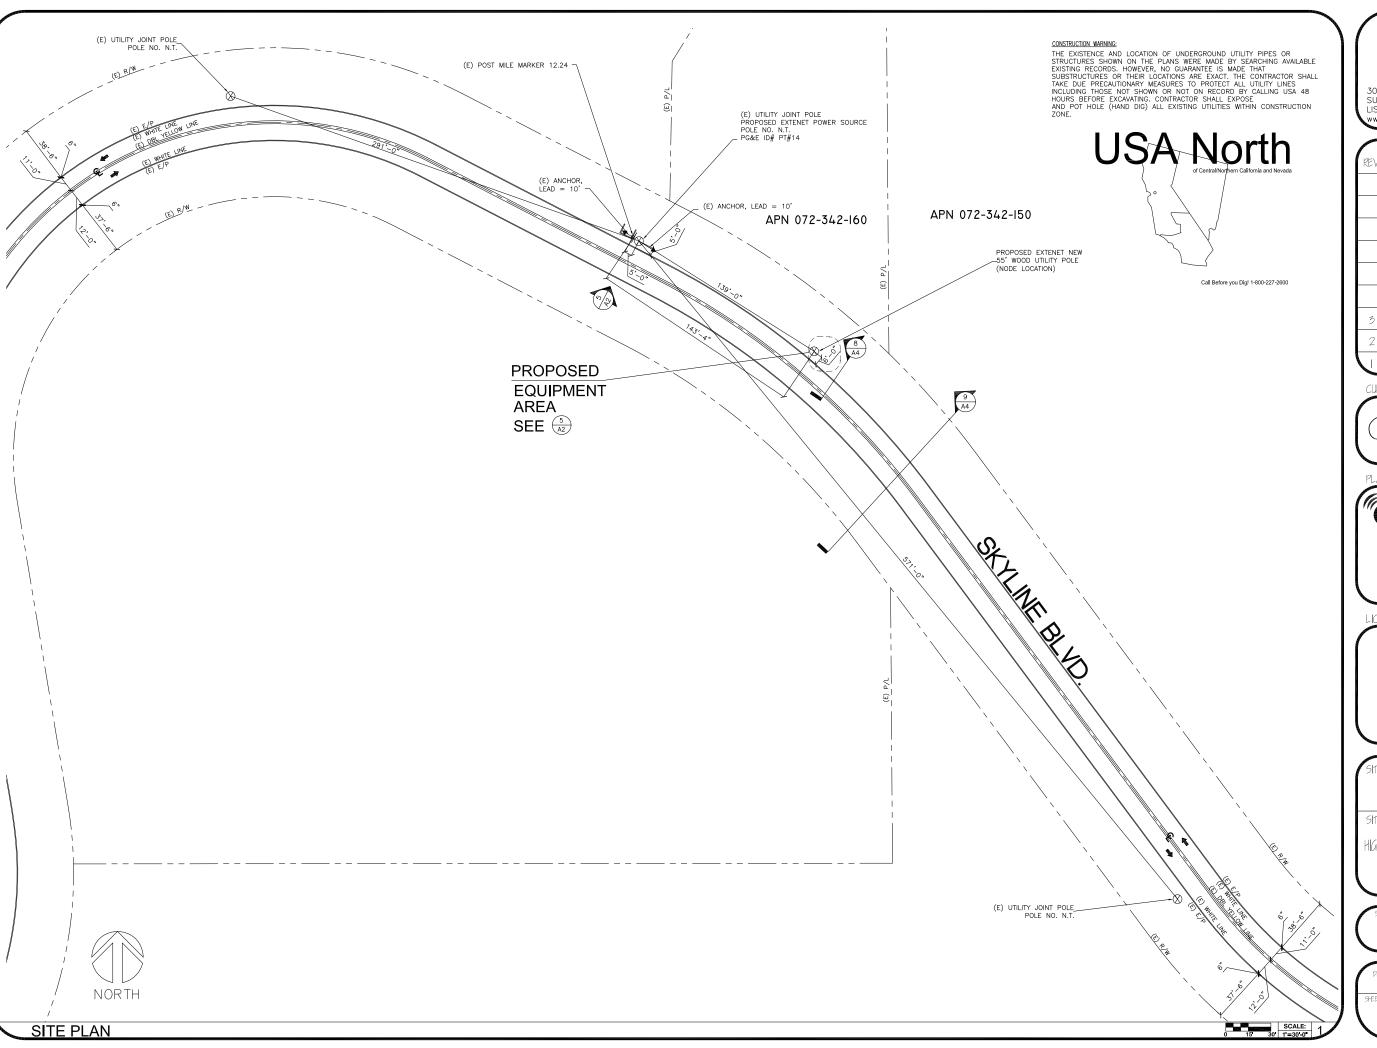



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PLANS PREPARED BY:



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A CONTRACTOR OF THE PARTY OF TH	100000	*

SITE NO.:

HWY8435-013B

SITE NAME & ADDRESS:

HIGHWAY 84/35 NETWORK NODE 013B

16301 SKYLINE BLVD WOODSIDE, CA 94062

SHEET 111

SITE PLAN

DRAWN BY: VG	CHECKED BY: AF	APPROVED BY:
SHEET NUMBER:	Δ1	REVISION:

EXTENET MAKE-READY

SOUTHWEST POLE ELEVATION

- INSTALL 55', CLASS 2, DOUGLAS FIR UTILITY POLE, PER SITE PLAN.
- 2. FLUSH MOUNT 4 PANEL ANTENNAS TOP AT 45'-2" GRADE. SECOND SET 1' BELOW PER ELEVATION.
- 3. STRING IN FIBER/POWER STRAND AND ATTACH AT 25'-0" GRADE W/ANCHOR GUY. PER FIBER DESIGN. 4. INSTALL DELTA NODE RADIOS, BATTERY BACK-UP AND
- ELEC. ENCLOSURE AT 3:00 POSITION W/MIN. 4" SPACING FROM POLE. 5. INSTALL 4" PVC SCH. 40 COAX RISER AT 1:00
- 6. INSTALL 2" PVC SCH. 40 FIBER/PWR RISER AT 2:00

POWER MAKE-READY

- STRING IN SECONDARY POWER FROM PG&E POLE APPROX. 139' NORTH WEST OF PROPOSED NODE
- POLE. (SEE SITE PLAN/POWER DESIGN)
 INSTALL TRANSFORMER AND SECONDARY POWER FOR SERVICE, PER PG&E DESIGN.
- 3. INSTALL 1" PVC SCH. 80 RISER W/WEATHER HEAD AT
- 1:00 (QUAD 1) POSITION.
 4. PROVIDE 120/240V, 3-WIRE, SINGLE PHASE 100 AMP SERVICE TO 1" PG&E RISER TO EXTENET METER BOX FROM SECONDARY POWER AT 47'-0" GRADE.




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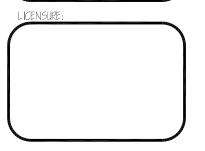
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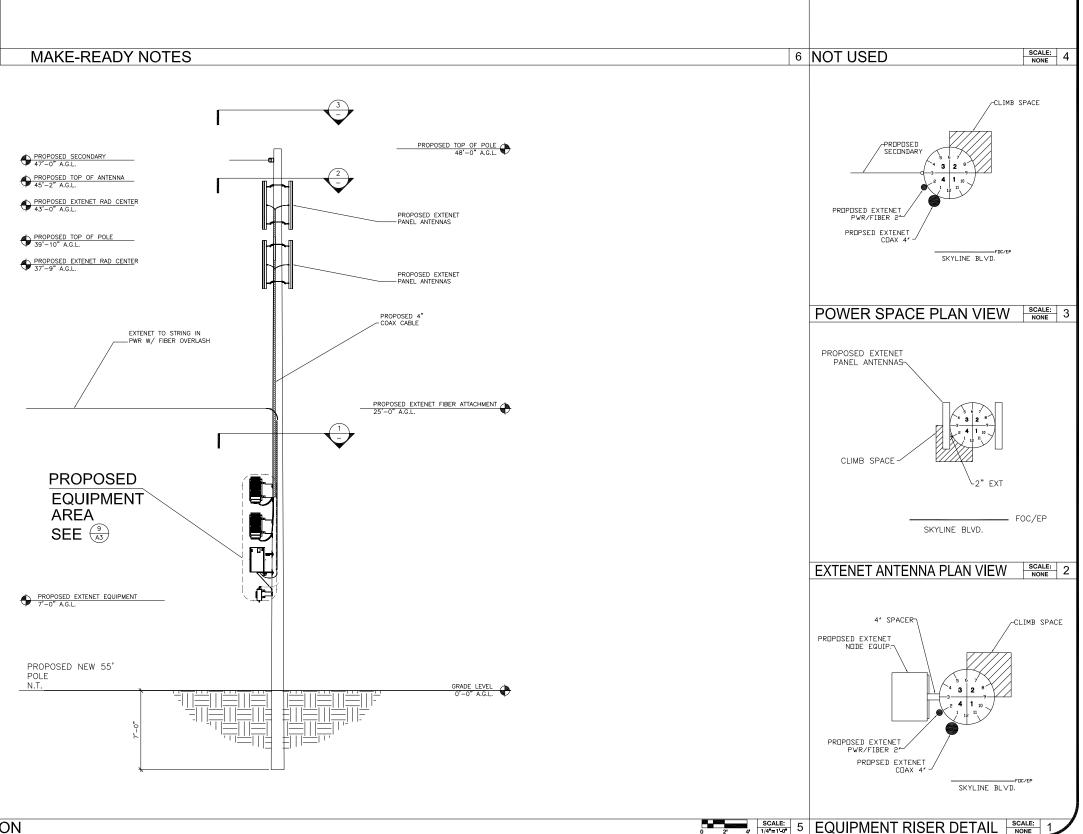



SITE NAME & ADDRESS: HIGHWAY 84/35 NETWORK NODE OI3B

> 16301 SKYLINE BLVD WOODSIDE, CA 94062

ELEVATIONS & RISER DETAIL

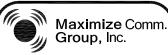DRAWN BY: VG EET NUMBER:	CHECKEP BY:	APPROVED BY: KM REVISION:
	A2	3



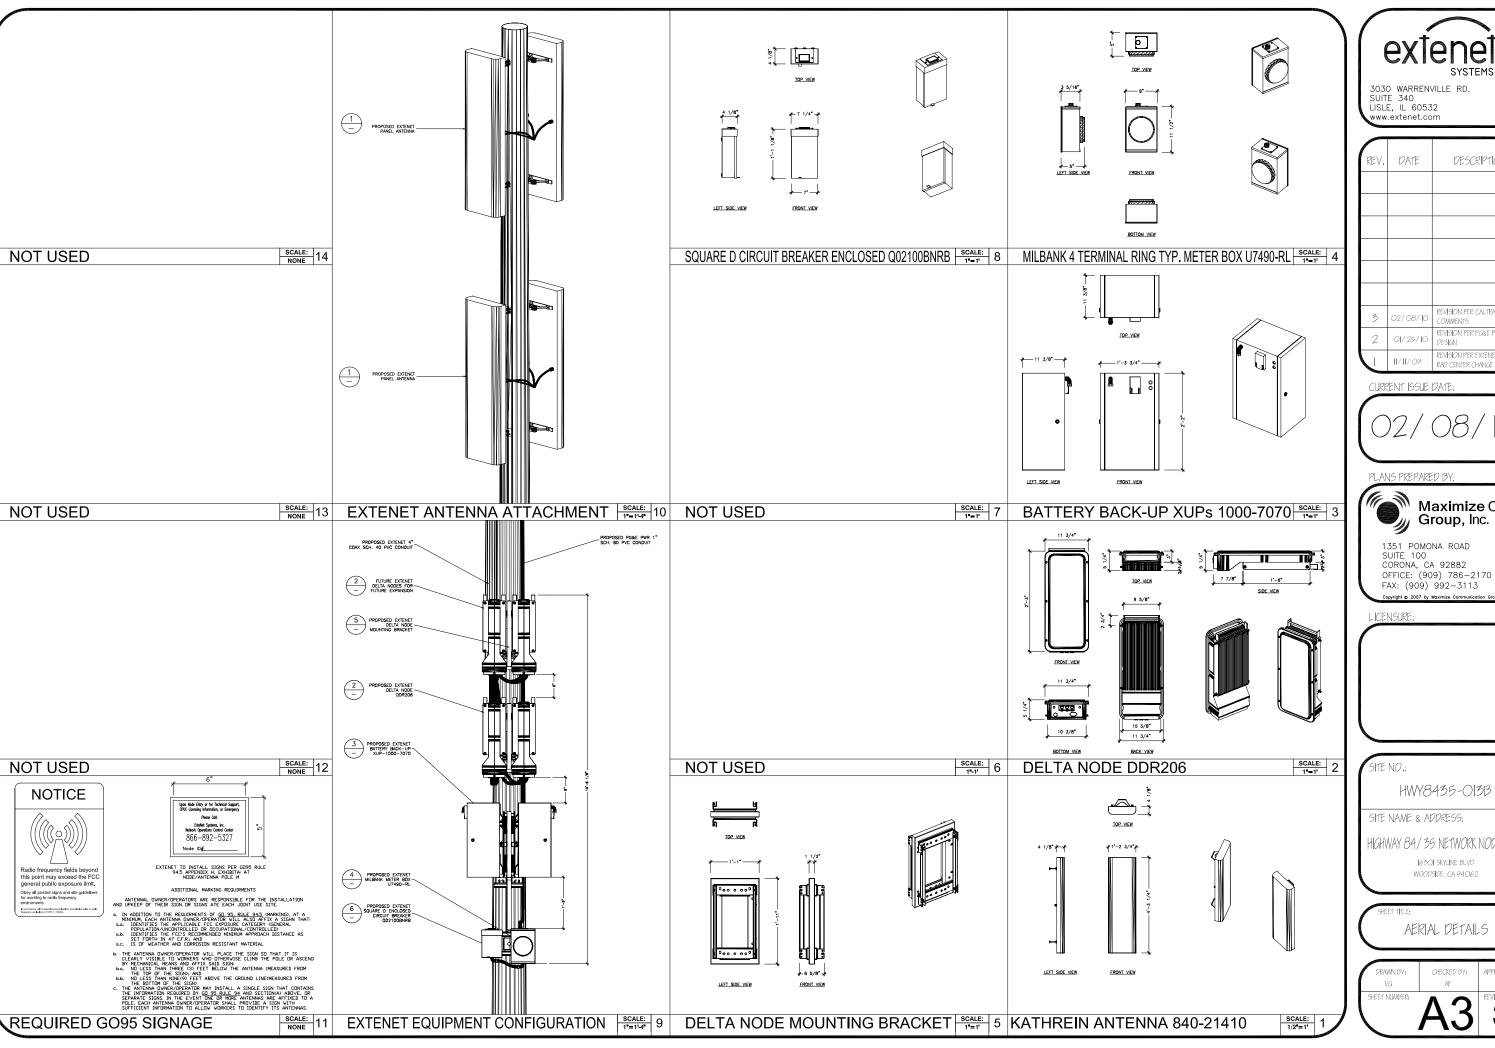



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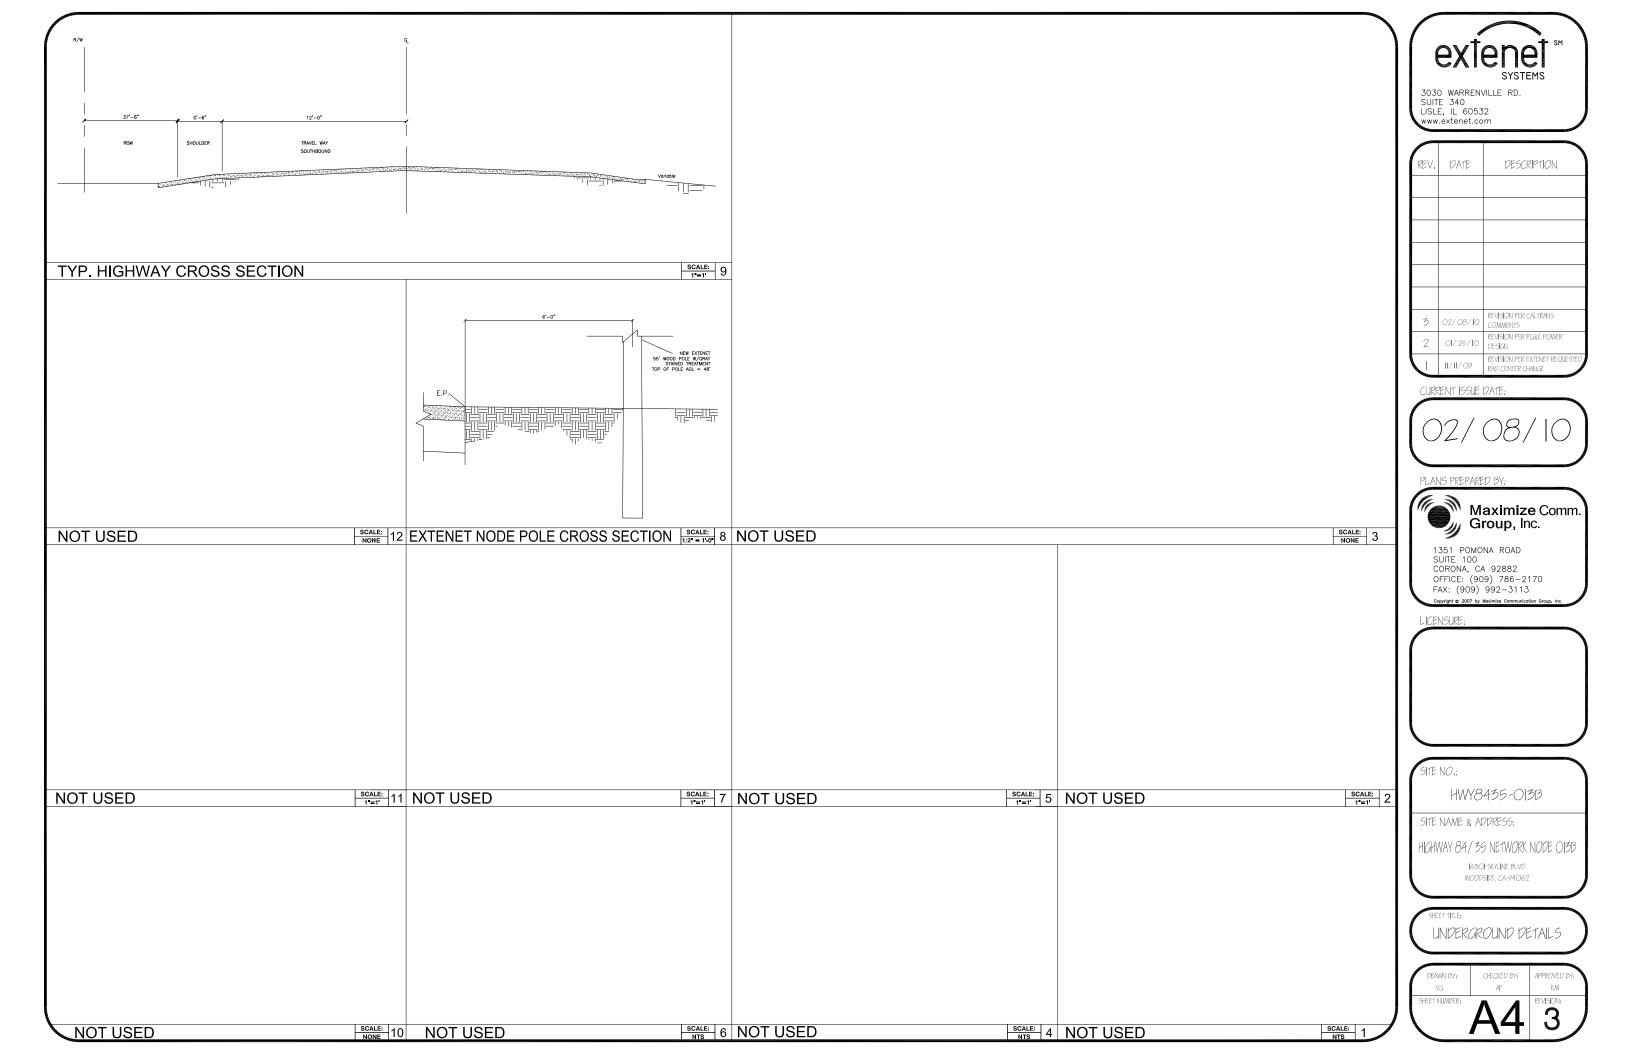


HIGHWAY 84/35 NETWORK NODE OI3B

WOODSIDE, CA 94062

AERIAL DETAILS


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	A3	3



exlene

SYSTEMS

HWY 35 - PROJECT HWY8435 - 014B POST MILE MARKER 11.67 13650 SKYLINE BLVD. WOODSIDE, CA 94062

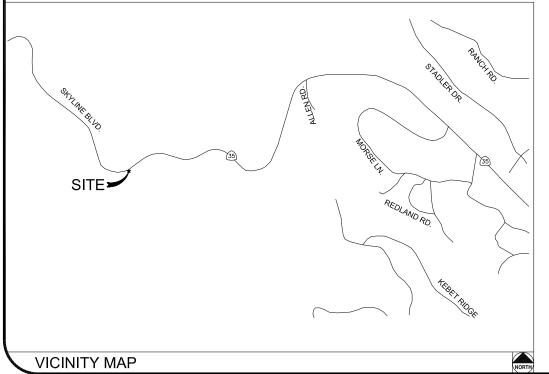

CLIENT

EXTENET SYSTEMS, INC. 3030 WARRENVILLE RD. SUITE 340 LISLE, IL 60532 CONTACT JEFF FRYE PHONE 480-626-1271 FAX 504-285-1603

EXTENET SYSTEMS, INC. 3030 WARRENVILLE RD. SUITE 340 LISLE, IL 60532 CONTACT JEFF FRYE PHONE 480-626-1271 FAX 504-285-1603

ENGINEERING FIRM/SURVEYING

MAXIMIZE COMMUNICATION GROUP, INC. 1351 POMONA ROAD SUITE 100 CORONA, CA 92882 CONTACT KELLI MCCABE PHONE 909-786-2170 FAX 909-992-3113

COORDINATES

CODE COMPLIANCE:

ALL WORK AND MATERIALS SHALL BE PERFORMED & INSTALLED IN ACCORDANCE WITH THE CURRENT EDITIONS OF THE FOLLOWING CODES AS ADOPTED BY LOCAL GOVERNING AUTHORITIES AND LOCAL/CITY/COUNTY ORDINANCES:

1. CALIFORNIA ADMINISTRATIVE CODE (INCLUDING TITLE 24 &

- 2. 2007 CALIFORNIA BUILDING CODE.
- 3. 2007 CALIFORNIA ELECTRICAL CODE.
- 3. BUILDING OFFICIALS AND CODE ADMINISTRATORS (BOCA).
- 4. UNIFORM PLUMBING & MECHANICAL CODES.
- 5. ANSI/EIA-222-F LIFE SAFETY CODE
- 6. CALIFORNIA GENERAL ORDER 95, 128 & 165.

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3030 WARRENVILLE RD. SUITE 340 LISLE, IL 60532 www.extenet.com

1	REV.	DATE	DESCRIPTION
	3	02/08/10	REVISION PER CALTRANS COMMENTS
	2	01/25/10	REVISION PER PG&E POWER DESIGN
'		11/11/09	REVISION PER EXTENET REQUESTED RAD CENTER CHANGE

CURRENT ISSUE DATE:





1351 POMONA ROAD SUITE 100 CORONA, CA 92882 OFFICE: (909) 786-2170 FAX: (909) 992-3113

LICENSURE:	

HWY8435-014B


SITE NAME & ADDRESS:

HGHWAY 84/35 NETWORK NODE OLAE

WOODSIDE CA 94062

111LE SHEET

DRAWN BY	CHECKED BY:	APPROVED BY
VG	AF	KM
SHEET NUMBER:		REVISION:

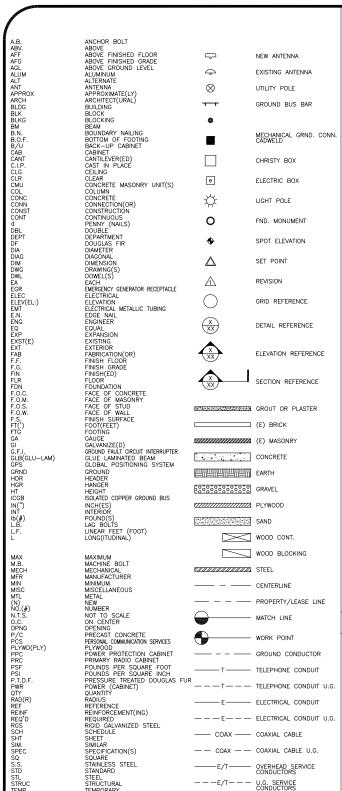

1. THE CONTRACTOR SHALL BE RESPONSIBLE FOR SURVEY MONUMENTS AND/OR VERTICAL CONTROL BENCHMARKS WHICH ARE DISTURBED OR DESTROYED BY CONSTRUCTION. A LAND SURVEYOR MUST FIELD LOCATE, REFERENCE, AND/OR PRESERVE ALL HISTORICAL OR CONTROLLING MONUMENTS PRIOR TO ANY EARTHMORK. IF DESTROYED, SUCH MONUMENTS SHALL BE REPLACED WITH APPROPRIATE MONUMENTS BY A LAND SURVEYOR. A CORNER RECORD OR RECORD OF SURVEY, AS APPROPRIATE, SHALL BE FILED AS REQUIRED BY THE PROPRESSIONAL LAIDS SURVEYOR.

NUMBER BE ISSUED BEFORE A "PERMT TO EXCAVATE" WILL BE VALID. FOR YOUR DIG ALERT I.D. NUMBER, CALL UNDERGROUND SERVICE ALERT, TOLL FREE 1-800-422-4133, TWO DAYS BEFORE YOU DIG.

CROSS THE PROPOSED TRENCH LINE AND MUST MAINTAIN A 1' MINIMUM VERTICAL CLEARANCE.

4. IF ANY EXISTING HARDSCAPE OR LANDSCAPE INDICATED ON THE APPROVE PLANS IS DAMAGED OR REMOVED DURING DEMOLITION OR CONSTRUCTION, IT SHALL BE REPAIRED AND/OR REPLACED IN KIND PER THE APPROVED PLANS.

5. CONTRACTOR SHALL REPLACE OR REPAIR ALL TRAFFIC SIGNAL LOOPS, CONDUIT, AND LANE STRIPING DAMAGED DURING CONSTRUCTION.

6. THIS PROJECT WILL BE INSPECTED BY ENGINEERING AND FIELD ENGINEERING DIVISION

7. MANHOLES OR COVERS SHALL BE LABELED EXTENET

8. CONTRACTOR SHALL IMPLEMENT AN EROSION CONTROL PROGRAM DURING THE PROJECT CONSTRUCTION ACTIVITIES. THE PROGRAM SHALL MEET THE APPLICABLE REQUIREMENTS OF THE STATE WATER RESOURCE CONTROL

9. THE CONTRACTOR SHALL HAVE EMERGENCY MATERIALS AND EQUIPMENT ON HAND FOR UNFORESEEN SITUATIONS, SUCH AS DAMAGE TO UNDERGROUND WATER, SEWER, AND STORM DRAIN FACILITIES WHEREBY FLOWS MAY GENERATE EROSION AND SEDIMENT POLLUTION.

USA North

Call Before you Dlg! 1-800-227-2600

1. INDEMNIFICATION CLAUSE: THE CONTRACTOR AGREES AND SHALL:
ASSUME SOLE AND COMPLETE RESPONSIBILITY OF THE JOB SITE CONDITIONS DURING THE COURSE OF
CONSTRUCTION OF THIS PROJECT, INCLUDING THE SAFETY OF ALL PERSONS AND PROPERTIES. THAT THESE
REQUIREMENTS SHALL APPLY CONTINUOUSLY AND NOT BE LIMITED TO NORMAL WORKING HOURS AND CONDITIONS. ENGINEERS HARMLESS FROM ANY AND ALL LIABILITY, REAL OR ALLEGED IN CONNECTION WITH THE PERFORMANCE

2. PRIOR TO THE BEGINNING OF ANY CONSTRUCTION AND THROUGHOUT THE COURSE OF CONSTRUCTION WORK. THE CONTRACTOR SHALL FULLY COMPLY WITH "CALIFORNIA OCCUPATIONAL SAFETY AND HEALTH" ACT OF 1973 INCLUDING ALL REVISIONS AND AMENDMENTS THERETO.

3. ALL WORK SHALL CONFORM TO THE LATEST EDITIONS OF G095,128 AND THE STANDARD "SPECIFICATIONS FOR PUBLIC WORKS CONSTRUCTION" AS ADOPTED BY THE CITY, COUNTY OR STATE AS MODIFIED BY STANDARD PLANS

4. THE EXISTENCE AND LOCATION OF UTILITIES AND OTHER AGENCY'S FACILITIES AS SHOWN HERON ARE OBJUSTED BY A SEARCH OF AVAILABLE RECORDS. OTHER FACILITIES MAY EXIST. THE CONTRACTOR SHALL VERIFY PRIOR TO THE START OF CONSTRUCTION AND SHALL USE EXTREME CARE AND PROTECTIVE MEASURES TO OR AGENCY FACILITIES WITHIN THE LIMITS OF WORK, WHETHER THEY ARE SHOWN ON THIS PLAN OR NOT.

5. THE CONTRACTOR SHALL NOTIFY THE CITY, COUNTY OR STATE ENGINEER INSPECTION DEPARTMENT, AT LEAST TWO DAYS BEFORE START OF ANY WORK REQUIRING THEIR INVOLVEMENT.

6. THE CITY, COUNTY OR STATE SHALL SPECIFY THE EXPIRATION PERIOD OF THE PERMIT FOR THIS CONSTRUCTION PROJECT.

7. THE MINIMUM COVER FOR ALL CONDUITS PLACED UNDERGROUND SHALL BE 36 INCHES TO THE FINISHED GRADE AT ALL TIMES.

8. THE CONTRACTOR SHALL TUNNEL ALL CURB AND GUTTERS AND BORE ALL CONCRETE DRIVEWAYS AND WALKWAYS AT THE DIRECTION OF THE CITY, COUNTY OR STATE ENGINEER.

ALL A.C AND/OR CONCRETE PAVEMENT SHALL BE REPLACED AT THE DIRECTION OF THE CITY, COUNTY OR STATE ENGINEERS.

WORK, SHALL BE REPLANTED AND/OR REPLACED SO AS TO RESTORE THE WORK SITE TO ITS ORIGINAL CONDITION 11. THE CONTRACTOR WILL BE RESPONSIBLE FOR THE PROCESSING OF ALL APPLICANT PERMIT FORMS ALONG WITH THE REQUIRED LIABILITY INSURANCE FORMS. CLEARLY DEMONSTRATING THAT EXTENET, THE CITY, COUNTY OR STATE IS ALSO INSURED WITH THE REQUIRED LIABILITY INSURANCE IN THE AMOUNT OF \$1,000,000.00 FOR THIS

12. VAULTS, PEDESTALS, CONDUITS AND OTHER TYPES OF SUBSTRUCTURE ARE EITHER SPECIFIED ON THIS PLAN OR WILL BE SPECIFIED BY THE CONSTRUCTION ENGINEER. ANY AND ALL DEVIATIONS FROM THE SPECIFIED TYPES OF MATERIAL MUST BE APPROVED BY THE SYSTEM ENGINEER, IN WRITING BEFORE INSTALLATION THEREOF.

13. THE CONTRACTOR SHALL VERIFY THE LOCATION OF ALL EXISTING UTILITIES IN INCLUDING SEWER LATERALS & WATER SERVICES TO INDIVIDUAL LOTS BOTH VERTICAL AND HORIZONTAL PRIOR TO COMMENCING IMPROVEMENT

14. CONTRACTOR SHALL MAKE EXPLORATION EXCAVATIONS AND LOCATE EXISTING FACILITIES SUFFICIENTLY AHEAD OF CONSTRUCTION TO PERMIT REVISIONS TO PLANS IF REVISION IS NECESSARY BECAUSE OF LOCATION OF

15. THE LOCATIONS OF ALL EXISTING UTILITIES SHOWN ON THESE PLANS ARE FROM EXISTING RECORDS AND CORROBORATED, WHERE POSSIBLE, WITH FIELD TIES. THE CONTRACTOR IS RESPONSIBLE FOR CONFIRMINT LOCATIONS SHOWN, BOTH HORIZONIAL AND VERTICALLY. PRIOR TO CONSTRUCTION, IF EXISTING LOCATIONS WAR SUBSTANTIALLY FROM THE PLANS. THE ENGINEER SHOULD BE NOTIFIED TO MAKE ANY CONSTRUCTION CHANGES

EROSION AND SEDIMENT CONTROL NOTES

TEMPORARY EROSION/SEDIMENT CONTROL PRIOR TO COMPLETION OF FINAL IMPROVEMENTS, SHALL BE PERFORMED BY THE CONTRACTOR OR QUALIFIED PERSON AS INDICATED BELOW:

1. ALL REQUIREMENTS OF THE CITY, COUNTY AND STATE "STORM WATER STANDARDS" MUST BE INCORPORATED INTO THE DESIGN AND CONSTRUCTION OF THE PROPOSED GRADING/IMPROVMENTS CONSISTENT WITH THE APPROVED STORM WATER POLLUTION PREVENTION PLAN (SWPPP), WATER QUALITY TECHNICAL REPORT (WQTR), AND/OR WATER POLLUTION CONTROL PLAN (WPCP).

2. FOR STORM DRAIN INLETS, PROVIDE A GRAVEL BAG SILT BASIN IMMEDIATELY UPSTREAM OF INLET AS INDICATED ON DETAILS.

3. FOR INLETS LOCATED AT SUMPS ADJACENT TO TOP OF SLOPES. THE CONTRACTOR SHALL ENSURE THAT WATER DRAINING TO THE SUMP IS DIRECTED INTO THE INLET AND THAT A MINIMUM OF 1.00° FREEBOARD EXISTS AND IS MAINTAINED ABOVE THE TOP OF THE INLET. IF FREEBOARD IS NOT PROVIDED BY GRADING SHOWN ON

4. THE CONTRACTOR OR QUALIFIED PERSON SHALL BE RESPONSIBLE FOR CLEANUP OF SILT AND MUD ON ADJACENT STREET(S) AND STORM DRAIN SYSTEM DUE TO CONSTRUCTION ACTIVITY.

5. THE CONTRACTOR OR QUALIFIED PERSON SHALL CHECK AND MAINTAIN ALL LINED AND UNLINED DITCHES AFTER EACH RAINFALL.

6. THE CONTRACTOR SHALL REMOVE SILT AND DEBRIS AFTER EACH MAJOR RAINFALL

B. THE CONTRACTOR SHALL RESTORE ALL EROSION/SEDIMENT CONTROL DEVICES TO WORKING ORDER TO THE SATISFACTION OF THE CITY ENGINEER OF RESIDENT ENGINEER AFTER EACH RUN-OFF PRODUCING RAINFALL.

). THE CONTRACTOR SHALL INSTALL ADDITIONAL EROSION/SEDIMENT CONTROL MEASURES AS MAY BE REQUIRED BY THE RESIDENT ENGINEER DUE TO UNCOMPLETED GRADING OPERATIONS OR UNFORESEEN CIRCUMSTANCES,

10. THE CONTRACTOR SHALL BE RESPONSIBLE AND SHALL TAKE NECESSARY PRECAUTIONS TO PREVENT PUBLIC TRESPASS ONTO AREAS WHERE IMPOUNDED WATERS CREATE A HAZARDOUS CONDITION.

11. ALL EROSION/SEDIMENT CONTROL MEASURES PROVIDED PER THE APPROVED GRADING PLAN SHALL BE INCORPORATED HERON. ALL EROSION/SEDIMENT CONTROL FOR INTERIM CONDITIONS SHALL BE DONE TO THE SATISFACTION OF THE RESIDENT ENGINEER.

12. GRADED AREAS AROUND THE PROJECT PERIMETER MUST DRAIN AWAY FROM THE FACE OF THE SLOPE AT THE CONCLUSION OF EACH WORKING DAY.

13. ALL REMOVABLE PROTECTIVE DEVICES SHOWN SHALL BE IN PLACE AT THE END OF EACH WORKING DAY WHEN RAIN IS IMMINENT.

14. THE CONTRACTOR SHALL ONLY GRADE, INCLUDING CLEARING AND GRUBBING FOR THE AREAS FOR WHICH THE CONTRACTOR OR QUALIFIED PERSON CAN PROVIDE EROSION/SEDIMENT CONTROL MEASURES.

15. THE CONTRACTOR SHALL ARRANGE FOR WEEKLY MEETINGS DURING OCTOBER 1ST TO APRIL 30TH FOR PROJECT TEAM (GENERAL CONTRACTOR, QUALIFIED PERSON, EROSION CONTROL SUBCONTRACTOR IF AN, ENGINEER OF WORK, OWNER/DEVELOPER AND THE RESIDENT ENGINEER) TO EVALUATE THE ADEQUACY OF THE EROSION/SEDIMENT CONTROL MEASURE AND OTHER RELATED CONSTRUCTION ACTIVITIES.

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2

GENERAL NOTES

1. 120/240 POWER REQUIRED FOR 3-WIRE SERVICE.
2. GC TO REMOVE/CLEAN ALL DEBRIS, NAILS, STAPLES, OR NON-USED VERTICALS OFF THE POLE.
3. ALL CONSTRUCTION SHALL BE IN ACCORDANCE WITH MUNICIPAL, COUNTY, STATE, FEDERAL, GO95 AND G0128 STANDARDS AND REQUILATIONS.
4. CALL USA 48 HOURS PRIOR TO EXCAVATING AT (800) 422-4133.
5. ALL LANDSCAPING TO BE RESTORED TO ORIGINAL CONDITION OR BETTER.
6. ALL EQUIPMENT TO BE BONDED.

7. METERING CABINET REQUIRES 3'[.914M] CLEARANCE AT DOOR OPENING. 8. CAULK CABINET BASE AT PAD.

5/8"x8"[.016x2.44M] ROD, CAD WELD BELOW GRADE

#6 GROUND AND BOND WIRE

STANDARD GROUNDING NOTES:

. WOOD MOLDING, STAPLED EVERY 3'[.914M] AND AT EACH END . GROUNDS 3'[.914M] FROM POLE.

6. PLACE 3 #10GA WIRES FROM BREAKER TO METER BOX.

STANDARD CONDUIT NOTES:

1. FOR UNDERGROUND USE SCHEDULE 40.
2. FOR RISERS USE SCHEDULE 80.
3. PLACE 2"[.051M] GALVANIZED STEEL CONDUIT FOR ANY CONDUIT UNDER 3"[.076M], STUB UP 10"[3.04M] THEN CONVERT TO SCHEDULE 80.
4. CONVERT 4"[.102M] CARRIER CONDUIT TO 3"[.076M] AT BASE OF POLE.
5. GC TO STUB UP POLE 10"[3.04M] w/3" POWER CONDUIT, POWER CO. TO CONVERT TROM 3"[.076M] SCH. 80 TO 2"[.051M] SCH. 80 FROM TOP OF STUB UP.

ALL CONDUIT WILL BE MAN DRILLED AND EQUIPPED WITH 3/8"[.010M] PULL ROPE.

MAINTAIN 40"[1.02M] MINIMUM COVER FOR ELECTRICAL CONDUIT.
 MAINTAIN 30"[7.62M] MINIMUM COVER FOR COMMUNICATIONS CONDUIT.
 SAND SHADING MINIMUM 1"[0.025M] UNDER CONDUITS, AND 6"[1.152M] COVERING ON TOP REQUIRED.
 ALL ELECTRICAL SERVICE CONDUITS FROM POWER COMPANY, WHETHER FROM POLES, TRANSFORMERS, OR OTHER LOCATIONS; WILL BE SLURRY BACKELIES.

5. IN STREET SLURRY TO GRADE AND MILL DOWN 1-1/2"[.038M] FOR AC CAP. 6. IN DIRT SLURRY 18"[.457M] FROM GRADE, AND FILL WITH 95% COMPACTION NATIVE SOIL FOR BALANCE.

PLACE WARNING TAPE IN TRENCH 12"[.305M] ABOVE ALL CONDUITS AND #18 WARNING TAPE ABOVE GROUND RING.

. NO BOLT THREADS TO PROTRUDE MORE THAN 1-1/2"[.038M]. . FILL ALL HOLES LEFT IN POLE FROM REARRANGEMENT OF CLIMBERS.

ALL CLIMB STEPS NEXT TO CONDUIT SHALL HAVE EXTENDED STEPS.

4. CABLE NOT TO IMPEDE 15"[.381M] CLEAR SPACE OFF POLE FACE

4. CABLE NOT TO IMPEDE 151_ASTIM] CLEAR SPACE OFF POLE FACE (12:00).
5. 90' SHORT SWEEPS UNDER ANTENNA ARM. ALL CABLES MUST ONLY TRANSITION ON THE INSIDE OR BOTTOM OF ARMS (NO CABLE ON TOP OF ARMS).
6. USE CABLE CLAMPS TO SECURE CABLE TO ARMS; PLACE 2"[0.51 M] CARRIER CABLE ID TAGS ON BOTH SIDES OF ARMS.
7. USE 90' CONNECTOR AT CABLE CONNECTION TO ANTENNAS.
8. PLACE GPS ON ARM WITH SOUTHERN SYLEXPOSURE AT MINIMUM.

S'[1.83M] FROM TRANSMIT ANTENNA, WHICH IS 24"[.61M] AWAY FROM CENTER OF POLE.

9. USE 1/2"[.013M] CABLE ON ANTENNAS UNLESS OTHERWISE

10. FILL VOID AROUND CABLES AT CONDUIT OPENING WITH FOAM SEALANT TO PREVENT WATER INTRUSION.

ANTENNA/WOOD ARM AREA TOTAL	77.48 SQ. FT.
TOP GRADE	28'-3"
BOTTOM GRADE	23'-11"
METER/BREAKER AREA TOTAL	4.33 SQ. FT.
TOP GRADE	8'-0"
BOTTOM GRADE	7'-0"
BATTERY BACK-UP AREA TOTAL	16.25 SQ. FT.
TOP GRADE	11'-8"
BOTTOM GRADE	9'-6"
DELTA DECK AREA TOTAL	10.74 SQ. FT.
TOP GRADE	14'-7"
BOTTOM GRADE	12'-5"
DELTA DECK (FUT.) AREA TOTAL	10.74 SQ. FT.
TOP GRADE	17'-6"
BOTTOM GRADE	15'-4"
EXT. RISER SIZE	4"-ø
EXT. RISER LENGTH	15'-1"
EXT. RISER BTM GRADE	14'-5"
PWR RISER SIZE	1"-ø
PWR RISER LENGTH	11'-0"
PWR RISER BTM GRADE	8'-8"

WIND LOADING INFORMATION

ANTENNA & CABLE SCHEDULE					
ANTENNA SECTOR	AZIMUTH	ANTENNA MAKE / MODEL	COAXIAL CABLE LENGTH	CABLES PER SECTOR	CABLE SIZE
SECTOR ALPHA	313*	KATHREIN 840 21410	42'-5"	2	1/2"
SECTOR BETA	81*	KATHREIN 840 21410	42'-5"	2	1/2"
SECTOR GAMMA					
NOTE:					

NOTE:
CONTRACTOR TO FIELD VERIFY CABLE LENGTHS PRIOR TO ORDERING, FABRICATION, OR INSTALLATION OF CABLE:

HWY8435-014B

SITE NAME & ADDRESS:

HIGHWAY 84/35 NETWORK NODE OLAB

13650 SKYLINE BLVD. WOODSIDE, CA 94062

IENERAL NOTES & SCHEDULE

SHEET NUMBER EVISION: 3

ABBREVIATION AND LEGEND

THICK(NESS)


WOOD

TOP OF PLATE (PARAPET)
TOP OF STEEL (SLAB)
TOP OF WALL

TOP OF WALL
TYPICAL
UNDER GROUND
UNDERWRITERS LABORATORY
UNLESS NOTED OTHERWISE
VERIFY IN FIELD
WIDE(WIDTH)
WITH

ROW CONSTRUCTION GENERAL NOTES

LOADING AND ANTENNA CABLE SCHEDULES

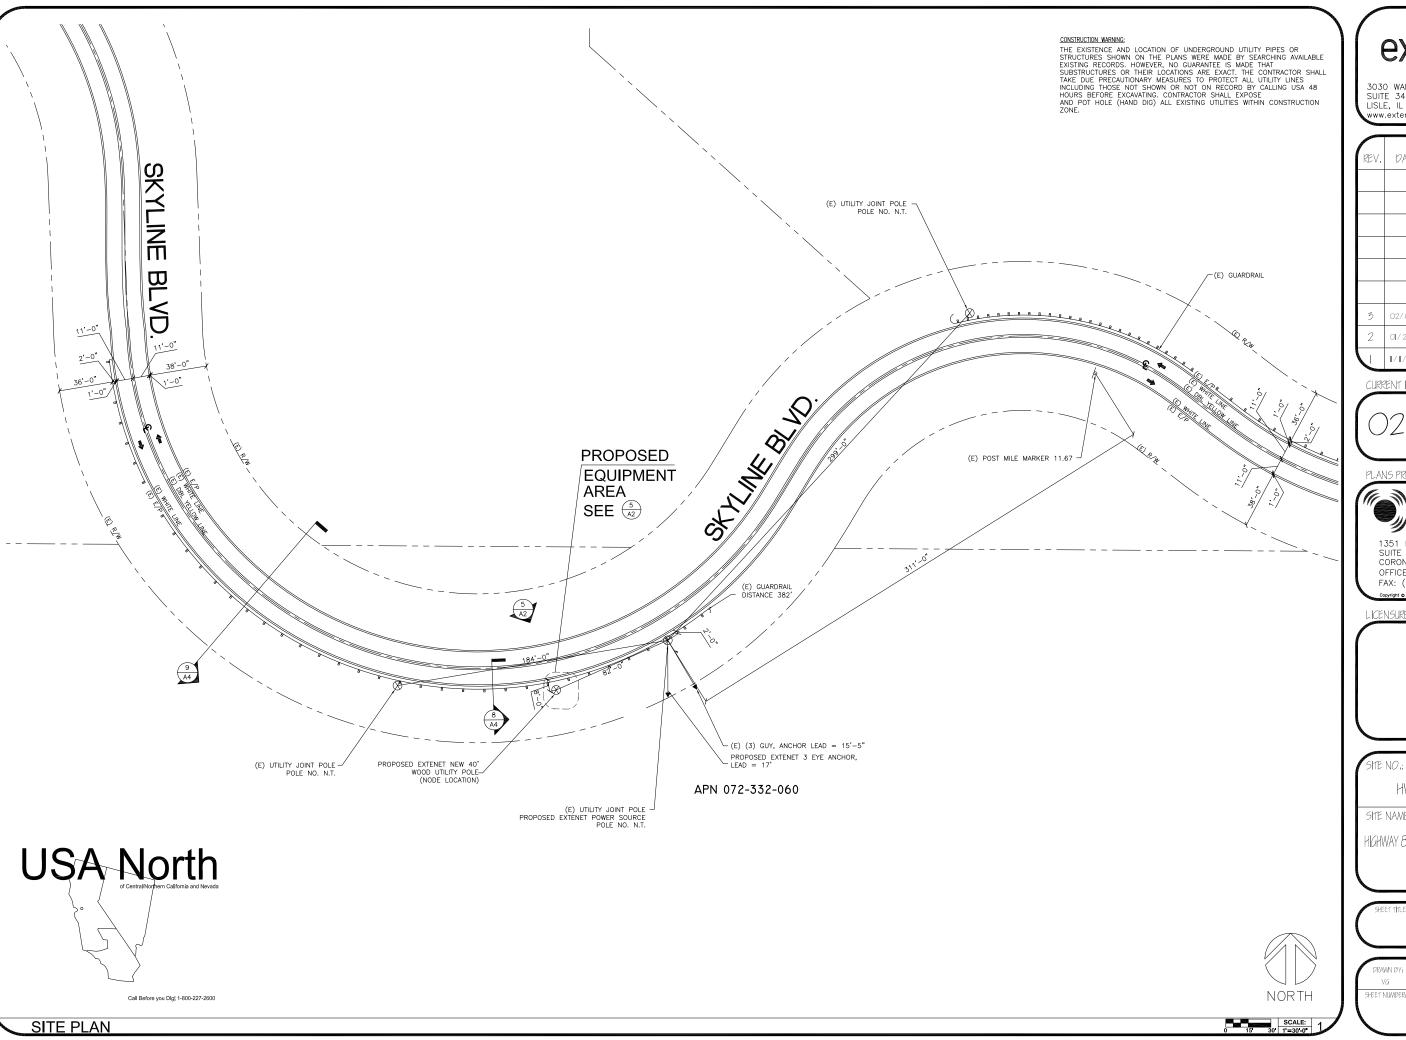



-477		Name of the last o
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PLANS PREPARED BY:



1351 POMONA ROAD SUITE 100 CORONA, CA 92882 OFFICE: (909) 786-2170 FAX: (909) 992-3113

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LICENSURE

HWY8435-014B

SITE NAME & ADDRESS:

HIGHWAY 84/35 NETWORK NODE OI4B

13650 SKYLINE BLVD. WOODSIDE, CA 94062

SITE PLAN

DRAWN BY: VG	CHECKED BY: AF	APPROVED BY
SHEET NUMBER:	^ 4	REVISION:

EXTENET MAKE-READY

- INSTALL 40', CLASS 2, DOUGLAS FIR UTILITY POLE, PER SITE PLAN.
- 2. FLUSH MOUNT 4 PANEL ANTENNAS TOP AT 32'-2" GRADE. SECOND SET 1' BELOW PER ELEVATION.
- 3. STRING IN FIBER/POWER STRAND AND ATTACH AT 23'-0" GRADE W/ANCHOR GUY. PER FIBER DESIGN.
- 4. INSTALL DELTA NODE RADIOS, BATTERY BACK-UP AND ELEC. ENCLOSURE AT 3:00 POSITION W/MIN. 4" SPACING FROM POLE.
- 5. INSTALL 4" PVC SCH. 40 COAX RISER AT 1:00

MAKE-READY NOTES

6. INSTALL 2" PVC SCH. 40 FIBER/PWR RISER AT 2:00

PROPOSED TOP OF ANTENNA 32'-2" A.G.L.

PROPOSED TOP OF POLE 26'-10" A.G.L.

PROPOSED EQUIPMENT

PROPOSED EXTENET EQUIPMENT 7'-0" A.G.L.

PROPOSED NEW 40'

POLE

AREA SEE $\frac{9}{A3}$

EXTENET TO STRING IN PWR W/ FIBER OVERLASH-

PROPOSED EXTENET RAD CENTER 30'-0" A.G.L.

PROPOSED EXTENET RAD CENTER 24'-9" A.G.L.

0

POWER MAKE-READY

- STRING IN SECONDARY POWER FROM PG&E POLE
 APPROX. 82' NORTH EAST OF PROPOSED NODE POLE. (SEE SITE PLAN/POWER DESIGN)
- INSTALL TRANSFORMER AND SECONDARY POWER FOR SERVICE, PER PG&E DESIGN.
- 3. INSTALL 1" PVC SCH. 80 RISER W/WEATHER HEAD AT
- 1:00 (QUAD 1) POSITION.

 4. PROVIDE 120/240V, 3-WIRE, SINGLE PHASE 100 AMP SERVICE TO 1" PG&E RISER TO EXTENET METER BOX FROM SECONDARY POWER AT 33'-0" GRADE.

PROPOSED TOP OF POLE 34'-0" A.G.L.


PROPOSED EXTENET (1)
-PANEL ANTENNAS (A3)


PROPOSED EXTENET 1
PANEL ANTENNAS A3


PROPOSED EXTENET FIBER ATTACHMENT 23'-0" A.G.L.

PROPOSED SECONDARY
33'-0" A.G.L.

6 NOT USED CLIMB SPACE PROPOSED SECONDARY

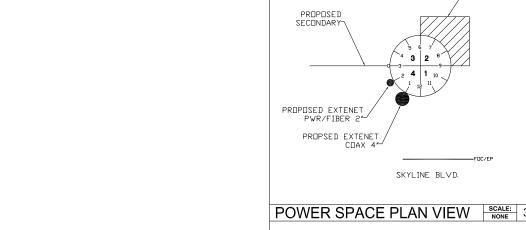

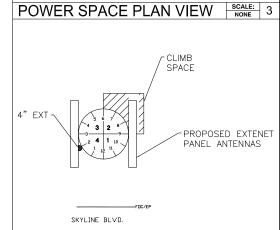

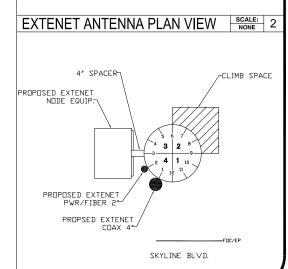

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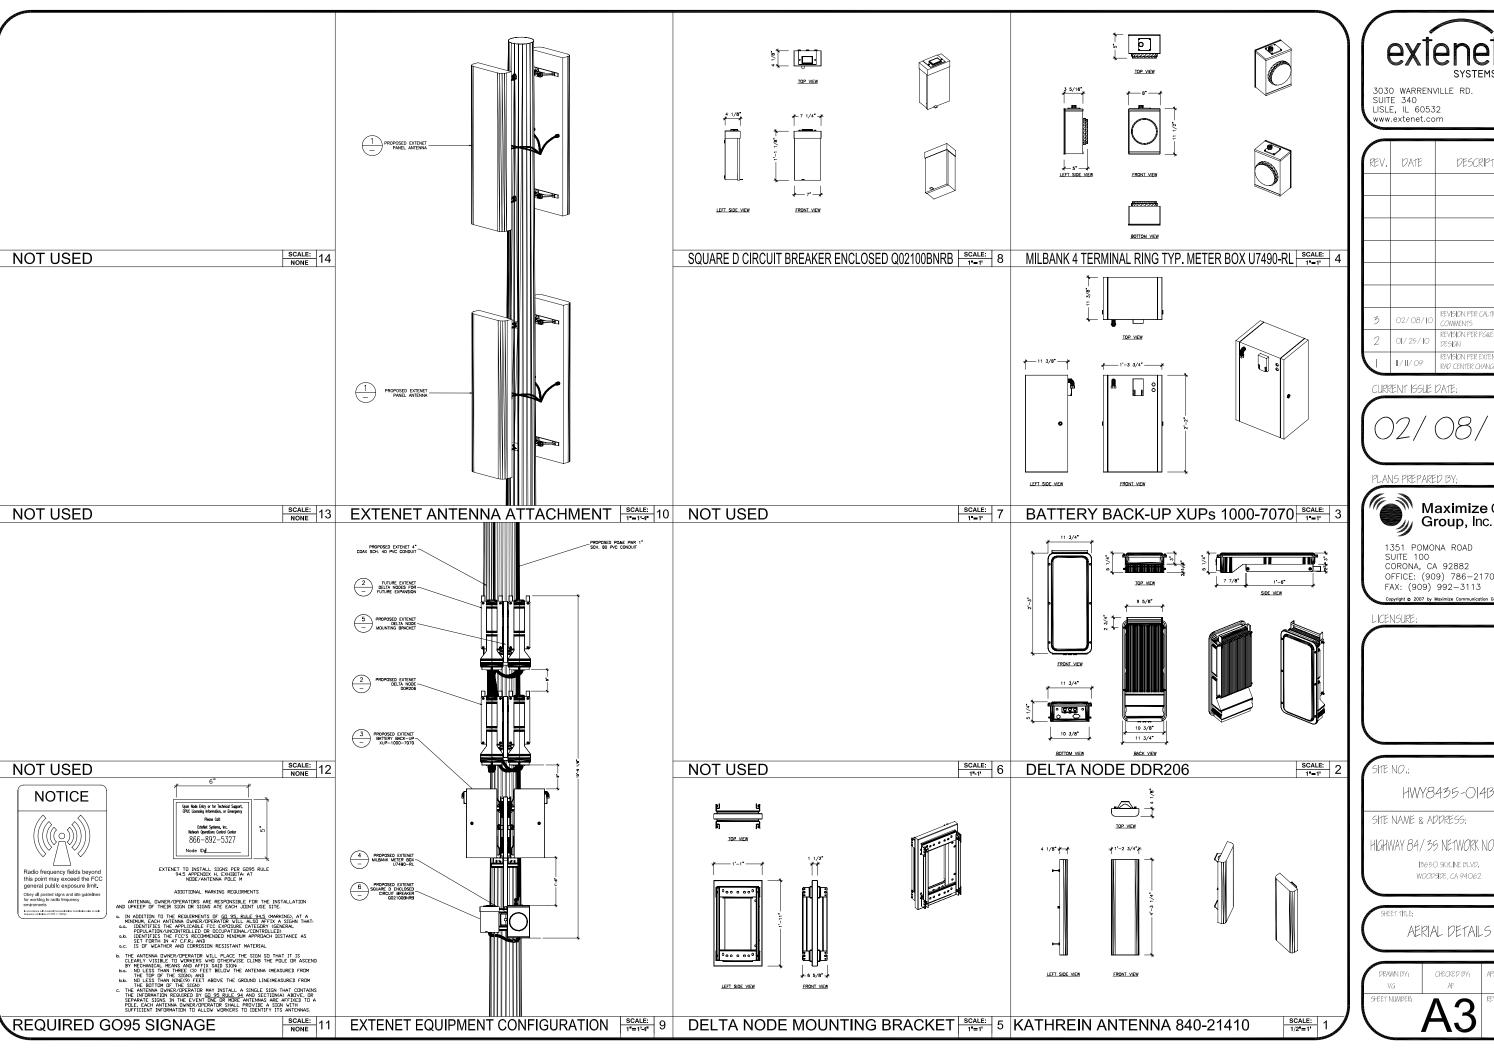
ELEVATIONS & RISER DETAIL

WOODSIDE, CA 94062

KM EVISION: 7 3

SCALE: 5 EQUIPMENT RISER DETAIL

NORTH POLE ELEVATION





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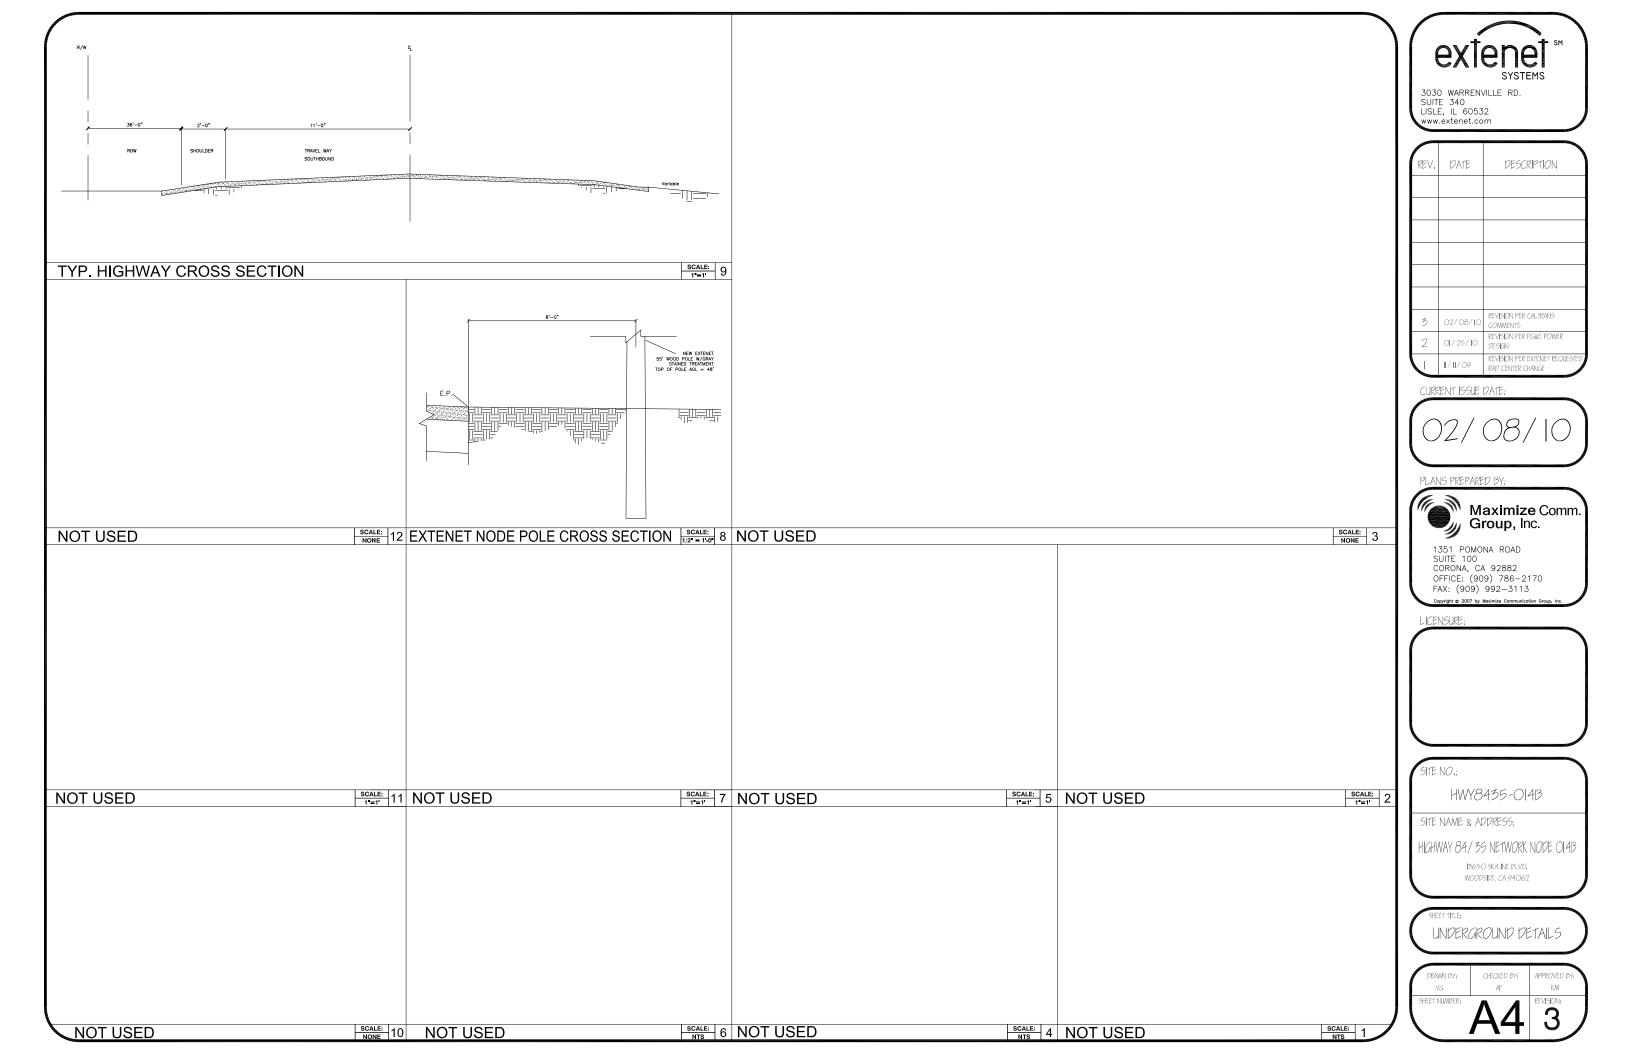
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	SHEET NUMBER:	A3	REVISION:
1	DRAWN BY: VG	CHECKED BY:	APPROVED BY:






HWY 35 - PROJECT HWY8435 - 015C

POST MILE MARKER 11.31

16995 SKYLINE BLVD (ACROSS STREET) WOODSIDE, CA 94062

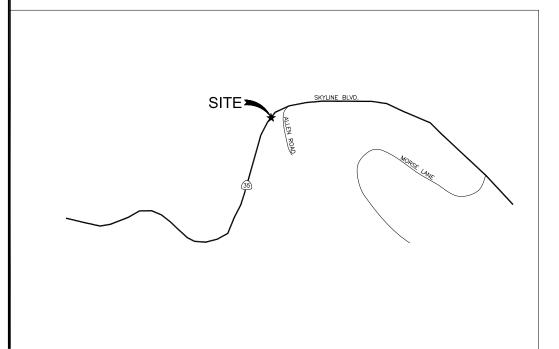

VICINITY MAP

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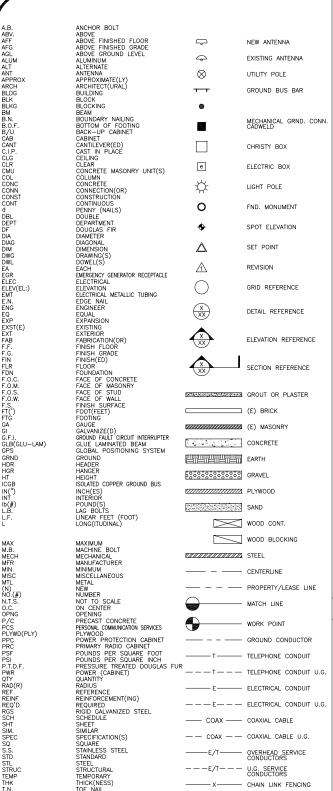
SITE NAME & ADDRESS:

HIGHWAY 84/35 NETWORK NODE 15C

6995 SKYLINE BLVD (ACROSS STREET) WOODSDE CA 94062

TITLE SHEET

EVISION:



1. THE CONTRACTOR SHALL BE RESPONSIBLE FOR SURVEY MONUMENTS AND/OR VERTICAL CONTROL BENCHMARKS WHICH ARE DISTURBED OR DESTROYED BY CONSTRUCTION. A LAND SURVEYOR MUST FIELD LOCATE, REFERENCE, AND/OR PRESERVE ALL HISTORICAL OR CONTROLLING MONUMENTS PROR TO ANY EARTHWORK. IF DESTROYED, SUCH MONUMENTS SHALL BE REPLACED WITH APPROPRIATE MONUMENTS BY A LAND SURVEYOR. A CORNER RECORD OR RECORD OF SURVEY, AS APPROPRIATE, SHALL BE FILED AS REQUIRED BY THE PROPRESSIONAL LAIDS SURVEYOR.

PORTANT NOTICE: SECTION 4215 OF THE GOVERNMENT CODE REQUIRES A DIG ALERT IDENTIFICATION NUMBER BE ISSUED BEFORE A "PERMT TO EXCAVATE" WILL BE VALID. FOR YOUR DIG ALERT I.D. NUMBER, CALL UNDERGROUND SERVICE ALERT, TOLL FREE 1-800-422-4133, TWO DAYS BEFORE YOU DIG.

CROSS THE PROPOSED TRENCH LINE AND MUST MAINTAIN A 1' MINIMUM VERTICAL CLEARANCE.

4. IF ANY EXISTING HARDSCAPE OR LANDSCAPE INDICATED ON THE APPROVE PLANS IS DAMAGED OR REMOVED DURING DEMOLITION OR CONSTRUCTION, IT SHALL BE REPAIRED AND/OR REPLACED IN KIND PER THE APPROVED PLANS.

5. CONTRACTOR SHALL REPLACE OR REPAIR ALL TRAFFIC SIGNAL LOOPS, CONDUIT, AND LANE STRIPING DAMAGED DURING CONSTRUCTION.

6. THIS PROJECT WILL BE INSPECTED BY ENGINEERING AND FIELD ENGINEERING DIVISION

7. MANHOLES OR COVERS SHALL BE LABELED EXTENE

8. CONTRACTOR SHALL IMPLEMENT AN EROSION CONTROL PROGRAM DURING THE PROJECT CONSTRUCTION ACTIVITIES. THE PROGRAM SHALL MEET THE APPLICABLE REQUIREMENTS OF THE STATE WATER RESOURCE CONTROL

9. THE CONTRACTOR SHALL HAVE EMERGENCY MATERIALS AND EQUIPMENT ON HAND FOR UNFORESEEN SITUATIONS, SUCH AS DAMAGE TO UNDERGROUND WATER, SEWER, AND STORM DRAIN FACILITIES WHEREBY FLOWS MAY GENERATE EROSION AND SEDIMENT POLLUTION.

USA North

 INDEMNIFICATION CLAUSE: THE CONTRACTOR AGREES AND SHALL: ASSUME SOLE AND COMPLETE RESPONSIBILITY OF THE JOB SITE CONDITIONS DURING THE COURSE OF CONSTRUCTION OF THIS PROJECT, INCLUDING THE EAFETY OF ALL PERSONS AND PROPERTIES. THAT THESE REQUIREMENTS SHULL APPLY CONTINUOUSLY AND NOT BE LIMITED TO NORMAL WORKING HOURS AND CONDITIONS. ENGINEERS HARMLESS FROM ANY AND ALL LIABILITY, REAL OR ALLEGED IN CONNECTION WITH THE PERFORMANCE

2. PRIOR TO THE BEGINNING OF ANY CONSTRUCTION AND THROUGHOUT THE COURSE OF CONSTRUCTION WORK. THE CONTRACTOR SHALL FULLY COMPLY WITH "CALIFORNIA OCCUPATIONAL SAFETY AND HEALTH" ACT OF 1973 INCLUDING ALL REVISIONS AND AMENDMENTS THERETO.

3. ALL WORK SHALL CONFORM TO THE LATEST EDITIONS OF G095,128 AND THE STANDARD "SPECIFICATIONS FOR PUBLIC WORKS CONSTRUCTION" AS ADOPTED BY THE CITY, COUNTY OR STATE AS MODIFIED BY STANDARD PLANS

4. THE EXISTENCE AND LOCATION OF UTILITIES AND OTHER AGENCY'S FACILITIES AS SHOWN HERON ARE OBTAINED BY A SEARCH OF AVAILABLE RECORDS. OTHER FACILITIES MAY EXIST. THE CONTRACTOR SHALL VERIFY PRING TO THE START OF CONSTRUCTION AND SHALL USE EXTREME CAREE AND PROTECTIVE MEASURES TO OR AGENCY FACILITIES WITHIN THE LIMITS OF WORK, WHETHER THEY ARE SHOWN ON THIS PLAN OR NOT.

5. THE CONTRACTOR SHALL NOTIFY THE CITY, COUNTY OR STATE ENGINEER INSPECTION DEPARTMENT, AT LEAST TWO DAYS BEFORE START OF ANY WORK REQUIRING THEIR INVOLVEMENT.

6. THE CITY, COUNTY OR STATE SHALL SPECIFY THE EXPIRATION PERIOD OF THE PERMIT FOR THIS CONSTRUCTION PROJECT.

7. THE MINIMUM COVER FOR ALL CONDUITS PLACED UNDERGROUND SHALL BE 36 INCHES TO THE FINISHED GRADE AT ALL TIMES.

8. THE CONTRACTOR SHALL TUNNEL ALL CURB AND GUTTERS AND BORE ALL CONCRETE DRIVEWAYS AND WALKWAYS AT THE DIRECTION OF THE CITY, COUNTY OR STATE ENGINEER.

ALL A.C AND/OR CONCRETE PAVEMENT SHALL BE REPLACED AT THE DIRECTION OF THE CITY, COUNTY OR STATE ENGINEERS.

WORK, SHALL BE REPLANTED AND/OR REPLACED SO AS TO RESTORE THE WORK SITE TO ITS ORIGINAL CONDITION

11. THE CONTRACTOR WILL BE RESPONSIBLE FOR THE PROCESSING OF ALL APPLICANT PERMIT FORMS ALONG WITH THE REQUIRED LIABILITY INSURANCE FORMS. CLEARLY DEMONSTRATING THAT EXTENET, THE CITY, COUNTY OR STATE IS ALSO INSURED WITH THE REQUIRED LIABILITY INSURANCE IN THE AMOUNT OF \$1,000,000.00 FOR THIS

12. VAULTS, PEDESTALS, CONDUITS AND OTHER TYPES OF SUBSTRUCTURE ARE EITHER SPECIFIED ON THIS PLAN OR WILL BE SPECIFIED BY THE CONSTRUCTION ENGINEER, ANY AND ALL DEVIATIONS FROM THE SPECIFIED TYPES OF MATERIAL MUST BE APPROVED BY THE SYSTEM ENGINEER, IN WRITING BEFORE INSTALLATION THEREOF.

13. THE CONTRACTOR SHALL VERIFY THE LOCATION OF ALL EXISTING UTILITIES IN INCLUDING SEWER LATERALS & WATER SERVICES TO INDIVIDUAL LOTS BOTH VERTICAL AND HORIZONTAL PRIOR TO COMMENCING IMPROVEMENT

14. CONTRACTOR SHALL MAKE EXPLORATION EXCAVATIONS AND LOCATE EXISTING FACILITIES SUFFICIENTLY AHEAD OF CONSTRUCTION TO PERMIT REVISIONS TO PLANS IF REVISION IS NECESSARY BECAUSE OF LOCATION OF

15. THE LOCATIONS OF ALL EXISTING UTILITIES SHOWN ON THESE PLANS ARE FROM EXISTING RECORDS AND CORROBORATED, WHERE POSSIBLE, WITH FIELD TIES. THE CONTRACTOR IS RESPONSIBLE FOR CONFIRMING THE LOCATIONS SHOWN, BOTH HORIZONIAL AND VERTICALLY. PRIOR TO CONSTRUCTION, IF EXISTING LOCATIONS VAR SUBSTANTIALLY FROM THE PLANS. THE ENGINEER SHOULD BE NOTIFIED TO MAKE ANY CONSTRUCTION CHANGES

EROSION AND SEDIMENT CONTROL NOTES

TEMPORARY EROSION/SEDIMENT CONTROL PRIOR TO COMPLETION OF FINAL IMPROVEMENTS, SHALL BE PERFORMED BY THE CONTRACTOR OR QUALIFIED PERSON AS INDICATED BELOW:

1. ALL REQUIREMENTS OF THE CITY, COUNTY AND STATE "STORM WATER STANDARDS" MUST BE INCORPORATED INTO THE DESIGN AND CONSTRUCTION OF THE PROPOSED GRADING/IMPROVMENTS CONSISTENT WITH THE APPROVED STORM WATER POLLUTION PREVENTION PLAN (SWPPP), WATER QUALITY TECHNICAL REPORT (WQTR), AND/OR WATER POLLUTION CONTROL PLAN (WPCP).

2. FOR STORM DRAIN INLETS, PROVIDE A GRAVEL BAG SILT BASIN IMMEDIATELY UPSTREAM OF INLET AS INDICATED ON DETAILS.

3. FOR INLETS LOCATED AT SUMPS ADJACENT TO TOP OF SLOPES, THE CONTRACTOR SHALL ENSURE THAT WATER PORNING TO THE SUMP IS DIRECTED INTO THE INLET AND THAT A MINIMUM OF 1.00' FREEBOARD EXISTS AND IS MAINTAINED ABOVE THE TOP OF THE INLET. IF FREEBOARD IS NOT PROVIDED BY GRADIOS SHOWN ON THESE PLANS THE CONTRACTOR SHALL PROVIDE IT VIA TEMPORARY MEASURES, I.E. GRAVEL BAGS OR DIKES.

THE CONTRACTOR OR QUALIFIED PERSON SHALL BE RESPONSIBLE FOR CLEANUP OF SILT AND MUD ON ADJACENT STREET(S) AND STORM DRAIN SYSTEM DUE TO CONSTRUCTION ACTIVITY.

5. THE CONTRACTOR OR QUALIFIED PERSON SHALL CHECK AND MAINTAIN ALL LINED AND UNLINED DITCHES AFTER EACH RAINFALL.

6. THE CONTRACTOR SHALL REMOVE SILT AND DEBRIS AFTER EACH MAJOR RAINFALL

9. THE CONTRACTOR SHALL INSTALL ADDITIONAL EROSION/SEDIMENT CONTROL MEASURES AS MAY BE REQUIRED BY THE RESIDENT ENGINEER DUE TO UNCOMPLETED GRADING OPERATIONS OR UNFORESEEN CIRCUMSTANCES,

10. THE CONTRACTOR SHALL BE RESPONSIBLE AND SHALL TAKE NECESSARY PRECAUTIONS TO PREVENT PUBLIC TRESPASS ONTO AREAS WHERE IMPOUNDED WATERS CREATE A HAZARDOUS CONDITION.

11. ALL EROSION/SEDIMENT CONTROL MEASURES PROVIDED PER THE APPROVED GRADING PLAN SHALL BE INCORPORATED HERON. ALL EROSION/SEDIMENT CONTROL FOR INTERIM CONDITIONS SHALL BE DONE TO THE SATISFACTION OF THE RESIDENT BEGINEER.

12. GRADED AREAS AROUND THE PROJECT PERIMETER MUST DRAIN AWAY FROM THE FACE OF THE SLOPE AT THE CONCLUSION OF EACH WORKING DAY.

13. ALL REMOVABLE PROTECTIVE DEVICES SHOWN SHALL BE IN PLACE AT THE END OF EACH WORKING DAY

14. THE CONTRACTOR SHALL ONLY GRADE, INCLUDING CLEARING AND GRUBBING FOR THE AREAS FOR WHICH THE CONTRACTOR OR QUALIFIED PERSON CAN PROVIDE EROSION/SEDIMENT CONTROL MEASURES.

15. THE CONTRACTOR SHALL ARRANGE FOR WEEKLY MEETINGS DURING OCTOBER 1ST TO APRIL 30TH FOR PROJECT FEAM (GENERAL CONTRACTOR, QUALIFIED PERSON, EROSION CONTROL SUBCONTRACTOR IF AN, ENGINEER OF WORK, OWNER/DEVELOPER AND THE RESIDENT ENGINEER) TO EVALUATE THE ADEQUACY OF THE EROSION/SEDIMENT CONTROL MEASURE AND OTHER RELATED CONSTRUCTION ACTIVITIES.

ANTENNA & CABLE SCHEDULE

MAKE / MODEL


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KATHREIN

3030 WARRENVILLE RD. LISLE, IL 60532 www.extenet.com

	REV.	DATE	DESCRIPTION
	3	02/08/10	REVISION PER CALTRANS COMMENTS
	2	01/25/10	REVISION PER PG&E POWER DESIGN
1		11/11/09	REVISION PER EXTENET REQUESTED RAD CENTER CHANGE

CURRENT ISSUE DATE

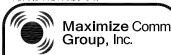

1351 POMONA ROAD SUITE 100 CORONA, CA 92882 OFFICE: (909) 786-2170 FAX: (909) 992-3113 pyright © 2007 by Maximize Communicat

2

CABLE SIZE

1/2"

1/2"

2

2

12'-7'

HWY8435-015C

SITE NAME & ADDRESS:

HIGHWAY 84/35 NETWORK NODE 15C 16995 SKYLINE BLVD (ACROSS STREET)

WOODSDE, CA 94062

IENERAL NOTES & SCHEDULE

DRAWN BY: VG	CHECKED BY: AF	APPROVED BY
SHEET NUMBER:	T2	REVISION:

Call Before you Dlg! 1-800-227-2600

GENERAL NOTES

1. 120/240 POWER REQUIRED FOR 3-WIRE SERVICE.
 2. GC TO REMOVE/CLEAN ALL DEBRIS, NAILS, STAPLES, OR NON-USED VERTICALS OFF THE POLE.
 3. ALL CONSTRUCTION SHALL BE IN ACCORDANCE WITH MUNICIPAL, COUNTY, STATE, FEDERAL, GO95 AND G0128 STANDARDS AND REGULATIONS.

FEDERAL, 6095 AND GOTZE STANDARDS AND REGULATIONS.

CALL USA 48 HOURS PRIOR TO EXCAVATING AT (800) 422–4133.

ALL LANDSCAPING TO BE RESTORED TO ORIGINAL CONDITION OR BETTER.

ALL EQUIPMENT TO BE BONDED.

7. METERING CABINET REQUIRES 3'[.914M] CLEARANCE AT DOOR OPENING. 8. CAULK CABINET BASE AT PAD.

STANDARD GROUNDING NOTES:

5/8"x8'[.016x2.44M] ROD, CAD WELD BELOW GRADE #6 GROUND AND BOND WIRE

. WOOD MOLDING, STAPLED EVERY 3'[.914M] AND AT EACH END

3. PLACE 3 #10GA WIRES FROM BREAKER TO METER BOX.

STANDARD CONDUIT NOTES:

1. FOR UNDERGROUND USE SCHEDULE 40.
2. FOR RISERS USE SCHEDULE 80.
3. PLACE 2"[.051M] GALVANIZED STEEL CONDUIT FOR ANY CONDUIT UNDER 3"[.076M], STUB UP 10"[3.04M] THEN CONVERT TO SCHEDULE 80.
4. CONVERT 4"[.102M] CARRIER CONDUIT TO 3"[.076M] AT BASE OF POLE.
5. GC TO STUB UP POLE 10"[3.04M] w/3" POWER CONDUIT, POWER CO. TO CONVERT TROM 3"[.076M] SCH. 80 TO 2"[.051M] SCH. 80 FROM TOP OF STUB UP.

6. ALL CONDUIT WILL BE MAN DRILLED AND EQUIPPED WITH 3/8"[.010M] PULL ROPE.

MAINTAIN 40"[1.02M] MINIMUM COVER FOR ELECTRICAL CONDUIT.
 MAINTAIN 30"[1.762M] MINIMUM COVER FOR COMMUNICATIONS CONDUIT.
 SAND SHADING MINIMUM 1"[.025M] UNDER CONDUITS, AND 6"[.152M] COVERING ON TOP REQUIRED.
 ALL ELECTRICAL SERVICE CONDUITS FROM POWER COMPANY, WHETHER FROM POLES, TRANSFORMERS, OR OTHER LOCATIONS; WILL BE SLURRY PARCYELI LOCATIONS;

5. IN STREET SLURRY TO GRADE AND MILL DOWN 1-1/2"[.038M] FOR AC CAP.
6. IN DIRT SLURRY 18"[.457M] FROM GRADE, AND FILL WITH 95% COMPACTION NATIVE SOLI FOR BALANCE.

PLACE WARNING TAPE IN TRENCH 12"[.305M] ABOVE ALL CONDUITS AND #18 WARNING TAPE ABOVE GROUND RING.

. NO BOLT THREADS TO PROTRUDE MORE THAN 1-1/2"[.038M]. . FILL ALL HOLES LEFT IN POLE FROM REARRANGEMENT OF CLIMBERS.

ALL CLIMB STEPS NEXT TO CONDUIT SHALL HAVE EXTENDED STEPS.

4. CABLE NOT TO IMPEDE 15"[.381M] CLEAR SPACE OFF POLE FACE

4. CABLE NOT IMPEDE 15 [.381M] CLEAR SPACE OF POLE FACE (12:00).

5. 90° SHORT SWEEPS UNDER ANTENNA ARM. ALL CABLES MUST ONLY TRANSITION ON THE INSIDE OR BOTTOM OF ARMS (NO CABLE ON TOP OF ARMS).

6. USE CABLE CLAMPS TO SECURE CABLE TO ARMS; PLACE 2"[.051M] CARRIER CABLE ID TAGS ON BOTH SIDES OF ARMS.

7. USE 90° CONNECTOR AT CABLE CONNECTION TO ANTENNAS.

8. PLACE GPS ON ARM WITH SOUTHERN SKY EXPOSURE AT MINIMUM.

S'[1.83M] FROM TRANSMIT ANTENNA, WHICH IS 24"[.61M] AWAY FROM CENTER OF POLE. USE 1/2"[.013M] CABLE ON ANTENNAS UNLESS OTHERWISE
 SPECIFIED

FILL VOID AROUND CABLES AT CONDUIT OPENING WITH FOAM SEALANT TO PREVENT WATER INTRUSION.

TOTAL	77.48 SQ. FT.
TOP GRADE	24'-3"
BOTTOM GRADE	19'-11"
METER/BREAKER AREA TOTAL	4.33 SQ. FT.
TOP GRADE	8'-0"
BOTTOM GRADE	7'-0"
BATTERY BACK-UP AREA TOTAL	16.25 SQ. FT.
TOP GRADE	11'-8"
BOTTOM GRADE	9'-6"
DELTA DECK AREA TOTAL	10.74 SQ. FT.
TOP GRADE	14'-7"
BOTTOM GRADE	12'-5"
DELTA DECK (FUT.) AREA TOTAL	10.74 SQ. FT.
TOP GRADE	17'-6"
BOTTOM GRADE	15'-4"
EXT. RISER SIZE	4"ø
EXT. RISER LENGTH	15'-1"
EXT. RISER BTM GRADE	14'-5"
PWR RISER SIZE	1"ø
PWR RISER LENGTH	10'-0"
PWR RISER BTM GRADE	9'-0"

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LOADING AND ANTENNA CABLE SCHEDULES

ANTENNA SECTOR


AI PHA

SECTOR

AZIMUTH

TOP OF FOOTING
TOP OF PLATE (PARAPET)
TOP OF STEEL (SLAB)
TOP OF WALL
TYPICAL
UNDER GROUND
UNDERWRITERS LABORATORY
UNLESS NOTED OTHERWISE
VERIFY IN FIELD
WIDE(WIDTH)
WITH

WOOD

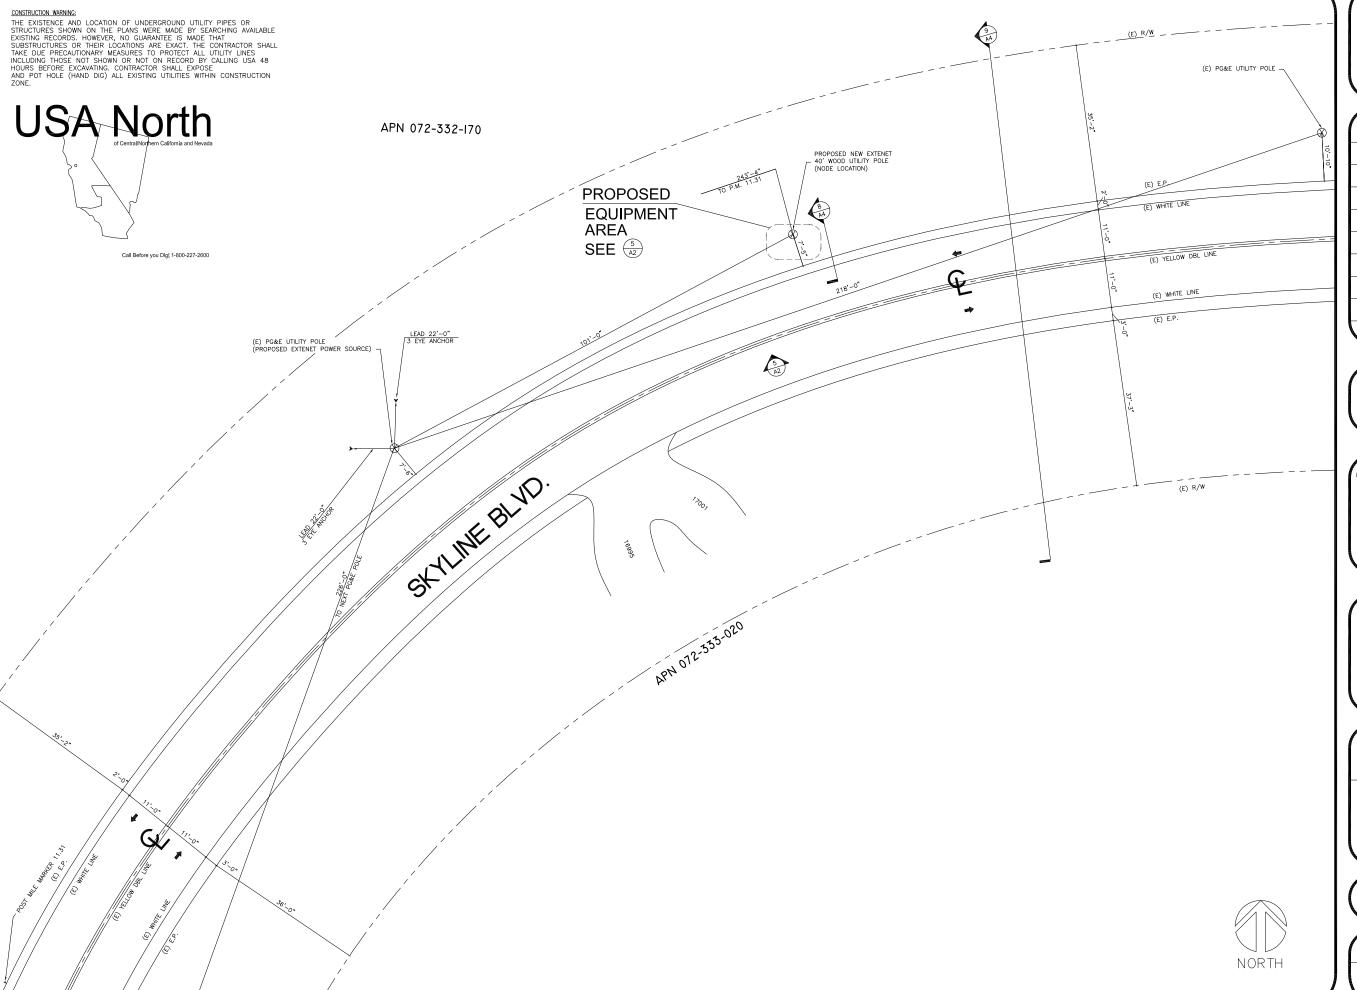

SITE PLAN



3030 WARRENVILLE RD. SUITE 340 LISLE, IL 60532 www.extenet.com

		Non-
REV.	DATE	DESCRIPTION
3	02/08/10	REVISION PER CALTRANS COMMENTS
2	01/25/10	REVISION PER PG&E POWER DESIGN
	11/11/09	REVISION PER EXTENET REQUESTED RAD CENTER CHANGE

CURRENT ISSUE DATE:

02/08/10

PLANS PREPARED BY:



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LICENSURE:

SITE NO.:

HWY8435-015C

SITE NAME & ADDRESS:

HIGHWAY 84/35 NETWORK NODE 15C

16995 SKYLINE BLVD (ACROSS STREET) WOODSIDE, CA 94062

SHEET 1

SITE PLAN

DRAWN BY.	CHECKED BY:	APPROVED BY
Va	AF	KM
SHEET NUMBER		REVISION:

EXTENET MAKE-READY

- 1. NSTALL 40, CLASS 2, DOUGLAS FIR UTILITY POLE, PER
- 2. FLUSH MOUNT 4 PANEL ANTENNAS TOP AT 32'-2" GRADE. SECOND SET 1' BELOW PER ELEVATION.
- STRING IN FIBER/POWER STRAND AND ATTACH AT
- 20'-0" GRADE W/ANCHOR GUY. PER FIBER DESIGN.
 4. INSTALL DELTA NODE RADIOS, BATTERY BACK-UP AND ELEC. ENCLOSURE AT 3:00 POSITION W/MIN. 4" SPACING FROM POLE.
- 5. INSTALL 4" PVC SCH. 40 COAX RISER AT 1:00


MAKE-READY NOTES

6. INSTALL 2" PVC SCH. 40 FIBER/PWR RISER AT 2:00 POSITION.

POWER MAKE-READY

- 1. STRING IN SECONDARY POWER FROM PG&E POLE APPROX. 101' WEST OF PROPOSED NODE POLE. (SEE SITE PLAN/POWER DESIGN)
- INSTALL TRANSFORMER AND SECONDARY POWER FOR
- SERVICE, PER PG&E DESIGN.
 3. INSTALL 1" PVC SCH. 80 RISER W/WEATHER HEAD AT 1:00 (QUAD 1) POSITION.
- 4. PROVIDE 120/240V, 3-WIRE, SINGLE PHASE 100 AMP SERVICE TO 1" PG&E RISER TO EXTENET METER BOX FROM SECONDARY POWER AT 33'-0" GRADE.

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CURRENT ISSUE DATE:

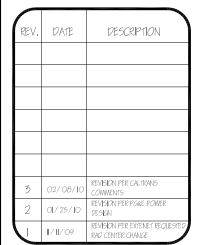SCALE: 4


CLIMB SPACE

FOC/EP

PLANS PREPARED BY



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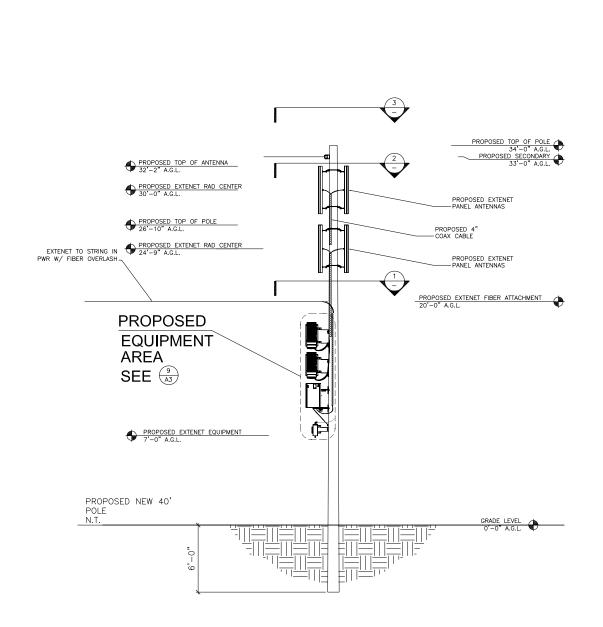
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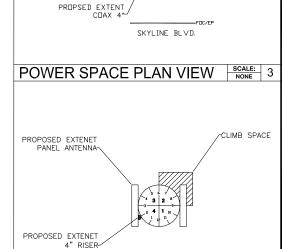
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HIGHWAY 84/35 NETWORK NODE 15C 16995 SKYLINE BLVD (ACROSS STREET) WOODSIDE, CA 94062

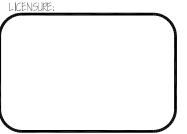ELEVATIONS & RISER DETAIL

KM SHEET NUMBER EVISION: 7 3






SKYLINE BLVD.

EXTENET ANTENNA PLAN VIEW SCALE: NONE 2

6 NOT USED


PROPOSED SECONDARY


PROPOSED EXTENET PWR/FIBER 2**

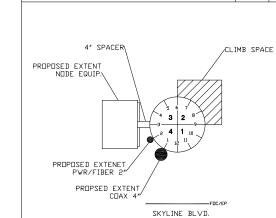

SCALE: 5 EQUIPMENT RISER DETAIL

NORTHWEST POLE ELEVATION

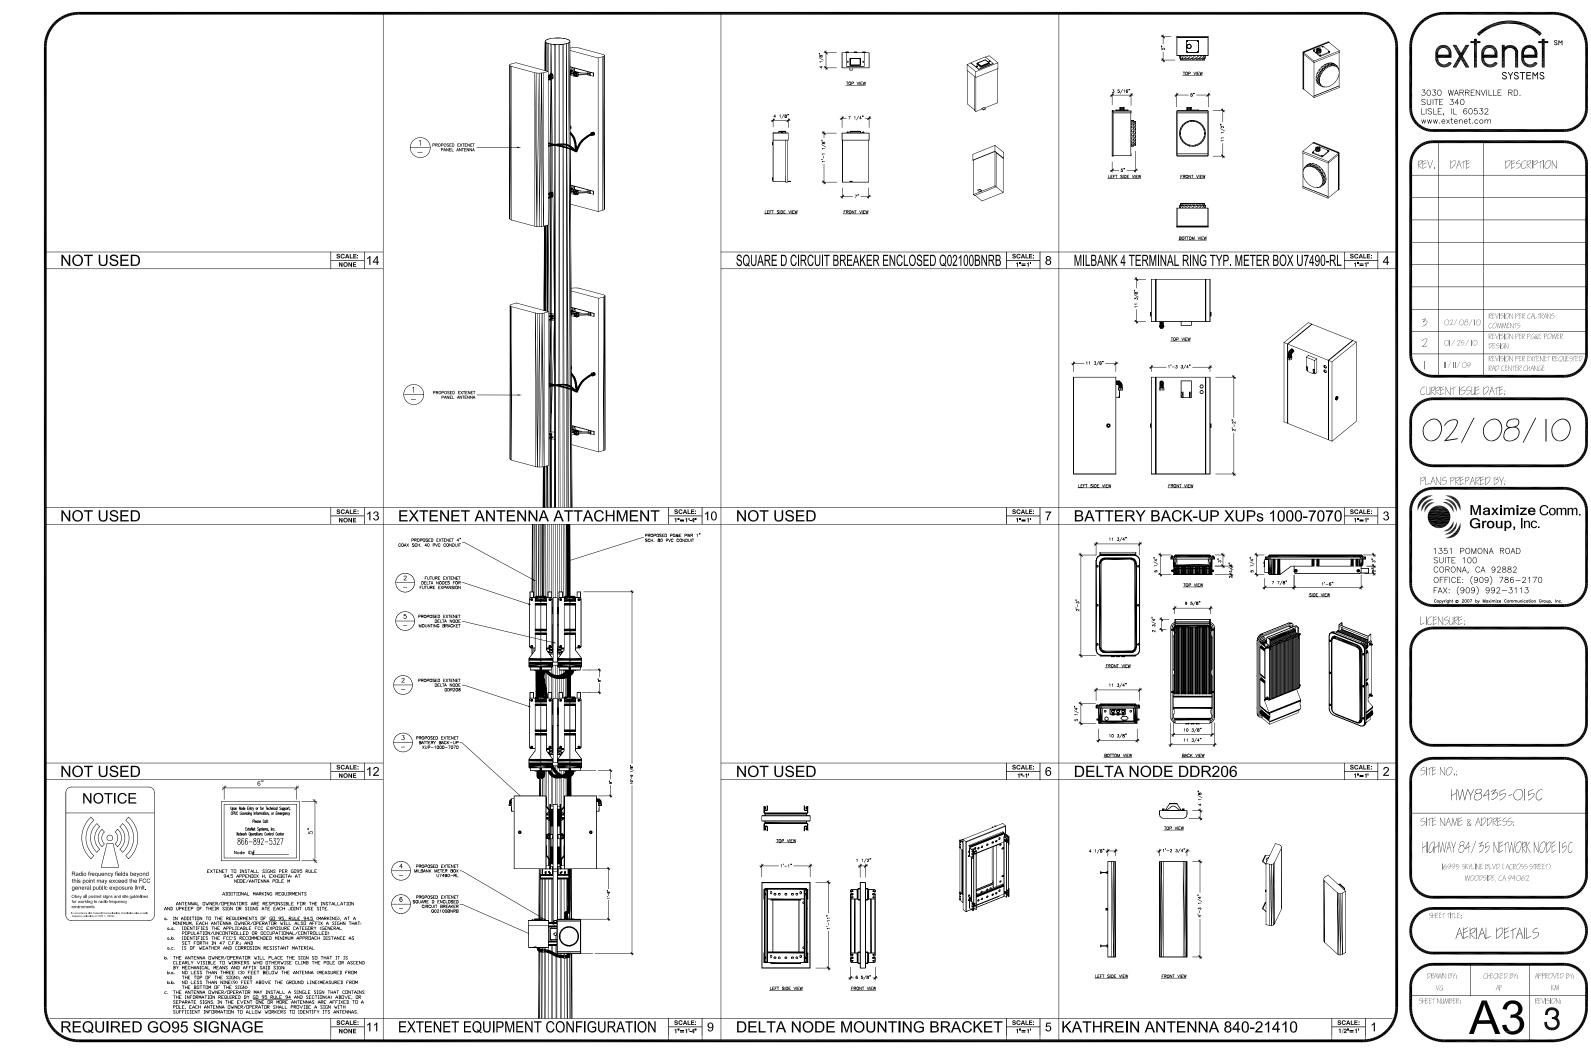


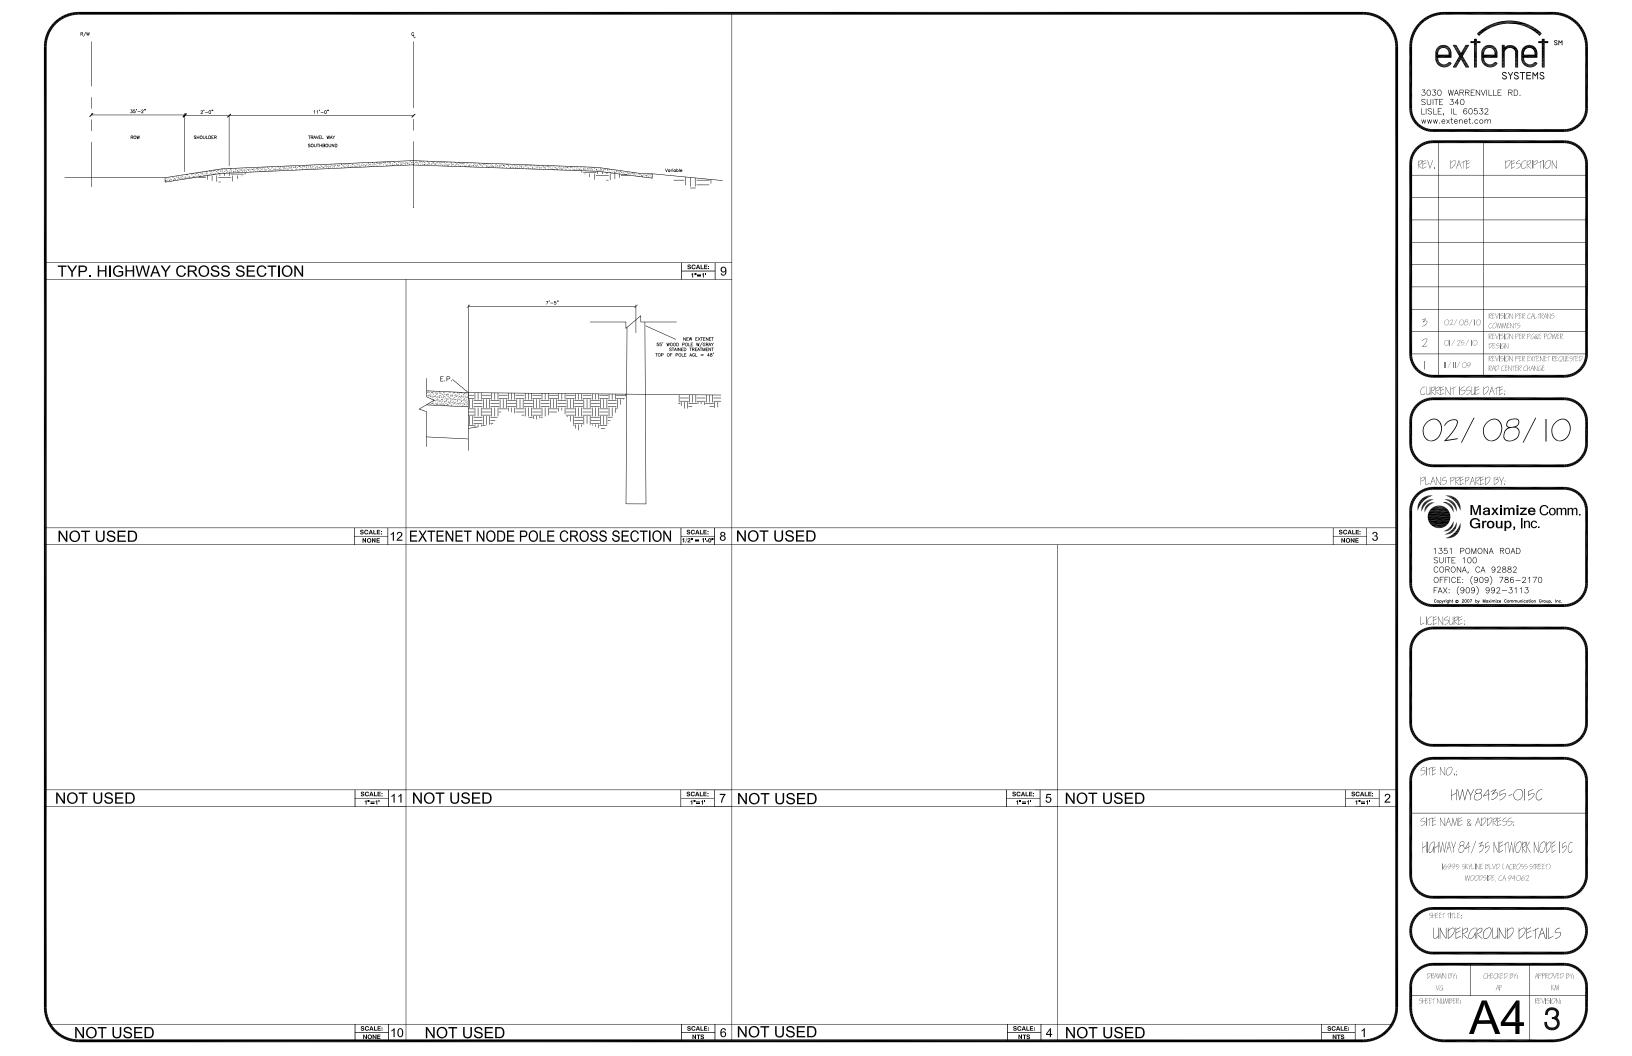



SYSTEMS

HWY 35 - PROJECT HWY8435 - 016B POST MILE MARKER 10.86 17130 SKYLINE BLVD. WOODSIDE, CA 94062

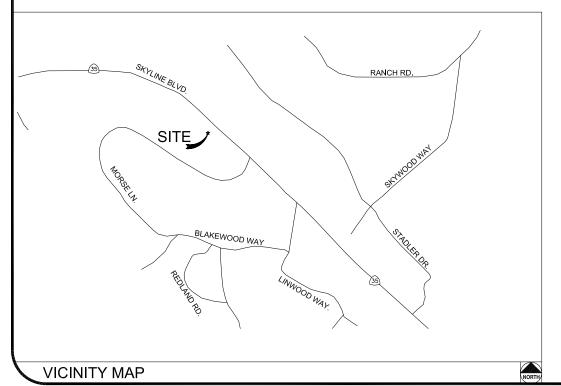

CLIENT

EXTENET SYSTEMS, INC. 3030 WARRENVILLE RD. SUITE 340 LISLE, IL 60532 CONTACT JEFF FRYE PHONE 480-626-1271 FAX 504-285-1603

EXTENET SYSTEMS, INC. 3030 WARRENVILLE RD. SUITE 340 LISLE, IL 60532 CONTACT JEFF FRYE PHONE 480-626-1271 FAX 504-285-1603

ENGINEERING FIRM/SURVEYING

COORDINATES

CODE COMPLIANCE:

ALL WORK AND MATERIALS SHALL BE PERFORMED & INSTALLED IN ACCORDANCE WITH THE CURRENT EDITIONS OF THE FOLLOWING CODES AS ADOPTED BY LOCAL GOVERNING AUTHORITIES AND LOCAL/CITY/COUNTY ORDINANCES:

1. CALIFORNIA ADMINISTRATIVE CODE (INCLUDING TITLE 24 &

- 3. 2007 CALIFORNIA ELECTRICAL CODE.
- 3. BUILDING OFFICIALS AND CODE ADMINISTRATORS (BOCA).
- 4. UNIFORM PLUMBING & MECHANICAL CODES.
- 5. ANSI/EIA-222-F LIFE SAFETY CODE
- 6. CALIFORNIA GENERAL ORDER 95, 128 & 165.

	SHELTINDEX				
	SHEET	DESCRIPTION			
T1 TITLE SHEET					
T2 GENERAL CONSTRUCTION NOTE & ANTENNA CABLE SCHEDULE					
	A1 SITE PLAN				
	A2	UTILITY POLE ELEVATIONS/RISER DETAILS			
	А3	AERIAL DETAILS			
	A4	UNDERGROUND DETAILS			
		I STATE OF THE STA			

CHEET INDEX



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NADO

HWY8435-016B


SITE NAME & ADDRESS:

HIGHWAY 84/35 NETWORK NODE OI6E

WOODSIDE CA 94062

TITLE SHEET

KM EVISION: 2

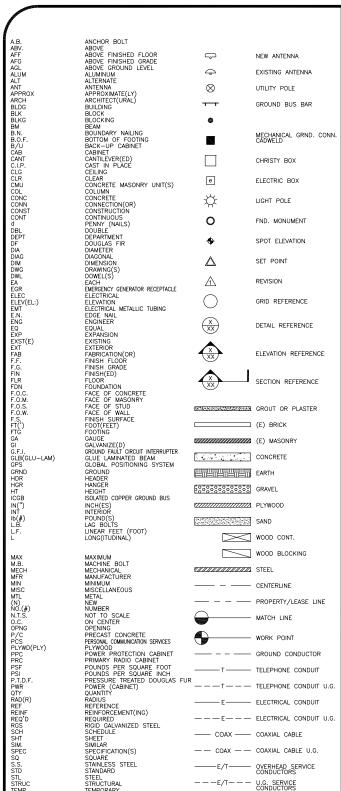

THICK(NESS)

WOOD

TOP OF PLATE (PARAPET)
TOP OF STEEL (SLAB)
TOP OF WALL

TOP OF WALL
TYPICAL
UNDER GROUND
UNDERWRITERS LABORATORY
UNLESS NOTED OTHERWISE
VERIFY IN FIELD
WIDE(WIDTH)
WITH

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CONSTRUCTION OF THIS PROJECT, INCLUDING THE SAFETY OF ALL PERSONS AND PROPERTIES. THAT THESE
REQUIREMENTS SHALL APPLY CONTINUOUSLY AND NOT BE LIMITED TO NORMAL WORKING HOURS AND CONDITIONS. ENGINEERS HARMLESS FROM ANY AND ALL LIABILITY, REAL OR ALLEGED IN CONNECTION WITH THE PERFORMANCE

2. PRIOR TO THE BEGINNING OF ANY CONSTRUCTION AND THROUGHOUT THE COURSE OF CONSTRUCTION WORK. THE CONTRACTOR SHALL FULLY COMPLY WITH "CALIFORNIA OCCUPATIONAL SAFETY AND HEALTH" ACT OF 1973 INCLUDING ALL REVISIONS AND AMENDMENTS THERETO.

3. ALL WORK SHALL CONFORM TO THE LATEST EDITIONS OF G095,128 AND THE STANDARD "SPECIFICATIONS FOR PUBLIC WORKS CONSTRUCTION" AS ADOPTED BY THE CITY, COUNTY OR STATE AS MODIFIED BY STANDARD PLANS

4. THE EXISTENCE AND LOCATION OF UTILITIES AND OTHER AGENCY'S FACILITIES AS SHOWN HERON ARE OBJUSTED BY A SEARCH OF AVAILABLE RECORDS. OTHER FACILITIES MAY EXIST. THE CONTRACTOR SHALL VERIFY PRIOR TO THE START OF CONSTRUCTION AND SHALL USE EXTREME CARE AND PROTECTIVE MEASURES TO OR AGENCY FACILITIES WITHIN THE LIMITS OF WORK, WHETHER THEY ARE SHOWN ON THIS PLAN OR NOT.

5. THE CONTRACTOR SHALL NOTIFY THE CITY, COUNTY OR STATE ENGINEER INSPECTION DEPARTMENT, AT LEAST TWO DAYS BEFORE START OF ANY WORK REQUIRING THEIR INVOLVEMENT.

6. THE CITY, COUNTY OR STATE SHALL SPECIFY THE EXPIRATION PERIOD OF THE PERMIT FOR THIS CONSTRUCTION PROJECT.

7. The minimum cover for all conduits placed underground shall be 36 inches to the finished grade at all times.

8. THE CONTRACTOR SHALL TUNNEL ALL CURB AND GUTTERS AND BORE ALL CONCRETE DRIVEWAYS AND WALKWAYS AT THE DIRECTION OF THE CITY, COUNTY OR STATE ENGINEER.

ALL A.C AND/OR CONCRETE PAVEMENT SHALL BE REPLACED AT THE DIRECTION OF THE CITY, COUNTY OR STATE ENGINEERS.

WORK, SHALL BE REPLANTED AND/OR REPLACED SO AS TO RESTORE THE WORK SITE TO ITS ORIGINAL CONDITION

11. THE CONTRACTOR WILL BE RESPONSIBLE FOR THE PROCESSING OF ALL APPLICANT PERMIT FORMS ALONG WITH THE REQUIRED LIABILITY INSURANCE FORMS. CLEARLY DEMONSTRATING THAT EXTENET, THE CITY, COUNTY OR STATE IS ALSO INSURED WITH THE REQUIRED LIABILITY INSURANCE IN THE AMOUNT OF \$1,000,000.00 FOR THIS

12. VAULTS, PEDESTALS, CONDUITS AND OTHER TYPES OF SUBSTRUCTURE ARE EITHER SPECIFIED ON THIS PLAN OR WILL BE SPECIFIED BY THE CONSTRUCTION ENGINEER. ANY AND ALL DEVIATIONS FROM THE SPECIFIED TYPES OF MATERIAL MUST BE APPROVED BY THE SYSTEM ENGINEER, IN WRITING BEFORE INSTALLATION THEREOF.

13. THE CONTRACTOR SHALL VERIFY THE LOCATION OF ALL EXISTING UTILITIES IN INCLUDING SEWER LATERALS & WATER SERVICES TO INDIVIDUAL LOTS BOTH VERTICAL AND HORIZONTAL PRIOR TO COMMENCING IMPROVEMENT

14. CONTRACTOR SHALL MAKE EXPLORATION EXCAVATIONS AND LOCATE EXISTING FACILITIES SUFFICIENTLY AHEAD OF CONSTRUCTION TO PERMIT REVISIONS TO PLANS IF REVISION IS NECESSARY BECAUSE OF LOCATION OF

15. THE LOCATIONS OF ALL EXISTING UTILITIES SHOWN ON THESE PLANS ARE FROM EXISTING RECORDS AND CORROBORATED, WHERE POSSIBLE, WITH FIELD TIES. THE CONTRACTOR IS RESPONSIBLE FOR CONFIRMINT LOCATIONS SHOWN, BOTH HORIZONIAL AND VERTICALLY. PRIOR TO CONSTRUCTION, IF EXISTING LOCATIONS WAR SUBSTANTIALLY FROM THE PLANS. THE ENGINEER SHOULD BE NOTIFIED TO MAKE ANY CONSTRUCTION CHANGES

EROSION AND SEDIMENT CONTROL NOTES

TEMPORARY EROSION/SEDIMENT CONTROL PRIOR TO COMPLETION OF FINAL IMPROVEMENTS, SHALL BE PERFORMED BY THE CONTRACTOR OR QUALIFIED PERSON AS INDICATED BELOW:

1. ALL REQUIREMENTS OF THE CITY, COUNTY AND STATE "STORM WATER STANDARDS" MUST BE INCORPORATED INTO THE DESIGN AND CONSTRUCTION OF THE PROPOSED GRADING/IMPROVMENTS CONSISTENT WITH THE APPROVED STORM WATER POLLUTION PREVENTION PLAN (SWPPP), WATER QUALITY TECHNICAL REPORT (WQTR), AND/OR WATER POLLUTION CONTROL PLAN (WPCP).

2. FOR STORM DRAIN INLETS, PROVIDE A GRAVEL BAG SILT BASIN IMMEDIATELY UPSTREAM OF INLET AS INDICATED ON DETAILS.

3. FOR INLETS LOCATED AT SUMPS ADJACENT TO TOP OF SLOPES. THE CONTRACTOR SHALL ENSURE THAT WATER DRAINING TO THE SUMP IS DIRECTED INTO THE INLET AND THAT A MINIMUM OF 1.00° FREEBOARD EXISTS AND IS MAINTAINED ABOVE THE TOP OF THE INLET. IF FREEBOARD IS NOT PROVIDED BY GRADING SHOWN ON

4. THE CONTRACTOR OR QUALIFIED PERSON SHALL BE RESPONSIBLE FOR CLEANUP OF SILT AND MUD ON ADJACENT STREET(S) AND STORM DRAIN SYSTEM DUE TO CONSTRUCTION ACTIVITY.

5. THE CONTRACTOR OR QUALIFIED PERSON SHALL CHECK AND MAINTAIN ALL LINED AND UNLINED DITCHES AFTER EACH RAINFALL.

6. THE CONTRACTOR SHALL REMOVE SILT AND DEBRIS AFTER EACH MAJOR RAINFALL

B. THE CONTRACTOR SHALL RESTORE ALL EROSION/SEDIMENT CONTROL DEVICES TO WORKING ORDER TO THE SATISFACTION OF THE CITY ENGINEER OF RESIDENT ENGINEER AFTER EACH RUN-OFF PRODUCING RAINFALL.

). THE CONTRACTOR SHALL INSTALL ADDITIONAL EROSION/SEDIMENT CONTROL MEASURES AS MAY BE REQUIRED BY THE RESIDENT ENGINEER DUE TO UNCOMPLETED GRADING OPERATIONS OR UNFORESEEN CIRCUMSTANCES,

10. THE CONTRACTOR SHALL BE RESPONSIBLE AND SHALL TAKE NECESSARY PRECAUTIONS TO PREVENT PUBLIC TRESPASS ONTO AREAS WHERE IMPOUNDED WATERS CREATE A HAZARDOUS CONDITION.

11. ALL EROSION/SEDIMENT CONTROL MEASURES PROVIDED PER THE APPROVED GRADING PLAN SHALL BE INCORPORATED HERON. ALL EROSION/SEDIMENT CONTROL FOR INTERIM CONDITIONS SHALL BE DONE TO THE SATISFACTION OF THE RESIDENT ENGINEER.

12. GRADED AREAS AROUND THE PROJECT PERIMETER MUST DRAIN AWAY FROM THE FACE OF THE SLOPE AT THE CONCLUSION OF EACH WORKING DAY.

13. ALL REMOVABLE PROTECTIVE DEVICES SHOWN SHALL BE IN PLACE AT THE END OF EACH WORKING DAY WHEN RAIN IS IMMINENT.

14. THE CONTRACTOR SHALL ONLY GRADE, INCLUDING CLEARING AND GRUBBING FOR THE AREAS FOR WHICH THE CONTRACTOR OR QUALIFIED PERSON CAN PROVIDE EROSION/SEDIMENT CONTROL MEASURES.

15. THE CONTRACTOR SHALL ARRANGE FOR WEEKLY MEETINGS DURING OCTOBER 1ST TO APRIL 30TH FOR PROJECT TEAM (GENERAL CONTRACTOR, QUALIFIED PERSON, EROSION CONTROL SUBCONTRACTOR IF AN, ENGINEER OF WORK, OWNER/DEVELOPER AND THE RESIDENT ENGINEER) TO EVALUATE THE ADEQUACY OF THE EROSION/SEDIMENT CONTROL MEASURE AND OTHER RELATED CONSTRUCTION ACTIVITIES.

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ı	REV.	DATE	DESCRIPTION
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		11/11/09	REVISION PER EXTENET REQUESTED RAD CENTER CHANGE



1351 POMONA ROAD SUITE 100 CORONA, CA 92882 OFFICE: (909) 786-2170 FAX: (909) 992-3113

2

GENERAL NOTES

1. 120/240 POWER REQUIRED FOR 3-WIRE SERVICE.
2. GC TO REMOVE/CLEAN ALL DEBRIS, NAILS, STAPLES, OR NON-USED VERTICALS OFF THE POLE.
3. ALL CONSTRUCTION SHALL BE IN ACCORDANCE WITH MUNICIPAL, COUNTY, STATE, FEDERAL, GO95 AND G0128 STANDARDS AND REQUILATIONS.
4. CALL USA 48 HOURS PRIOR TO EXCAVATING AT (800) 422-4133.
5. ALL LANDSCAPING TO BE RESTORED TO ORIGINAL CONDITION OR BETTER.
6. ALL EQUIPMENT TO BE BONDED.

Call Before you Dlg! 1-800-227-2600

USA North

7. METERING CABINET REQUIRES 3'[.914M] CLEARANCE AT DOOR OPENING. 8. CAULK CABINET BASE AT PAD.

STANDARD GROUNDING NOTES:

5/8"x8"[.016x2.44M] ROD, CAD WELD BELOW GRADE

#6 GROUND AND BOND WIRE . WOOD MOLDING, STAPLED EVERY 3'[.914M] AND AT EACH END . GROUNDS 3'[.914M] FROM POLE.

6. PLACE 3 #10GA WIRES FROM BREAKER TO METER BOX.

STANDARD CONDUIT NOTES:

1. FOR UNDERGROUND USE SCHEDULE 40.
2. FOR RISERS USE SCHEDULE 80.
3. PLACE 2"[.051M] GALVANIZED STEEL CONDUIT FOR ANY CONDUIT UNDER 3"[.076M], STUB UP 10"[3.04M] THEN CONVERT TO SCHEDULE 80.
4. CONVERT 4"[.102M] CARRIER CONDUIT TO 3"[.076M] AT BASE OF POLE.
5. GC TO STUB UP POLE 10"[3.04M] w/3" POWER CONDUIT, POWER CO. TO CONVERT TROM 3"[.076M] SCH. 80 TO 2"[.051M] SCH. 80 FROM TOP OF STUB UP.

ALL CONDUIT WILL BE MAN DRILLED AND EQUIPPED WITH 3/8"[.010M] PULL ROPE.

MAINTAIN 40"[1.02M] MINIMUM COVER FOR ELECTRICAL CONDUIT.
 MAINTAIN 30"[7.62M] MINIMUM COVER FOR COMMUNICATIONS CONDUIT.
 SAND SHADING MINIMUM 1"[0.025M] UNDER CONDUITS, AND 6"[1.152M] COVERING ON TOP REQUIRED.
 ALL ELECTRICAL SERVICE CONDUITS FROM POWER COMPANY, WHETHER FROM POLES, TRANSFORMERS, OR OTHER LOCATIONS; WILL BE SLURRY BACKELIES.

5. IN STREET SLURRY TO GRADE AND MILL DOWN 1-1/2"[.038M] FOR AC CAP. 6. IN DIRT SLURRY 18"[.457M] FROM GRADE, AND FILL WITH 95% COMPACTION NATIVE SOIL FOR BALANCE.

PLACE WARNING TAPE IN TRENCH 12"[.305M] ABOVE ALL CONDUITS AND #18 WARNING TAPE ABOVE GROUND RING.

. NO BOLT THREADS TO PROTRUDE MORE THAN 1-1/2"[.038M]. . FILL ALL HOLES LEFT IN POLE FROM REARRANGEMENT OF CLIMBERS.

ALL CLIMB STEPS NEXT TO CONDUIT SHALL HAVE EXTENDED STEPS.

4. CABLE NOT TO IMPEDE 15"[.381M] CLEAR SPACE OFF POLE FACE

4. CABLE NOT TO IMPEDE 151_ASTIM] CLEAR SPACE OFF POLE FACE (12:00).
5. 90' SHORT SWEEPS UNDER ANTENNA ARM. ALL CABLES MUST ONLY TRANSITION ON THE INSIDE OR BOTTOM OF ARMS (NO CABLE ON TOP OF ARMS).
6. USE CABLE CLAMPS TO SECURE CABLE TO ARMS; PLACE 2"[0.51 M] CARRIER CABLE ID TAGS ON BOTH SIDES OF ARMS.
7. USE 90' CONNECTOR AT CABLE CONNECTION TO ANTENNAS.
8. PLACE GPS ON ARM WITH SOUTHERN SYLEXPOSURE AT MINIMUM.

S'[1.83M] FROM TRANSMIT ANTENNA, WHICH IS 24"[.61M] AWAY FROM CENTER OF POLE.

9. USE 1/2"[.013M] CABLE ON ANTENNAS UNLESS OTHERWISE

10. FILL VOID AROUND CABLES AT CONDUIT OPENING WITH FOAM SEALANT TO PREVENT WATER INTRUSION.

ANTENNA/WOOD ARM AREA TOTAL	77.48 SQ. FT.	
TOP GRADE	26'-0"	
BOTTOM GRADE	22'-0"	
METER/BREAKER AREA TOTAL	4.33 SQ. FT.	
TOP GRADE	8'-0"	
BOTTOM GRADE	7'-0"	
BATTERY BACK-UP AREA TOTAL	16.25 SQ. FT.	
TOP GRADE	11'-8"	
BOTTOM GRADE	9'-6"	
DELTA DECK AREA TOTAL	10.74 SQ. FT.	
TOP GRADE	14'-7"	
BOTTOM GRADE	12'-5"	
DELTA DECK (FUT.) AREA TOTAL	10.74 SQ. FT.	
TOP GRADE	17'-6"	
BOTTOM GRADE	15'-4"	
EXT. RISER SIZE	4"-ø	
EXT. RISER LENGTH	14'-0"	
EXT. RISER BTM GRADE	16'-0"	
PWR RISER SIZE	1"-ø	
PWR RISER LENGTH	11'-0"	
PWR RISER BTM GRADE	8'-8"	

WIND LOADING INFORMATION

ANTENNA & CABLE SCHEDULE						
antenna Sector	AZIMUTH	ANTENNA MAKE / MODEL	COAXIAL CABLE LENGTH	CABLES PER SECTOR	CABLE SIZE	
SECTOR ALPHA	292*	KATHREIN 840 21410	33'-6"	2	1/2"	
SECTOR BETA	129°	KATHREIN 840 21410	33'-6"	2	1/2"	
SECTOR GAMMA						

NOTE: CONTRACTOR TO FIELD VERIFY CABLE LENGTHS PRIOR TO ORDERING, FABRICATION, OR INSTALLATION OF CABLES

HWY8435-016B

SITE NAME & ADDRESS:

HIGHWAY 84/35 NETWORK NODE OI6B


17130 SKYLINE BLVD. WOODSIDE, CA 94062

IENERAL NOTES & SCHEDULE

KM SHEET NUMBER EVISION: 2

ROW CONSTRUCTION GENERAL NOTES ABBREVIATION AND LEGEND

LOADING AND ANTENNA CABLE SCHEDULES

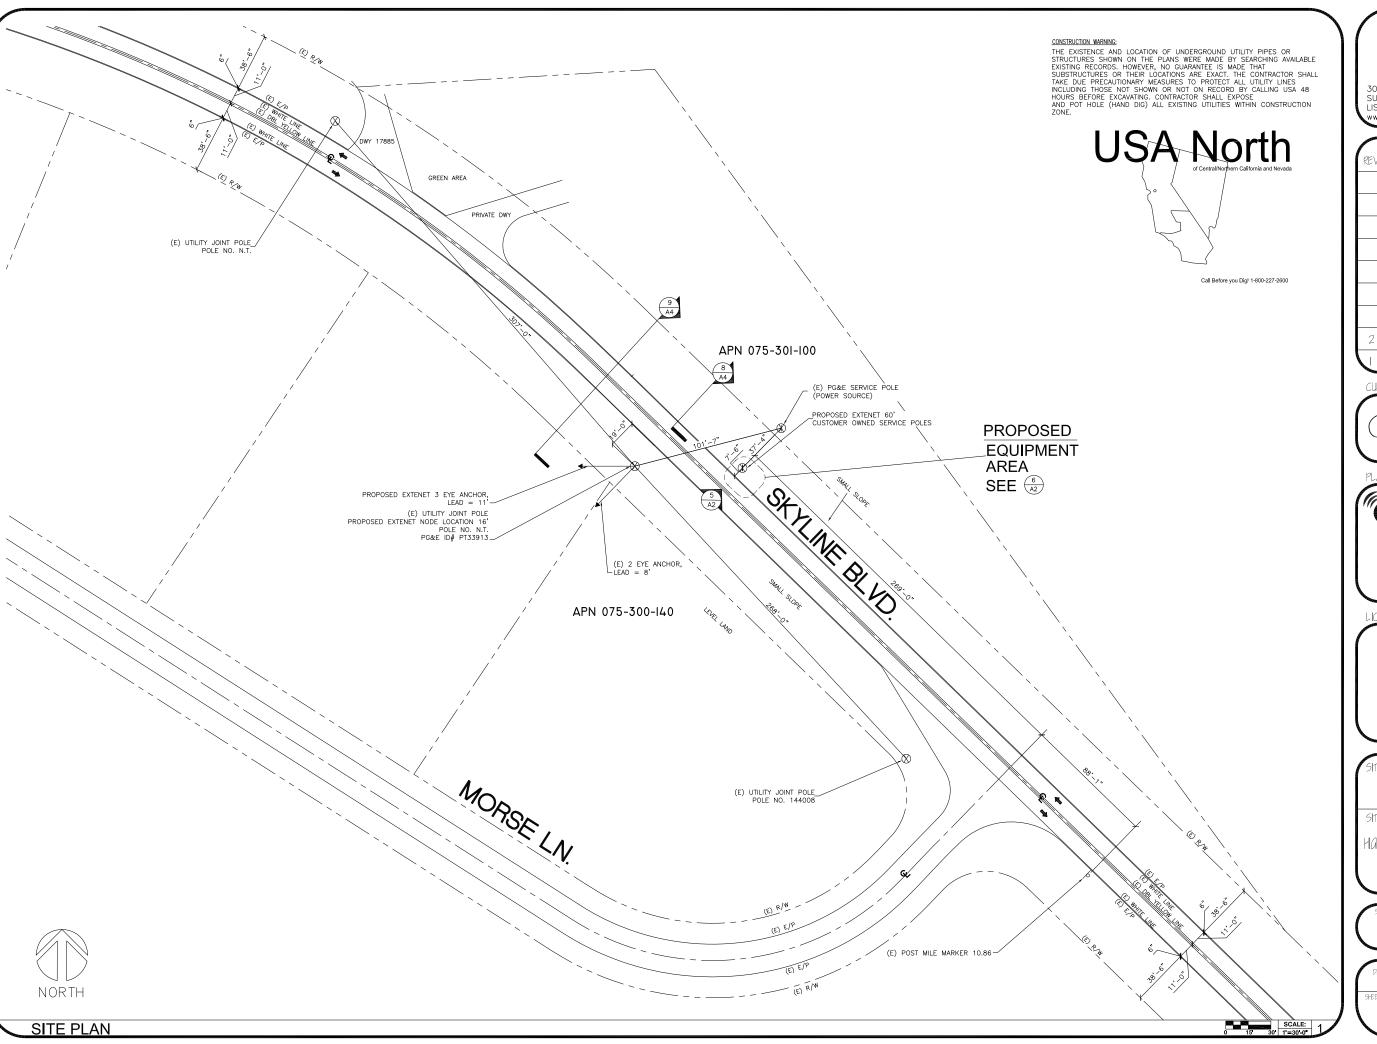



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LICENSURE:

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SITE NAME & ADDRESS:

HIGHWAY 84/35 NETWORK NODE OI6B

17130 SKYLINE BLVD. WOODSIDE, CA 94062

SITE PLAN

Men	VG SHEET NUMBER:	AF 1	KM REVISION:
/		$A \perp$	2 /

EXTENET MAKE-READY

- INSTALL 45', CLASS 2, DOUGLAS FIR UTILITY POLE, PER SITE PLAN.
- 2. FLUSH MOUNT 4 PANEL ANTENNAS TOP AT 32'-2" GRADE. SECOND SET 1' BELOW PER ELEVATION. 3. STRING IN FIBERR STRAND AND ATTACH AT 20'-7"
- GRADE W/ANCHOR GUY. PER FIBER DESIGN. 4. INSTALL DELTA NODE RADIOS, BATTERY BACK-UP AND METER/BREAKER AT 3:00 POSITION W/MIN. 4" SPACING
- 5. INSTALL 4" PVC SCH. 40 COAX RISER AT 1:00 POSITION.

MAKE-READY NOTES

NOT USED

POWER MAKE-READY

- STRING IN SECONDARY SERVICE DROP TO CUSTOMER
 OWNED SERVICE POLE AND ATTACH AT 52'-6" GRADE
 (IN QUAD 3) FROM EXISTING PG&E SERVICE POLE
 APPROX. 50' NORTHEAST OF PROPOSED CUSTOMER OWNED SERVICE POLE.
- 2. INSTALL 1" PVC SCH. 80 RISER W/WEATHER HEAD AT 4:00 (QUAD 3) POSITION.
- PROVIDE 120/240V, 3-WIRE, SINGLE PHASE 100 AMP SERVICE TO 1" PG&E RISER TO EXTENET METER BOX FROM SECONDARY SERVICE POINT.



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LICENSURE

PROPSED EXTENT

SCALE: 5 NODE POLE RISER DETAIL SCALE: 10 NONE 1

NODE POLE RISER DETAIL

NOT USED

HWY8435-016B

SITE NAME & ADDRESS:


HIGHWAY 84/35 NETWORK NODE OI6B

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ELEVATIONS & RISER DETAIL:


KM SHEET NUMBER: EVISION: 2

PROPOSED CUSTOMER OWNED SERVICE POLE

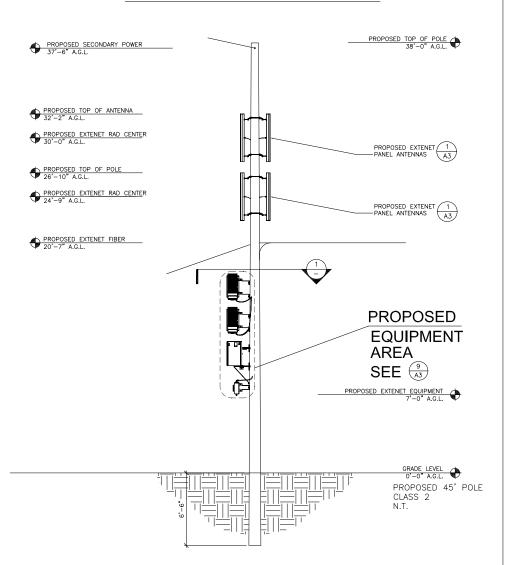

SOUTHWEST POLE ELEVATION

NOT USED

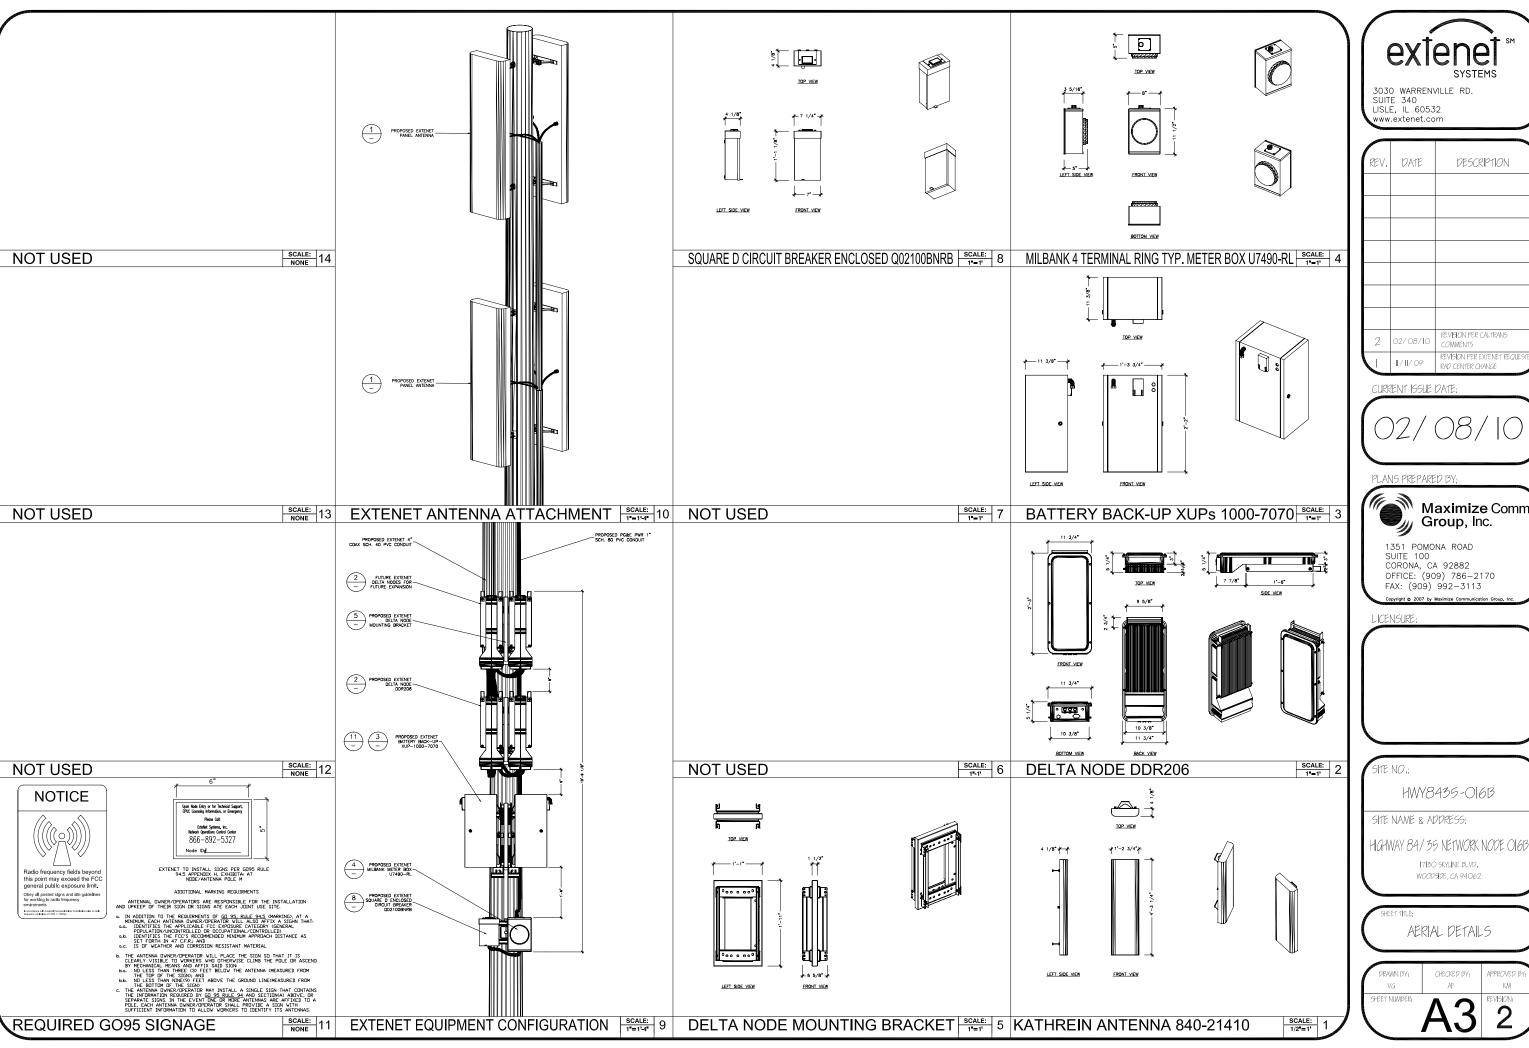



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17130 SKYLINE BLVD.

DRAWN BY: VG	CHECKED BY: AF	APPROVED BY:
SHEET NUMBER:	A3	2

