

Attachment 1

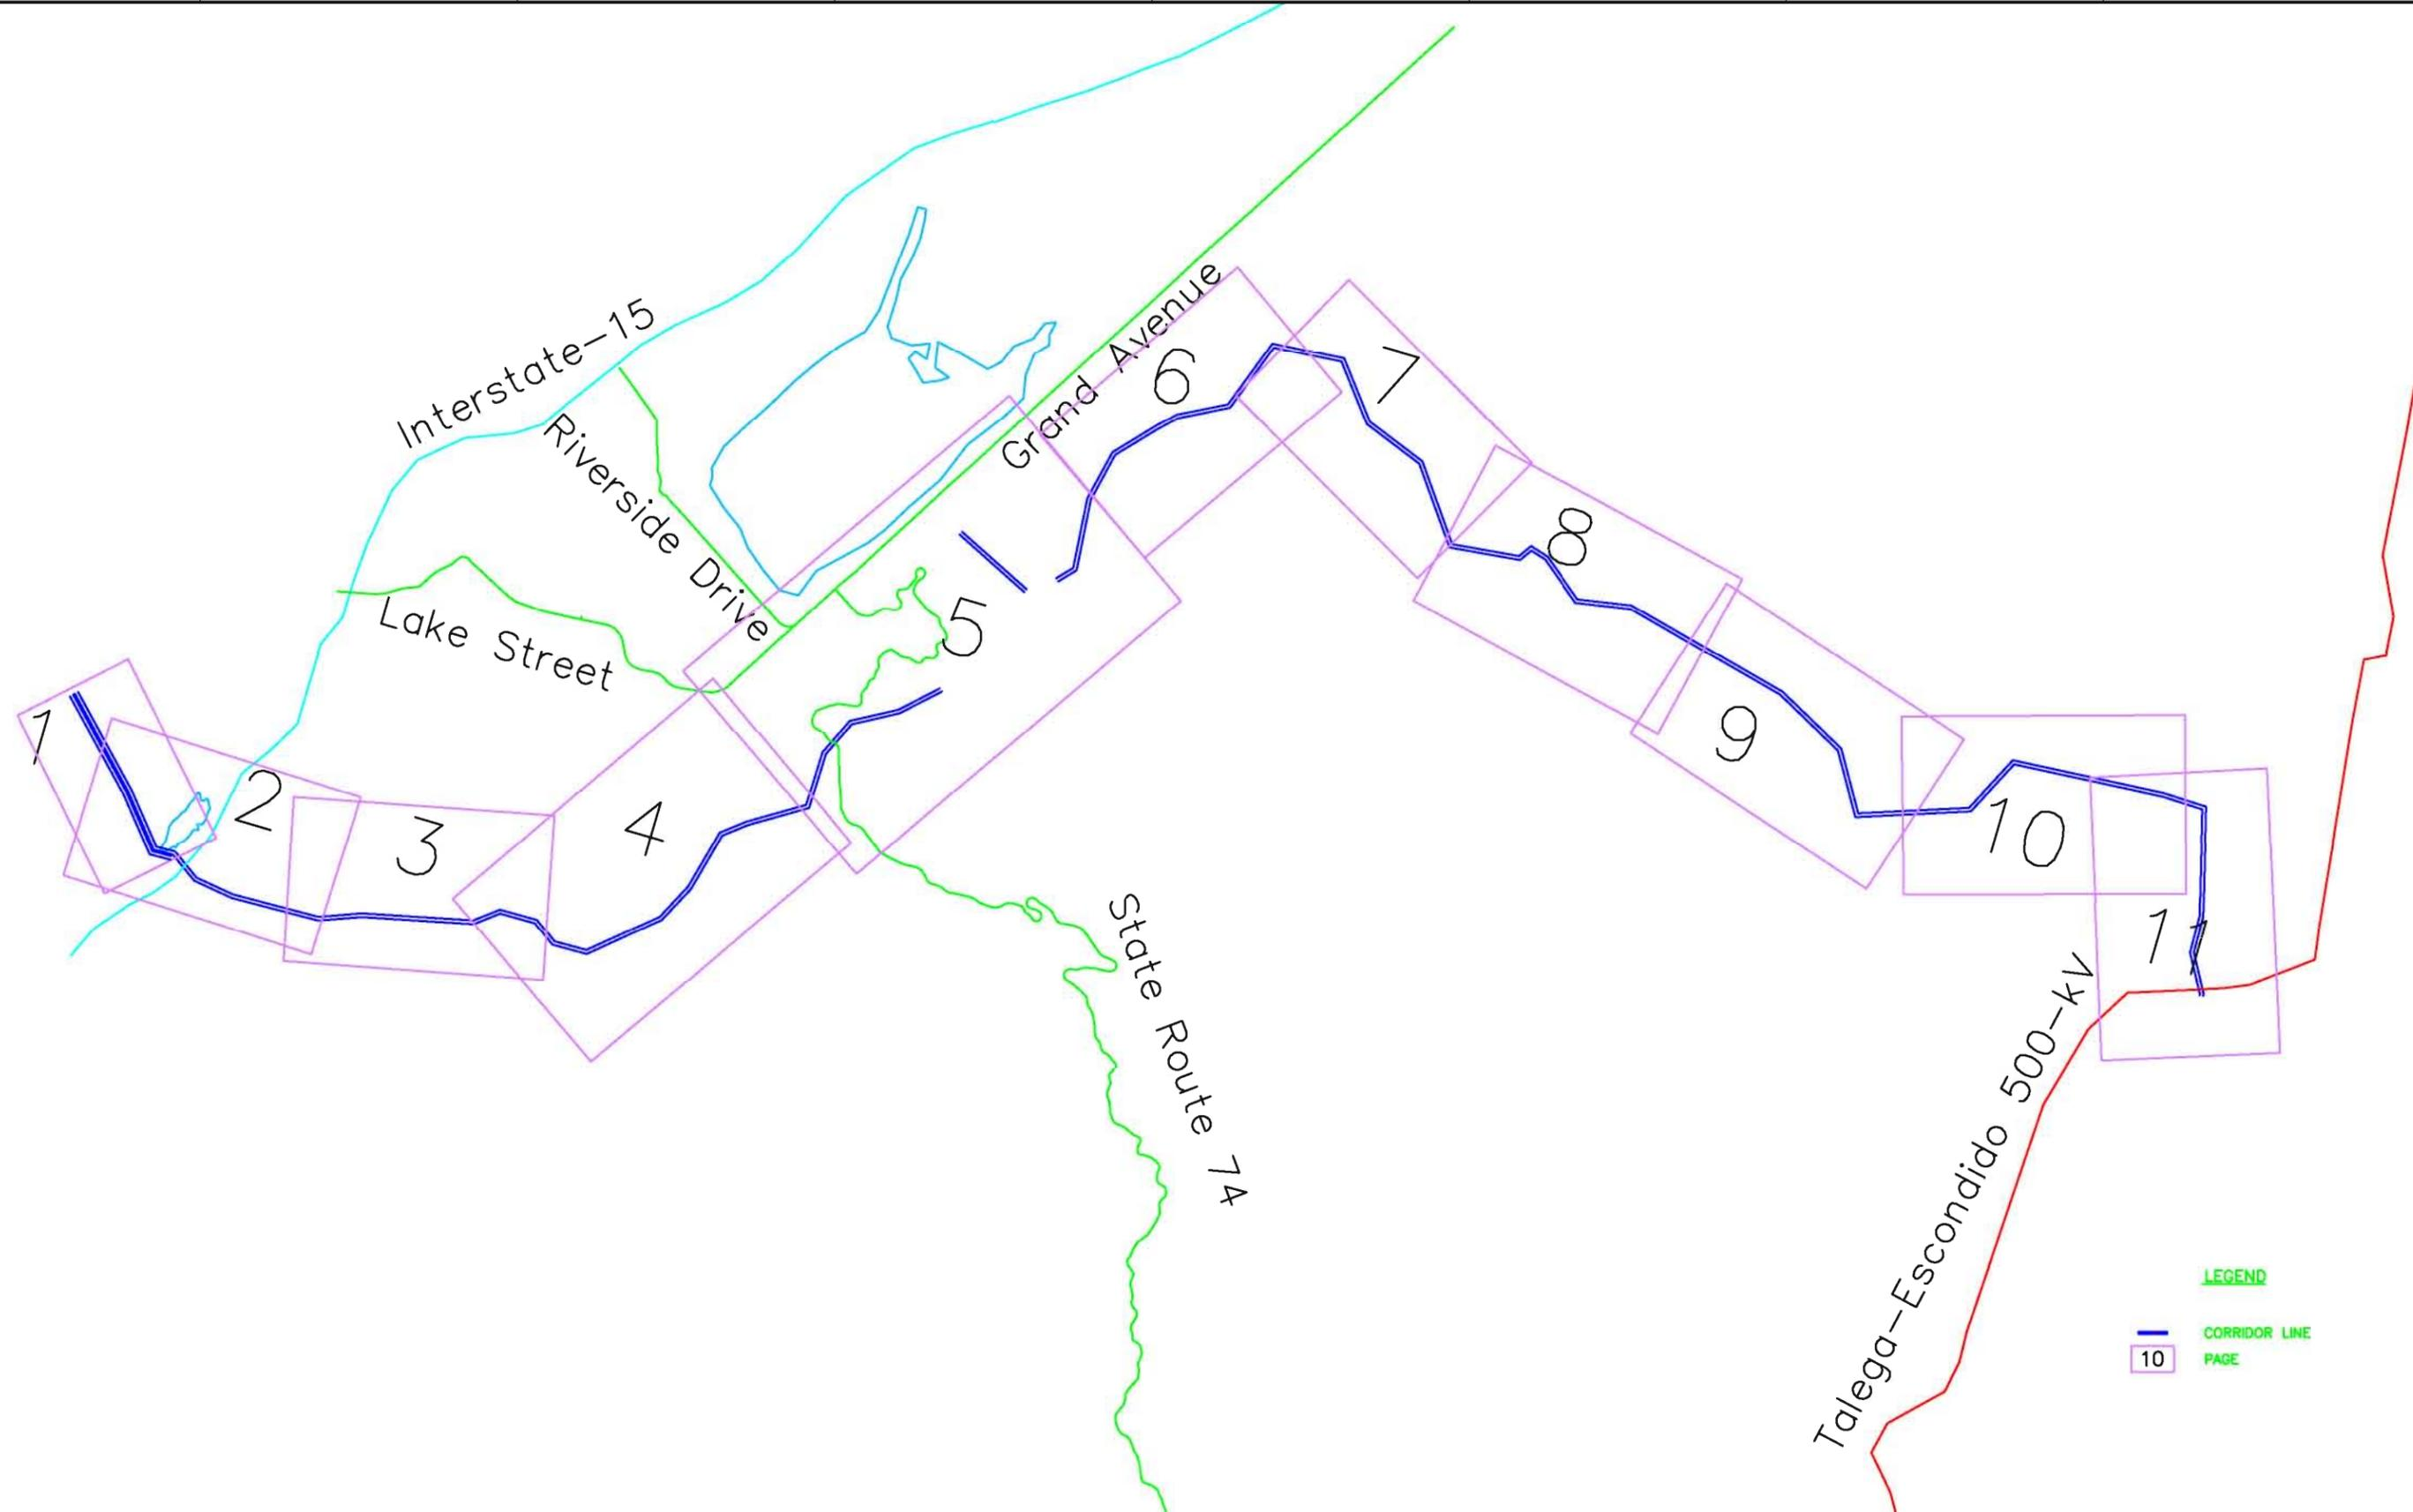
Tower Placement, Data Information Tables and Location Information

Clarification

Note on the symbols used, referenced in the “Legend,” on the following computer generated tower Plan and Profile Sheets:

1. “Spotting Constrain” is more accurately “Spotting Constraint” (added “t”). The final letter was omitted due to computer program limitations. Spotting constraints represent road crossings which were identified on aerial photos and assumed for tower spotting. Survey data for final line design should provide information of all obstacles where no structure should be spotted.
2. References to various color lines, and the lines themselves are computer embedded reference codes and should not be used for any purpose.

ELEC. REV. FILE: T-1
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C	08/04/08	ALTERNATIVE LOCATIONS	MM	MM	CS	CS								DRAWN BY M. MENDIETA
B	05/15/08	SPOTTING BASED ON LEAPS TOPO BASE	MM	MM	CS	CS								ENGR BY M. MENDIETA
A	04/11/08	FOR INFORMATION ONLY	MM	MM	CS	CS	D	06/10/08	DUE TO KEY MAP AND LEGENDS	MM	MM	CS	CS	CHECKED BY C. SUTOR
														APVD BY C. SUTOR

- CONCEPT
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- FOR CONSTRUCTION
- FOR RECORD

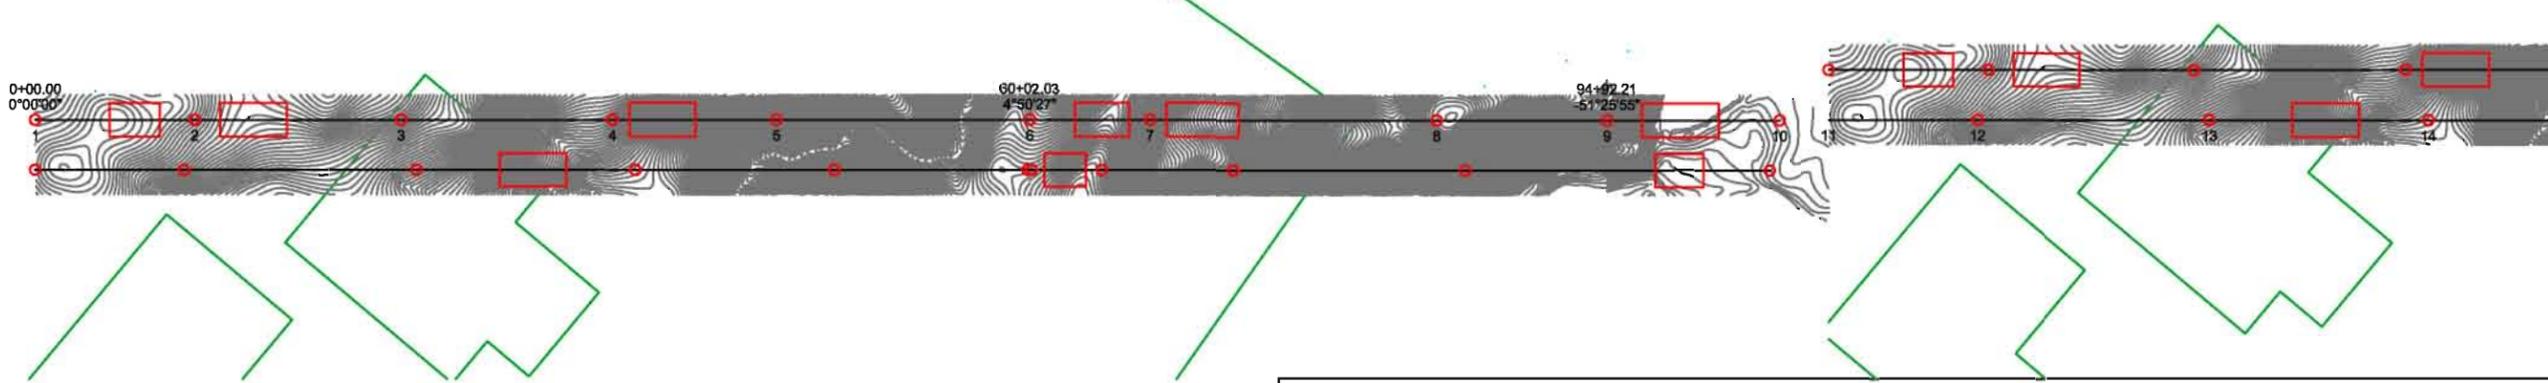
TITLE NEVADA HYDRO COMPANY LAKE ELSINORE ADVANCED PUMPED STORAGE PROJECT 500 kV TRANSMISSION LINE DESIGN KEY MAP			
SCALE AS SHOWN	DRAWING No. NHC-TLD-001	SHEET 1	CONT'D 2
		REV D	

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ELEM. REF. FILE: T-1
PLOT SCALE: 1:1

1 2 3 4 5 6 7 8



500.0 FT. HORIZ. SCALE
250.0 FT. VERT. SCALE

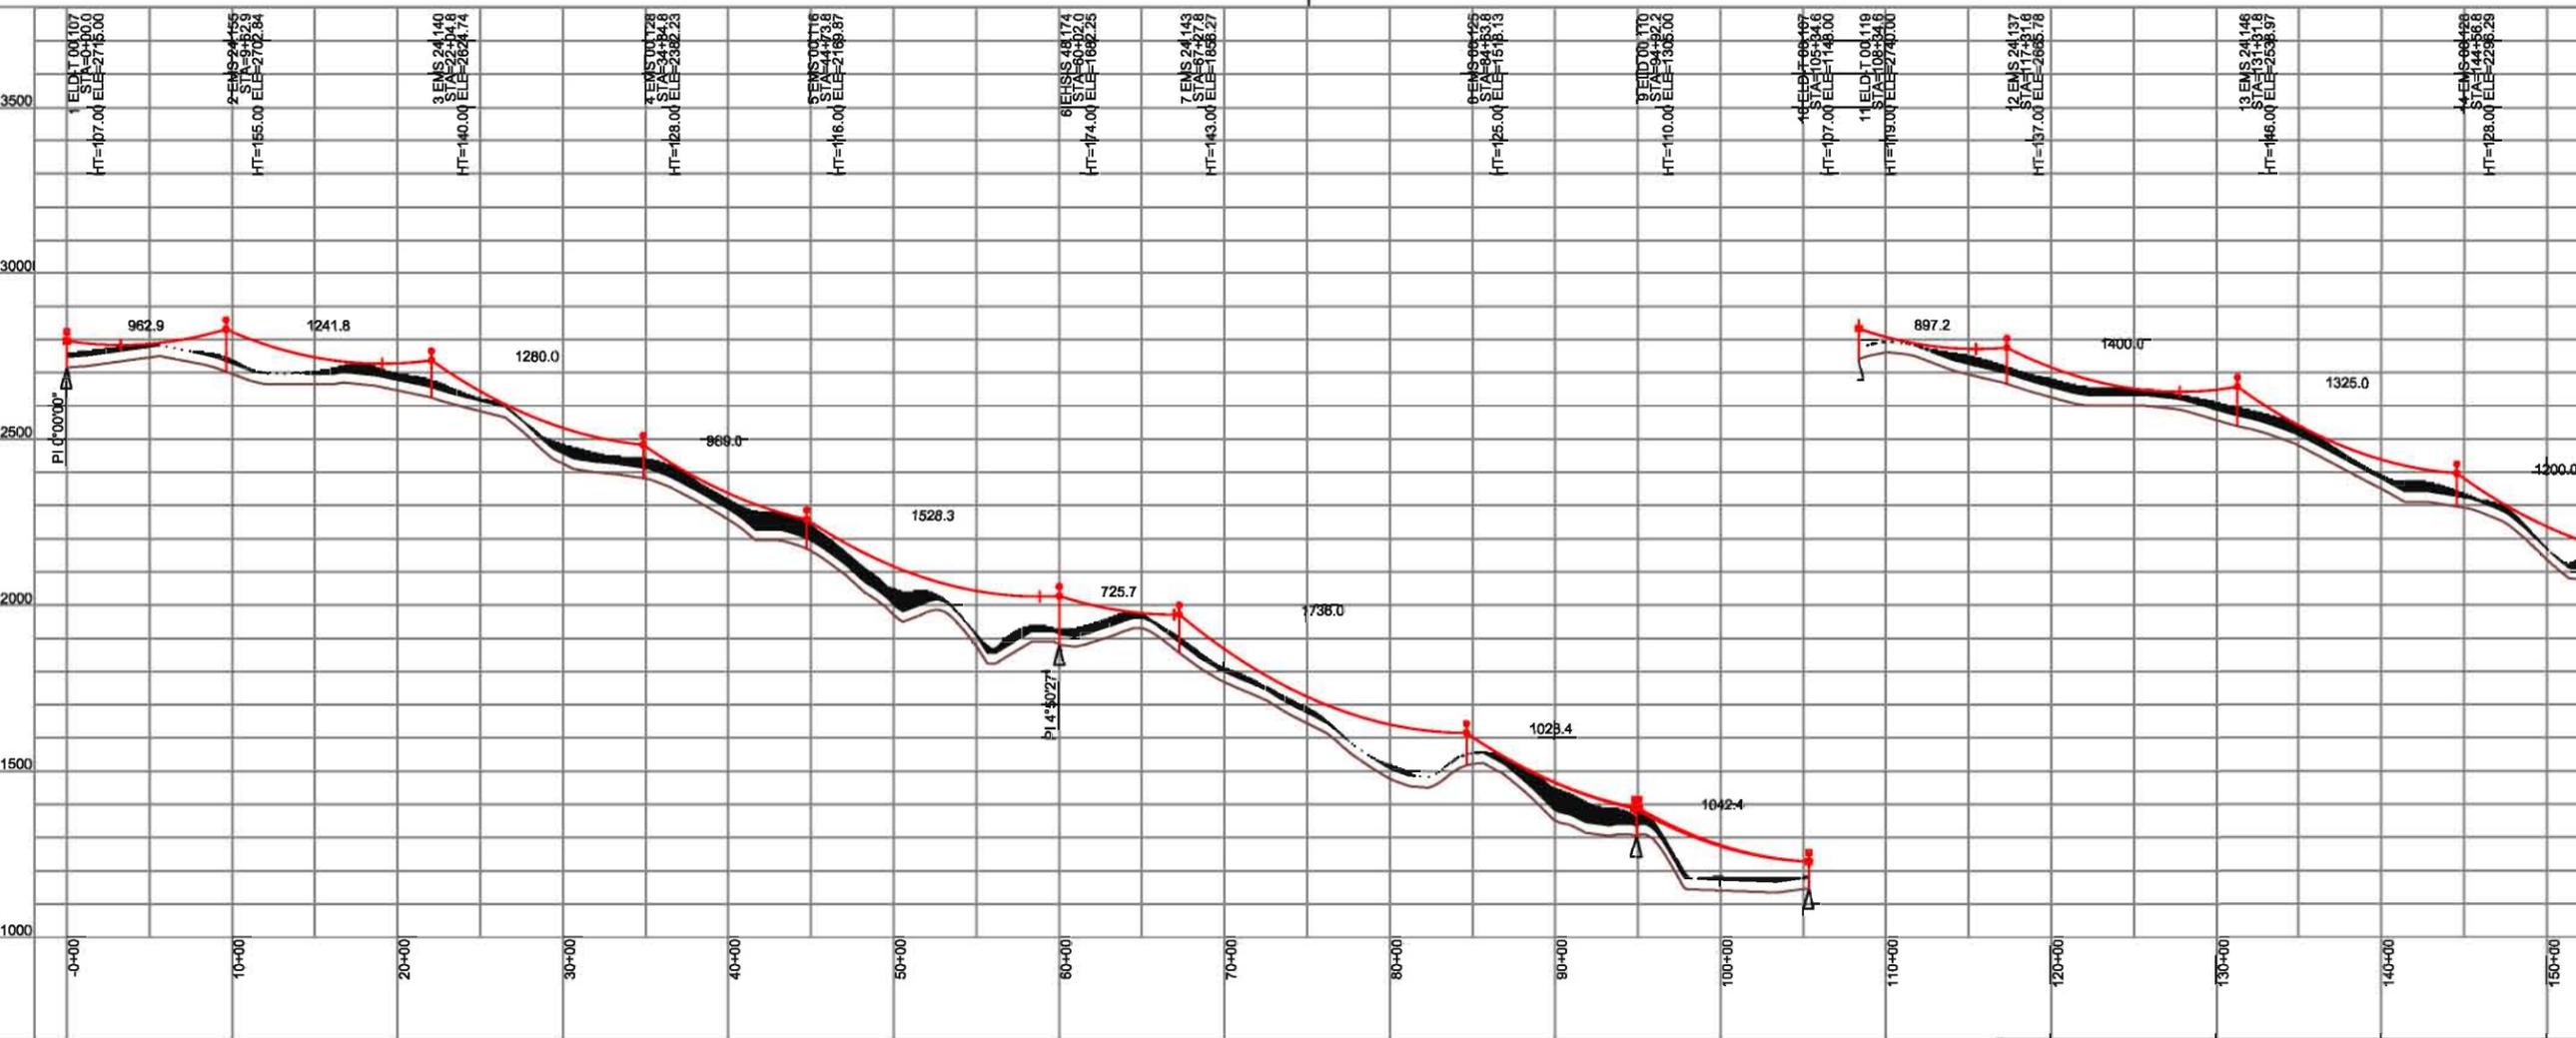
1 - 9, BLUEBIRD_ACSR_WIR, RULING SPAN 1284.5 FT., TENSION 17642 (LBS) AT 60 (DEG F) INITIAL
9 - 10, BLUEBIRD_ACSR_WIR, RULING SPAN 1030.0 FT., TENSION 20249 (LBS) AT 60 (DEG F) INITIAL
11 - 20, BLUEBIRD_ACSR_WIR, RULING SPAN 1164 (FT), TENSION 18273 (LBS) AT 60 (DEG F) INITIAL

LEAPS SAE R091008
9/10/2008
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LEGEND
 ○ STRUCTURE
 5 STRUCTURE NUMBER
 □ SPOTTING CONSTRAINT
 — qcb_fch83_gcs83

NORTH

NORTH



NO.	DATE	REVISION DESCRIPTION	DRWN BY	ENGR BY	CHECKED BY	APVD BY	No.	DATE	REVISION DESCRIPTION	DRWN BY	ENGR BY	CHECKED BY	APVD BY	APVD BY
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B	05/15/08	SPOTTING BASED ON LEAPS TOPO BASE	MM	MM	CS	CS								
A	04/11/08	FOR INFORMATION ONLY	MM	MM	CS	CS	D	09/10/08	DUE TO KEY MAP AND LEGENDS	MM	MM	CS	CS	C. SUTOR

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SAE TOWERS

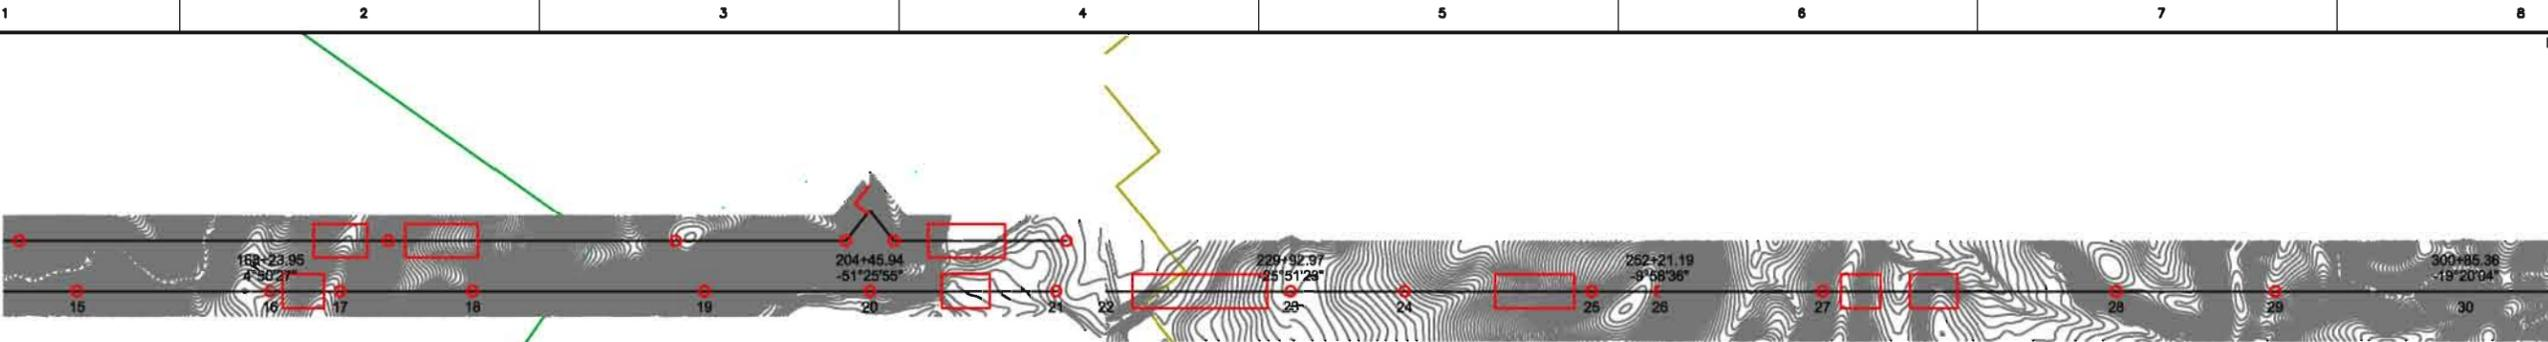
TITLE: NEVADA HYDRO COMPANY
LAKE ELSINORE ADVANCED PUMPED STORAGE PROJECT
500 KV TRANSMISSION LINE DESIGN
PLAN & PROFILE SHEET

SCALE: AS SHOWN DRAWING No. NHC-TLD-001 SHEET 2 CONT'D 3 REV D

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ELEM. REF. FILE: T-1
PLOT SCALE: 1:1

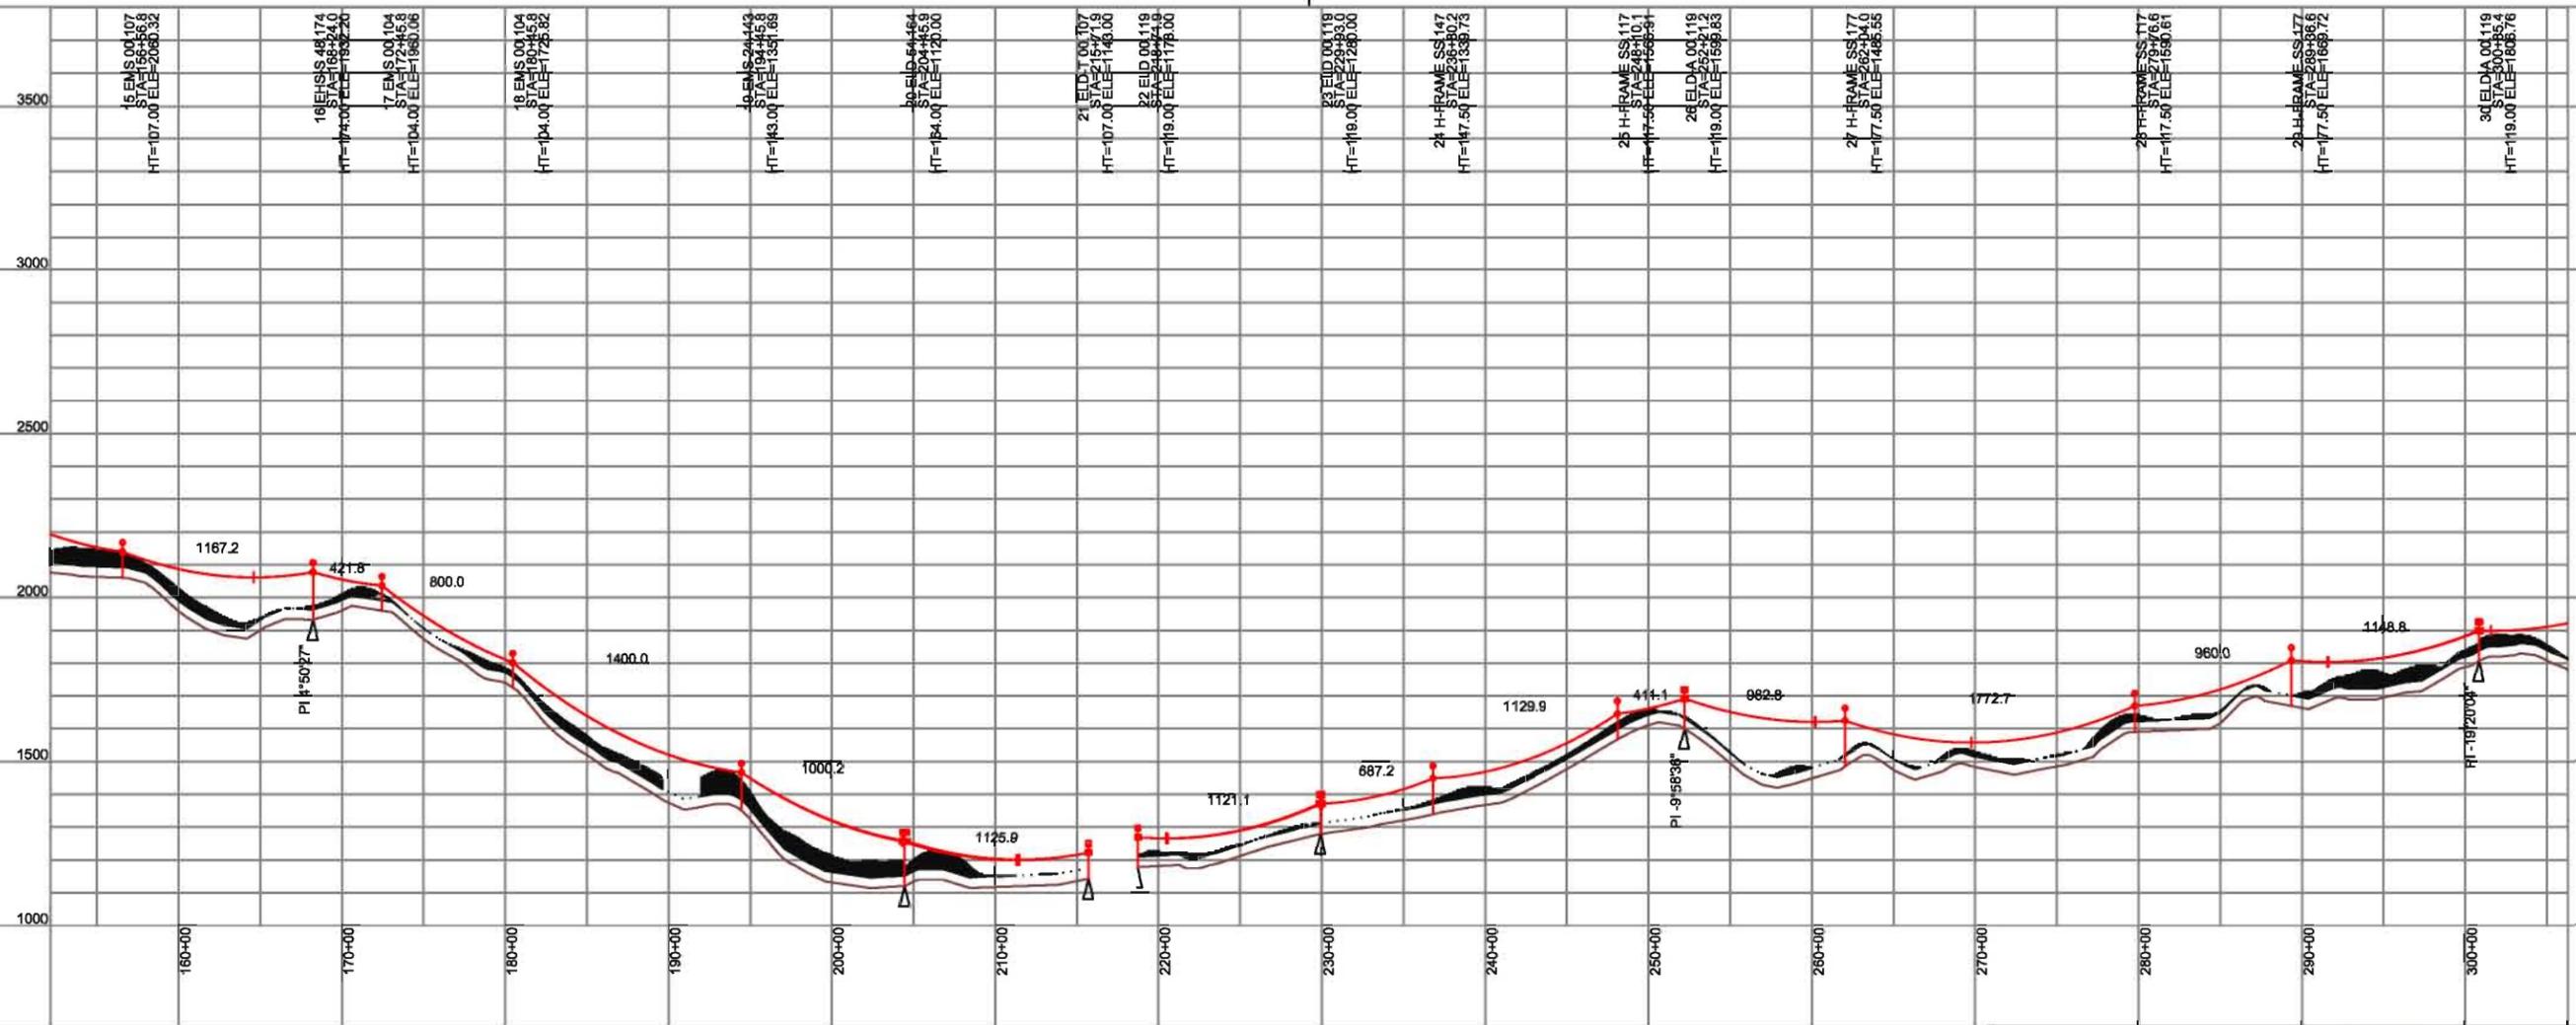


- LEGEND**
- STRUCTURE
 - 5 STRUCTURE NUMBER
 - SPOTTING CONSTRAINT
 - qcb_fch83_gcs83
 - cagn_pch27_g

LEAPS SAE R091008
9/10/2008
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HORIZ. SCALE 1"=500.0 FT.
VERT. SCALE 1"=250.0 FT.

15 BLUEBIRD_ACSR_WIP, RULING SPAN 1184 (FT), TENSION 18273 (LBS) AT 80 (DEG F) INITIAL
 16 BLUEBIRD_ACSR_WIP, RULING SPAN 1125 (FT), TENSION 20209 (LBS) AT 80 (DEG F) INITIAL
 17 BLUEBIRD_ACSR_WIP, RULING SPAN 1117 (FT), TENSION 19967 (LBS) AT 80 (DEG F) INITIAL
 18 BLUEBIRD_ACSR_WIP, RULING SPAN 897 (FT), TENSION 20534 (LBS) AT 80 (DEG F) INITIAL
 19 BLUEBIRD_ACSR_WIP, RULING SPAN 1359 (FT), TENSION 18347 (LBS) AT 80 (DEG F) INITIAL
 20 BLUEBIRD_ACSR_WIP, RULING SPAN 1654 (FT), TENSION 16359 (LBS) AT 80 (DEG F) INITIAL



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SAE TOWERS

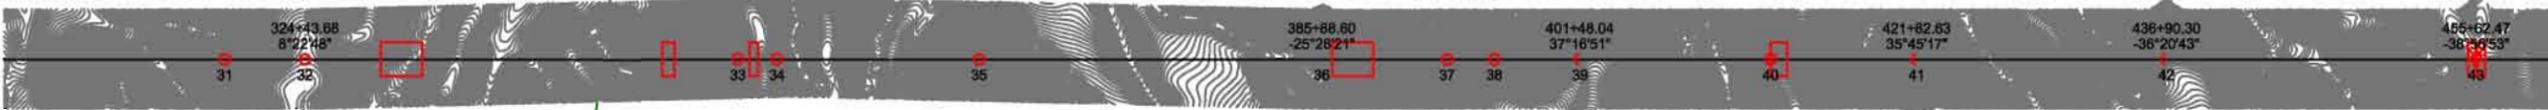
TITLE: NEVADA HYDRO COMPANY
LAKE ELSINORE ADVANCED PUMPED STORAGE PROJECT
500 KV TRANSMISSION LINE DESIGN
PLAN & PROFILE SHEET

SCALE: AS SHOWN DRAWING No. NHC-TLD-001 SHEET 3 OF 4 CONT'D REV D

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ELEM. REF. FILE: T:1
PLOT SCALE: 1:1

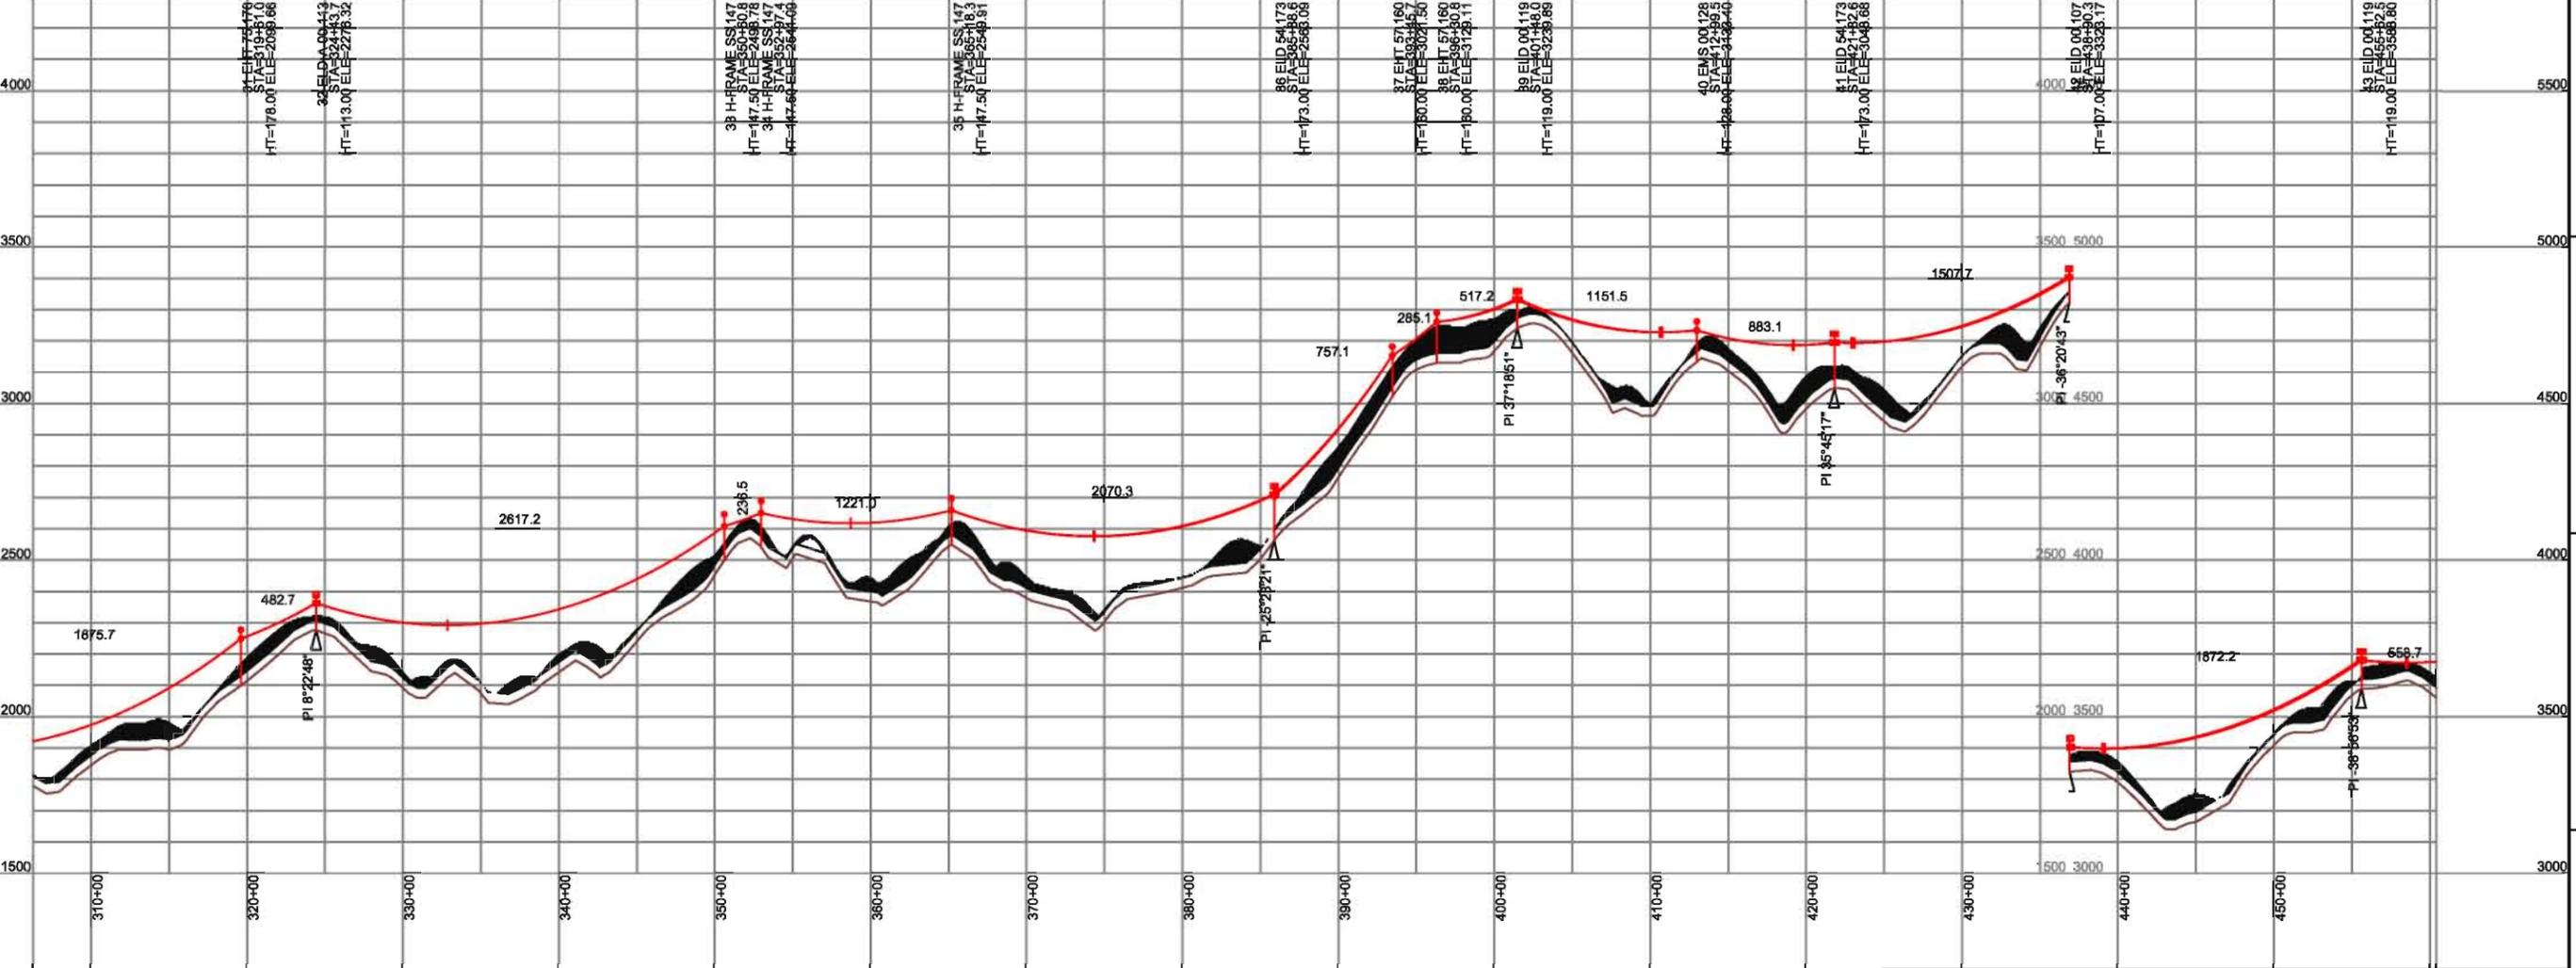


- LEGEND**
- STRUCTURE
 - 5 STRUCTURE NUMBER
 - SPOTTING CONSTRAIN
 - cagnfch27_00_polygon

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9/10/2008
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500.0 FT. HORIZ. SCALE
250.0 FT. VERT. SCALE

43+43.68	31	324+43.68	8°22'48"
43+43.68	32	324+43.68	8°22'48"
43+43.68	33	324+43.68	8°22'48"
43+43.68	34	324+43.68	8°22'48"
43+43.68	35	324+43.68	8°22'48"
43+43.68	36	385+88.60	-25°28'21"
43+43.68	37	401+48.04	37°16'51"
43+43.68	38	421+82.63	35°45'17"
43+43.68	39	436+90.30	-36°20'43"
43+43.68	40	456+02.47	-36°30'53"



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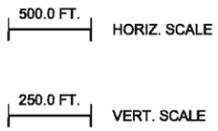
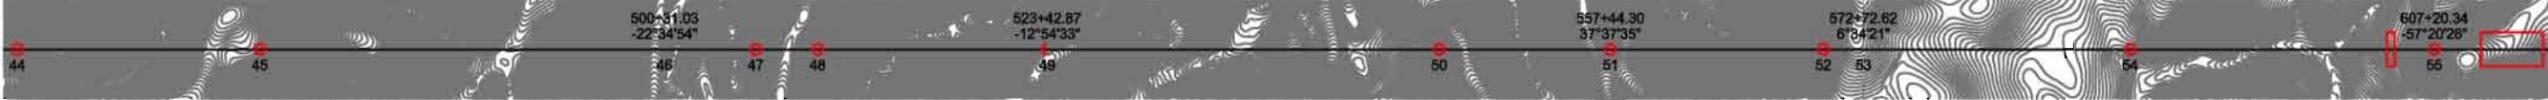
TITLE
NEVADA HYDRO COMPANY
LAKE ELSINORE ADVANCED PUMPED STORAGE PROJECT
500 KV TRANSMISSION LINE DESIGN
PLAN & PROFILE SHEET

SCALE AS SHOWN DRAWING No. NHC-TLD-001 SHEET 4 CONTD 5 REV D

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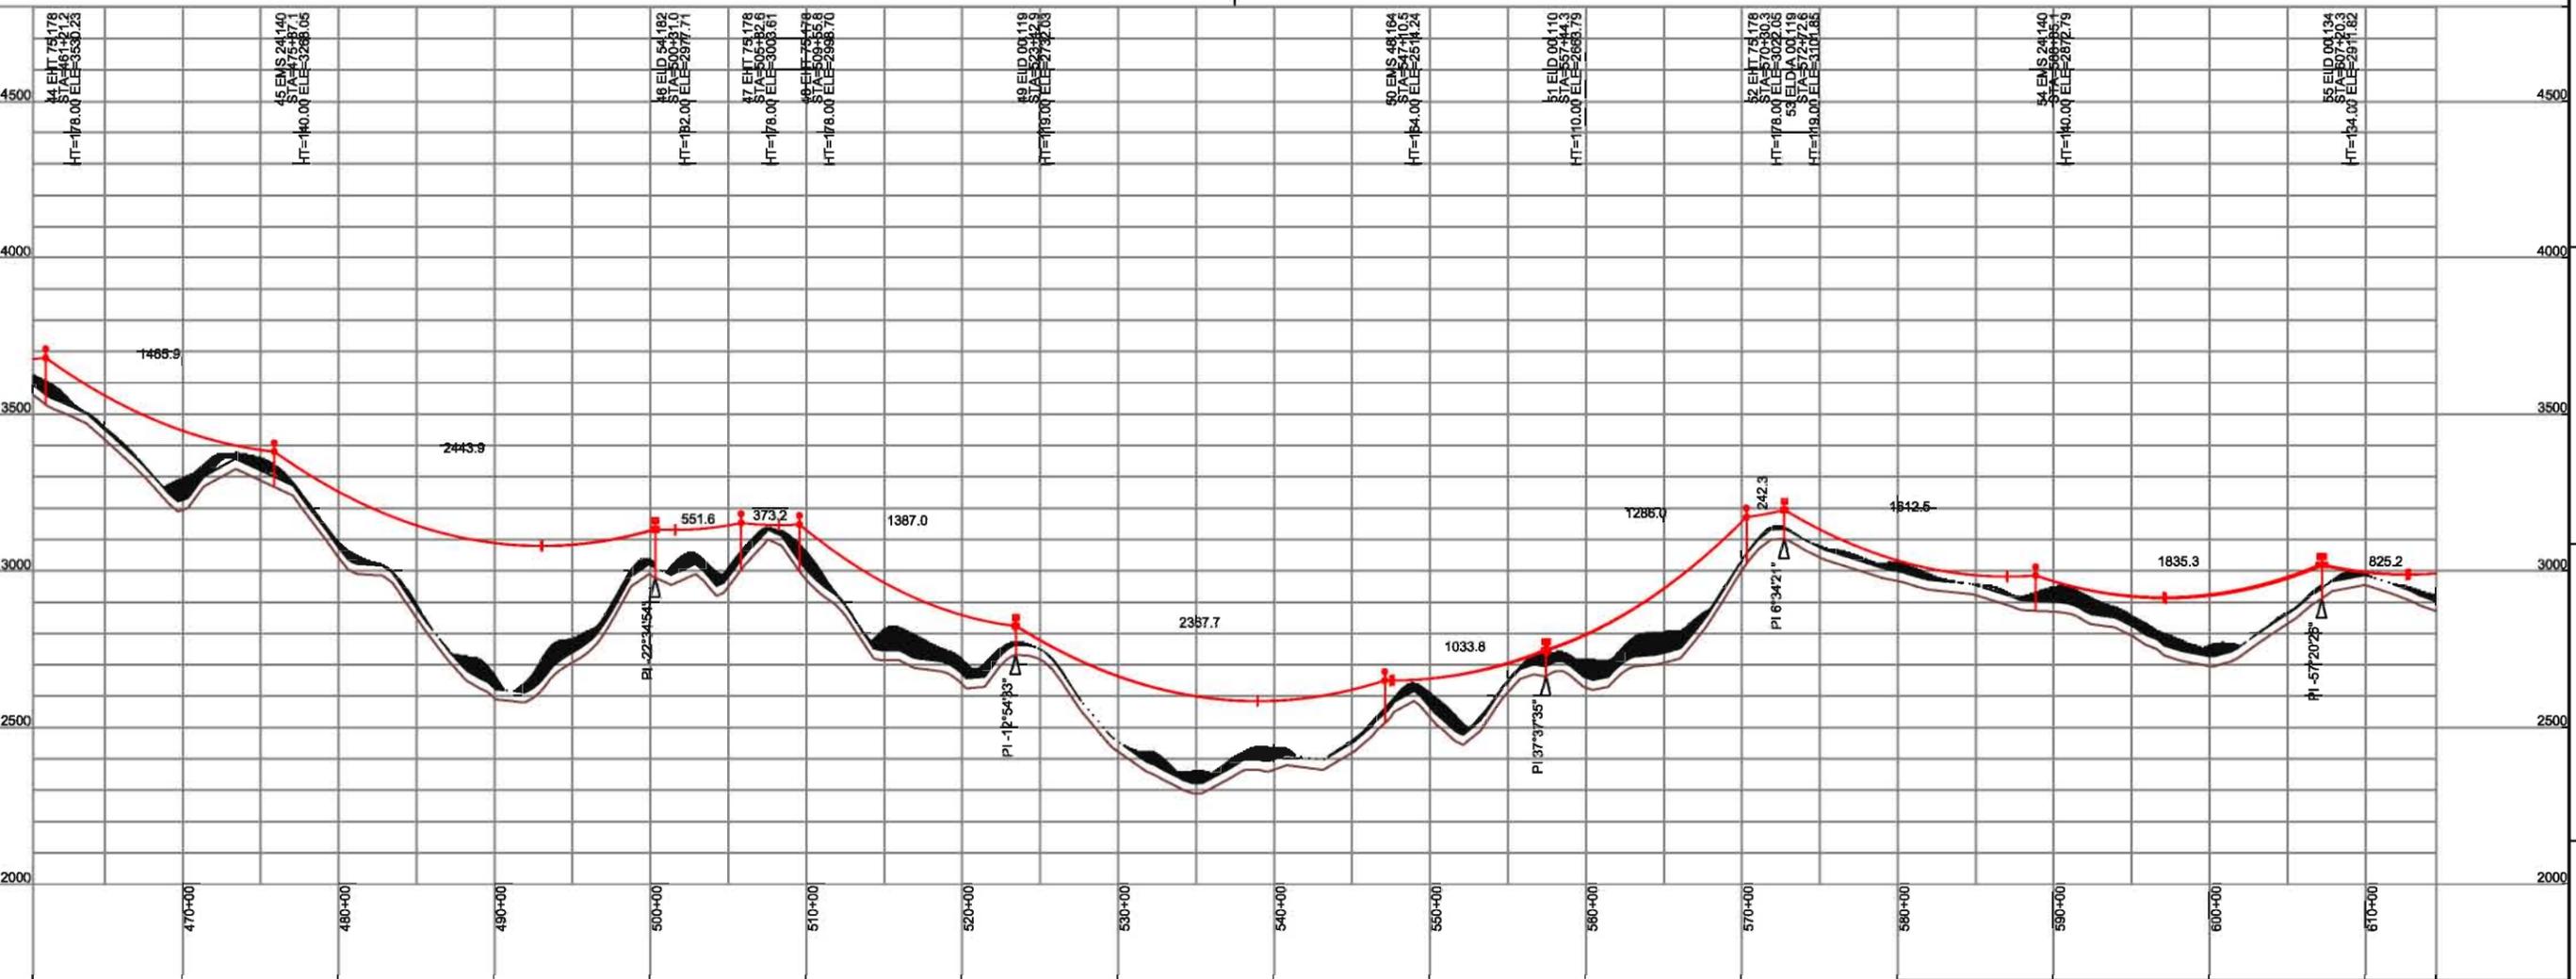
ELEM. REF. FILE: T:1
PLOT SCALE: 1:1



44	45	46	47	48	49	50	51	52	53	54	55	56
500+31.03	500+31.03	500+31.03	500+31.03	500+31.03	500+31.03	500+31.03	500+31.03	500+31.03	500+31.03	500+31.03	500+31.03	500+31.03
-22°34'54"	-22°34'54"	-22°34'54"	-22°34'54"	-22°34'54"	-22°34'54"	-22°34'54"	-22°34'54"	-22°34'54"	-22°34'54"	-22°34'54"	-22°34'54"	-22°34'54"

- LEGEND**
- STRUCTURE
 - 5 STRUCTURE NUMBER
 - SPOTTING CONSTRAIN

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A	04/11/08	FOR INFORMATION ONLY	MM	MM	CS	CS	D	06/10/08	DUE TO KEY MAP AND LEGENDS	MM	MM	CS	CS	

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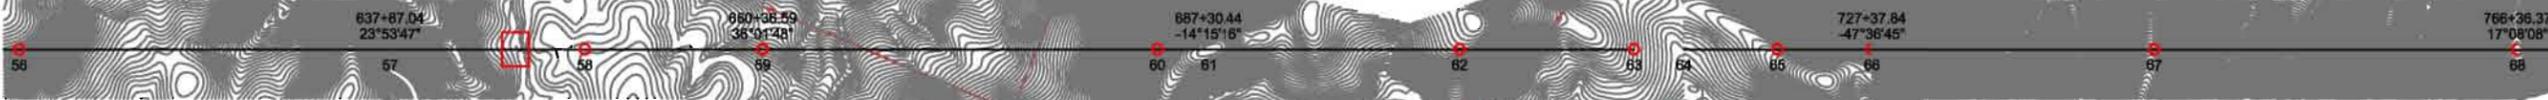
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500 KV TRANSMISSION LINE DESIGN
PLAN & PROFILE SHEET

SCALE: AS SHOWN | DRAWING No.: NHC-TLD-001 | SHEET: 5 | CONTD: 6 | REV: D

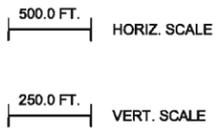
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PLOT SCALE: 1:1

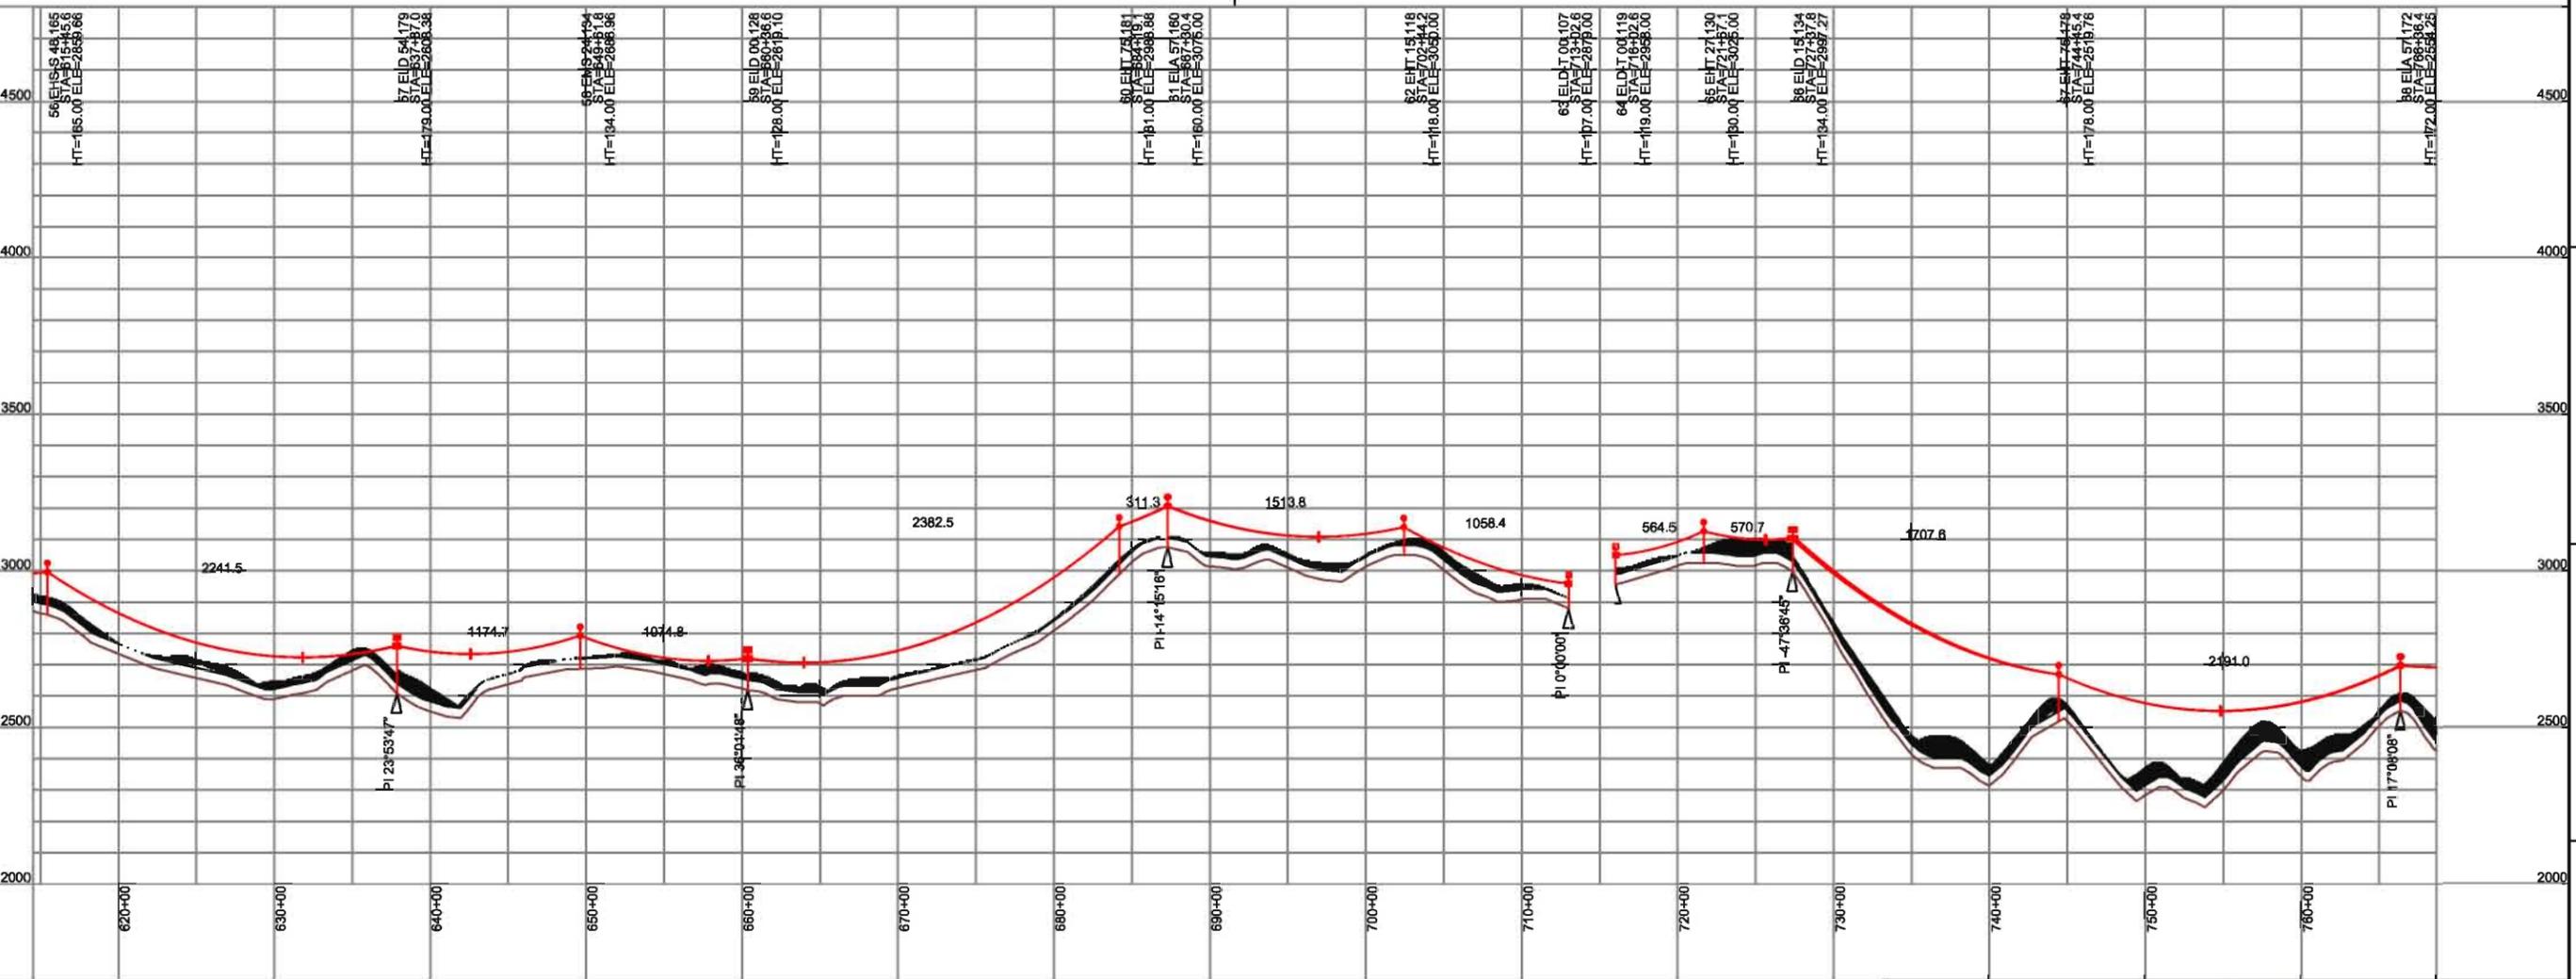


- LEGEND**
- STRUCTURE
 - 5 STRUCTURE NUMBER
 - SPOTTING CONSTRAIN
 - Survey_SECTION LINES
 - Reservoir_Location



56-57 BLUEBIRD ACSR WIR. RULING SPAN 1952 (FT), TENSION 10090 (LBS) AT 60 (DEG F) INITIAL
 57-58 BLUEBIRD ACSR WIR. RULING SPAN 1123 (FT), TENSION 10066 (LBS) AT 60 (DEG F) INITIAL
 58-59 BLUEBIRD ACSR WIR. RULING SPAN 1835 (FT), TENSION 15682 (LBS) AT 60 (DEG F) INITIAL
 59-60 BLUEBIRD ACSR WIR. RULING SPAN 564 (FT), TENSION 20815 (LBS) AT 60 (DEG F) INITIAL
 60-61 BLUEBIRD ACSR WIR. RULING SPAN 1641 (FT), TENSION 15955 (LBS) AT 60 (DEG F) INITIAL

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 9/10/2008
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A	04/11/08	FOR INFORMATION ONLY	MM	MM	CS	CS	D	06/10/08	DUE TO KEY MAP AND LEGENDS	MM	MM	CS	CS

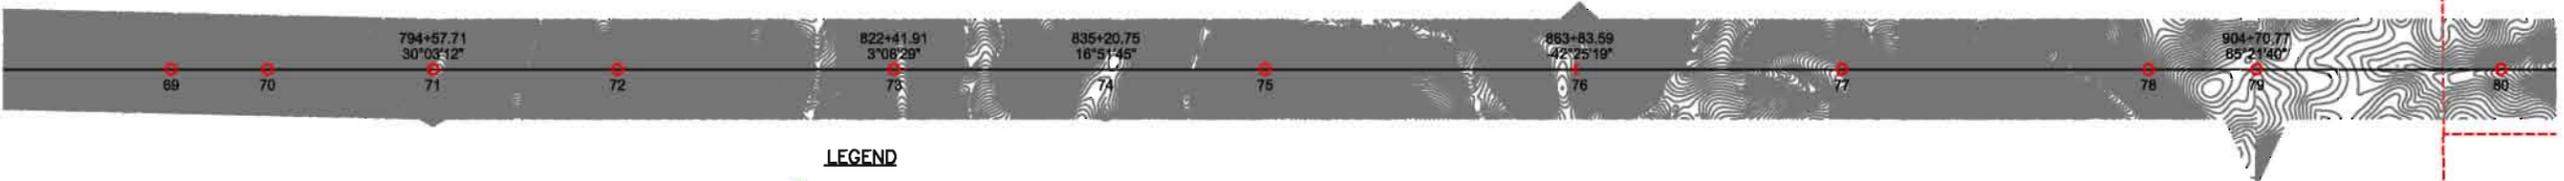
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<input type="checkbox"/>	FOR CONSTRUCTION
<input type="checkbox"/>	FOR RECORD

SAE TOWERS

TITLE: NEVADA HYDRO COMPANY
 LAKE ELSINORE ADVANCED PUMPED STORAGE PROJECT
 500 KV TRANSMISSION LINE DESIGN
 PLAN & PROFILE SHEET

SCALE: AS SHOWN DRAWING No. NHC-TLD-001 SHEET 6 CONTD 7 REV D

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 ELEV. REF. FILE: T:1
 PLOT SCALE: 1:1

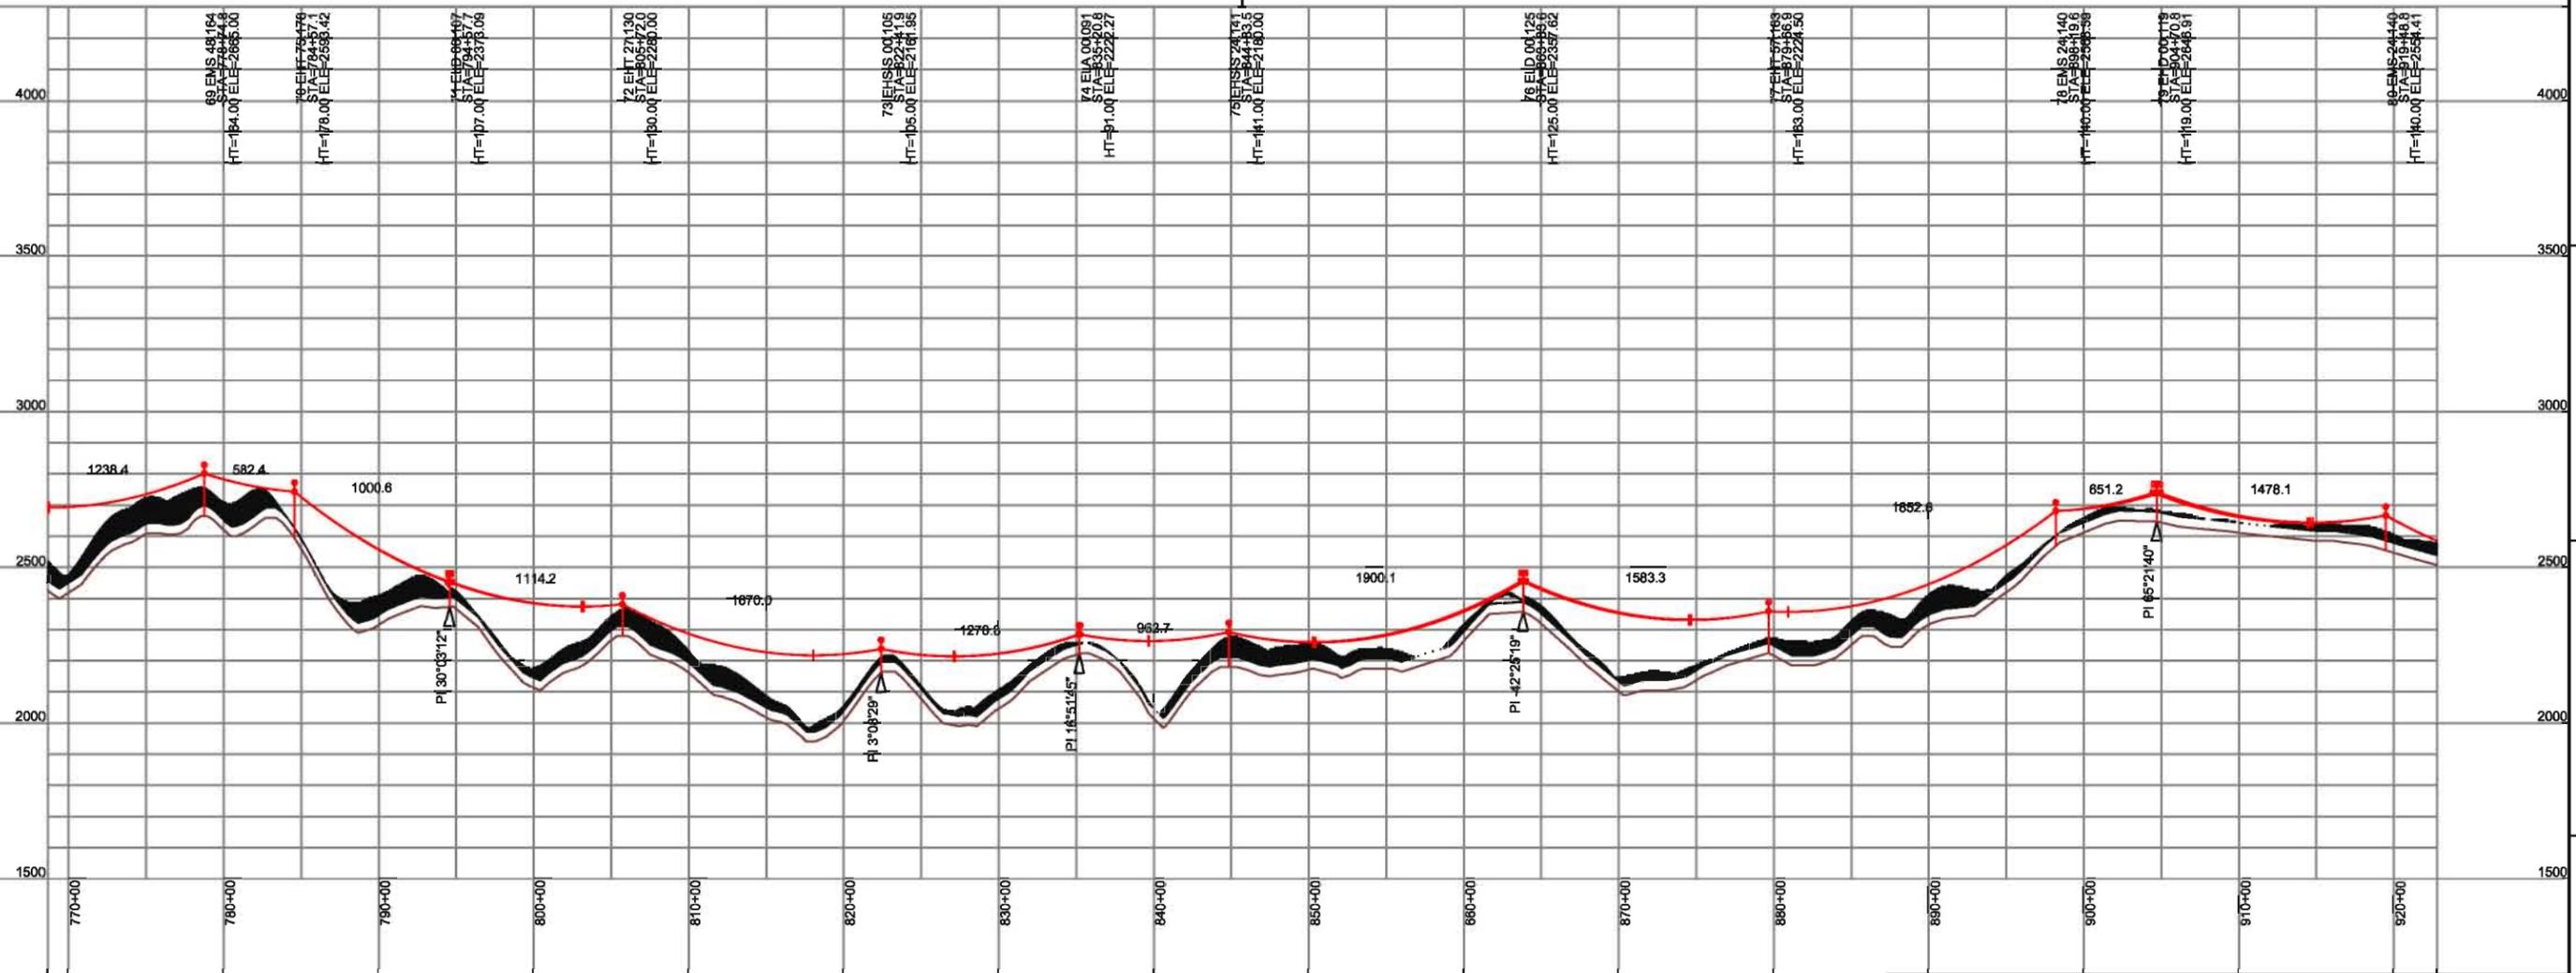


- LEGEND**
- STRUCTURE
 - 5 STRUCTURE NUMBER
 - SPOTTING CONSTRAINT
 - Survey_SECTION LINES

500.0 FT. HORIZ. SCALE
 250.0 FT. VERT. SCALE

66 - 71, BLUEBIRD_ACSR_WIR, RULING SPAN 1641 (FT), TENSION 1595 (LBS) AT 60 (DEG F) INITIAL
 71 - 76, BLUEBIRD_ACSR_WIR, RULING SPAN 1509 (FT), TENSION 1752 (LBS) AT 60 (DEG F) INITIAL
 76 - 79, BLUEBIRD_ACSR_WIR, RULING SPAN 1595 (FT), TENSION 1684 (LBS) AT 60 (DEG F) INITIAL
 79 - 81, BLUEBIRD_ACSR_WIR, RULING SPAN 2103 (FT), TENSION 16135 (LBS) AT 60 (DEG F) INITIAL

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 9/10/2008
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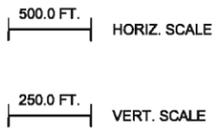
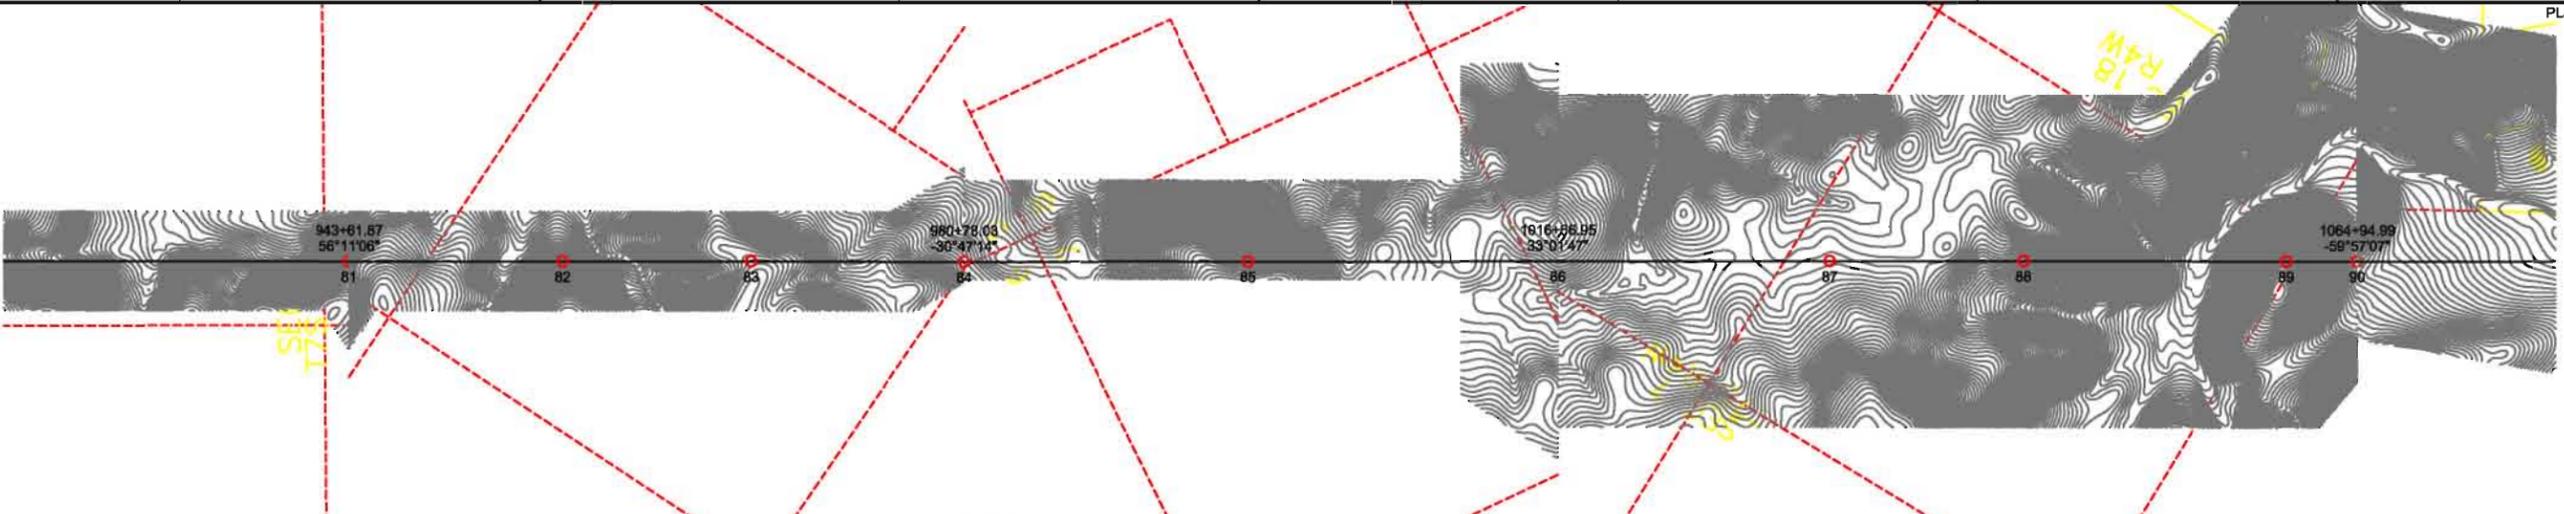
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TITLE: NEVADA HYDRO COMPANY
 LAKE ELSINORE ADVANCED PUMPED STORAGE PROJECT
 500 KV TRANSMISSION LINE DESIGN
 PLAN & PROFILE SHEET

SCALE: AS SHOWN DRAWING No. NHC-TLD-001 SHEET 7 OF 8 CONT'D 8 REV D

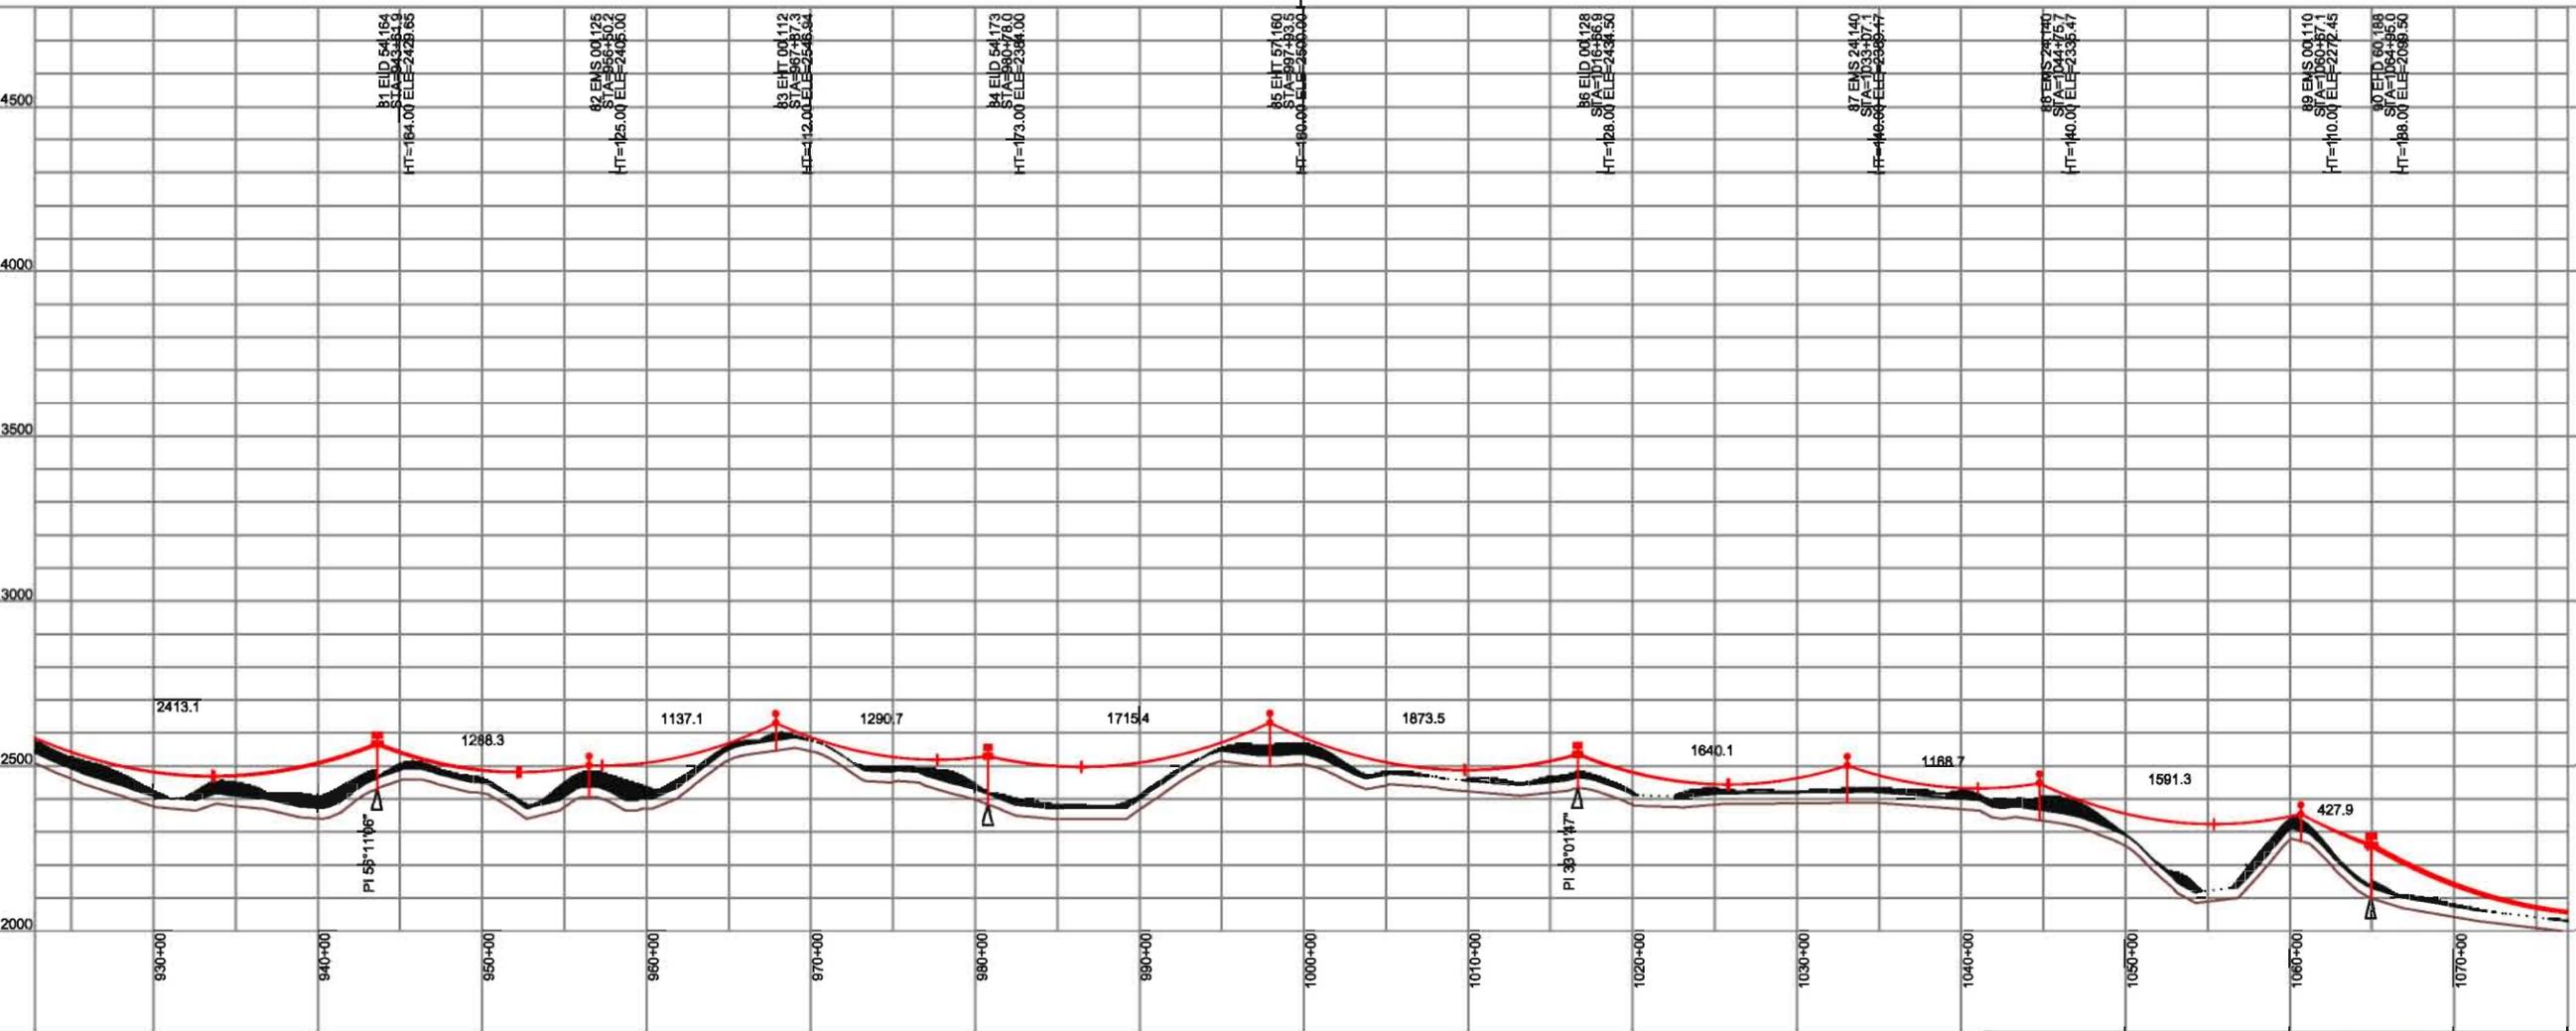
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 ELEV. REF. FILE: T-1
 PLOT SCALE: 1"=1'



NORTH
 81 BLUEBIRD_ACSR_WIP, RULING SPAN 2103 (FT), TENSION 15135 (LBS) AT 60 (DEG) INITIAL
 82 BLUEBIRD_ACSR_WIP, RULING SPAN 1239 (FT), TENSION 15895 (LBS) AT 60 (DEG) INITIAL
 83 BLUEBIRD_ACSR_WIP, RULING SPAN 1794 (FT), TENSION 18895 (LBS) AT 60 (DEG) INITIAL
 84 BLUEBIRD_ACSR_WIP, RULING SPAN 1443 (FT), TENSION 17735 (LBS) AT 60 (DEG) INITIAL
 85 BLUEBIRD_ACSR_WIP, RULING SPAN 2508 (FT), TENSION 15844 (LBS) AT 60 (DEG) INITIAL
 86 EHT 001125 STA=967+80.2 ELE=2405.00 HT=125.00
 87 EHT 001126 STA=997+87.3 ELE=2406.00 HT=125.00
 88 EHT 001127 STA=997+87.3 ELE=2406.00 HT=125.00
 89 EHT 001128 STA=997+87.3 ELE=2406.00 HT=125.00
 90 EHT 001129 STA=997+87.3 ELE=2406.00 HT=125.00

- LEGEND**
- STRUCTURE
 - 5 STRUCTURE NUMBER
 - SPOTTING CONSTRAIN
 - Survey_SECTION LINES

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9/10/2008
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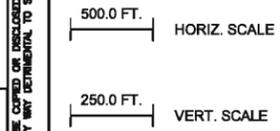
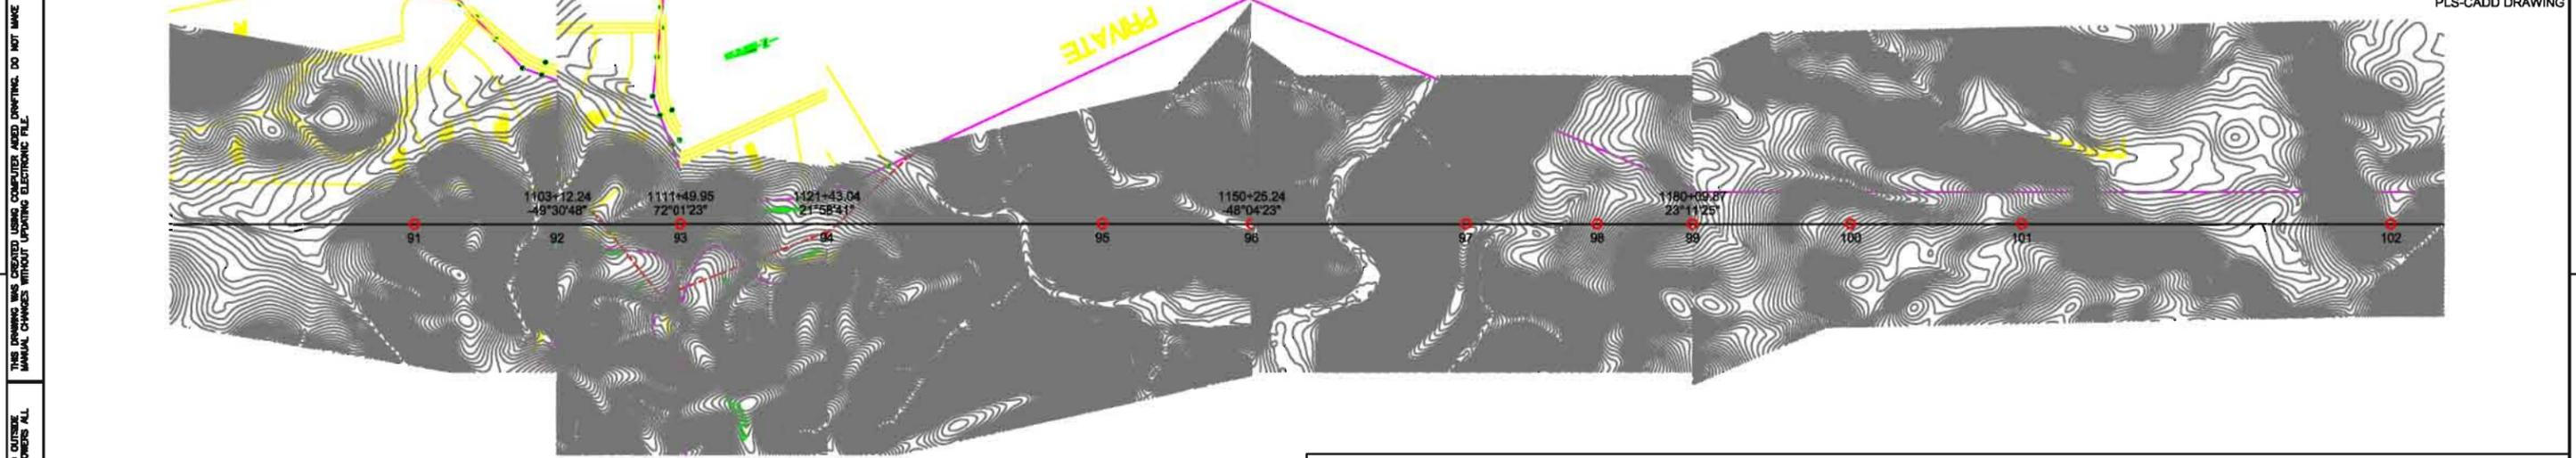
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A	04/11/08	FOR INFORMATION ONLY	MM	MM	CS	CS	D	06/10/08	DUE TO KEY MAP AND LEGENDS	MM	MM	CS	CS	C. SUTOR

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 PLAN & PROFILE SHEET

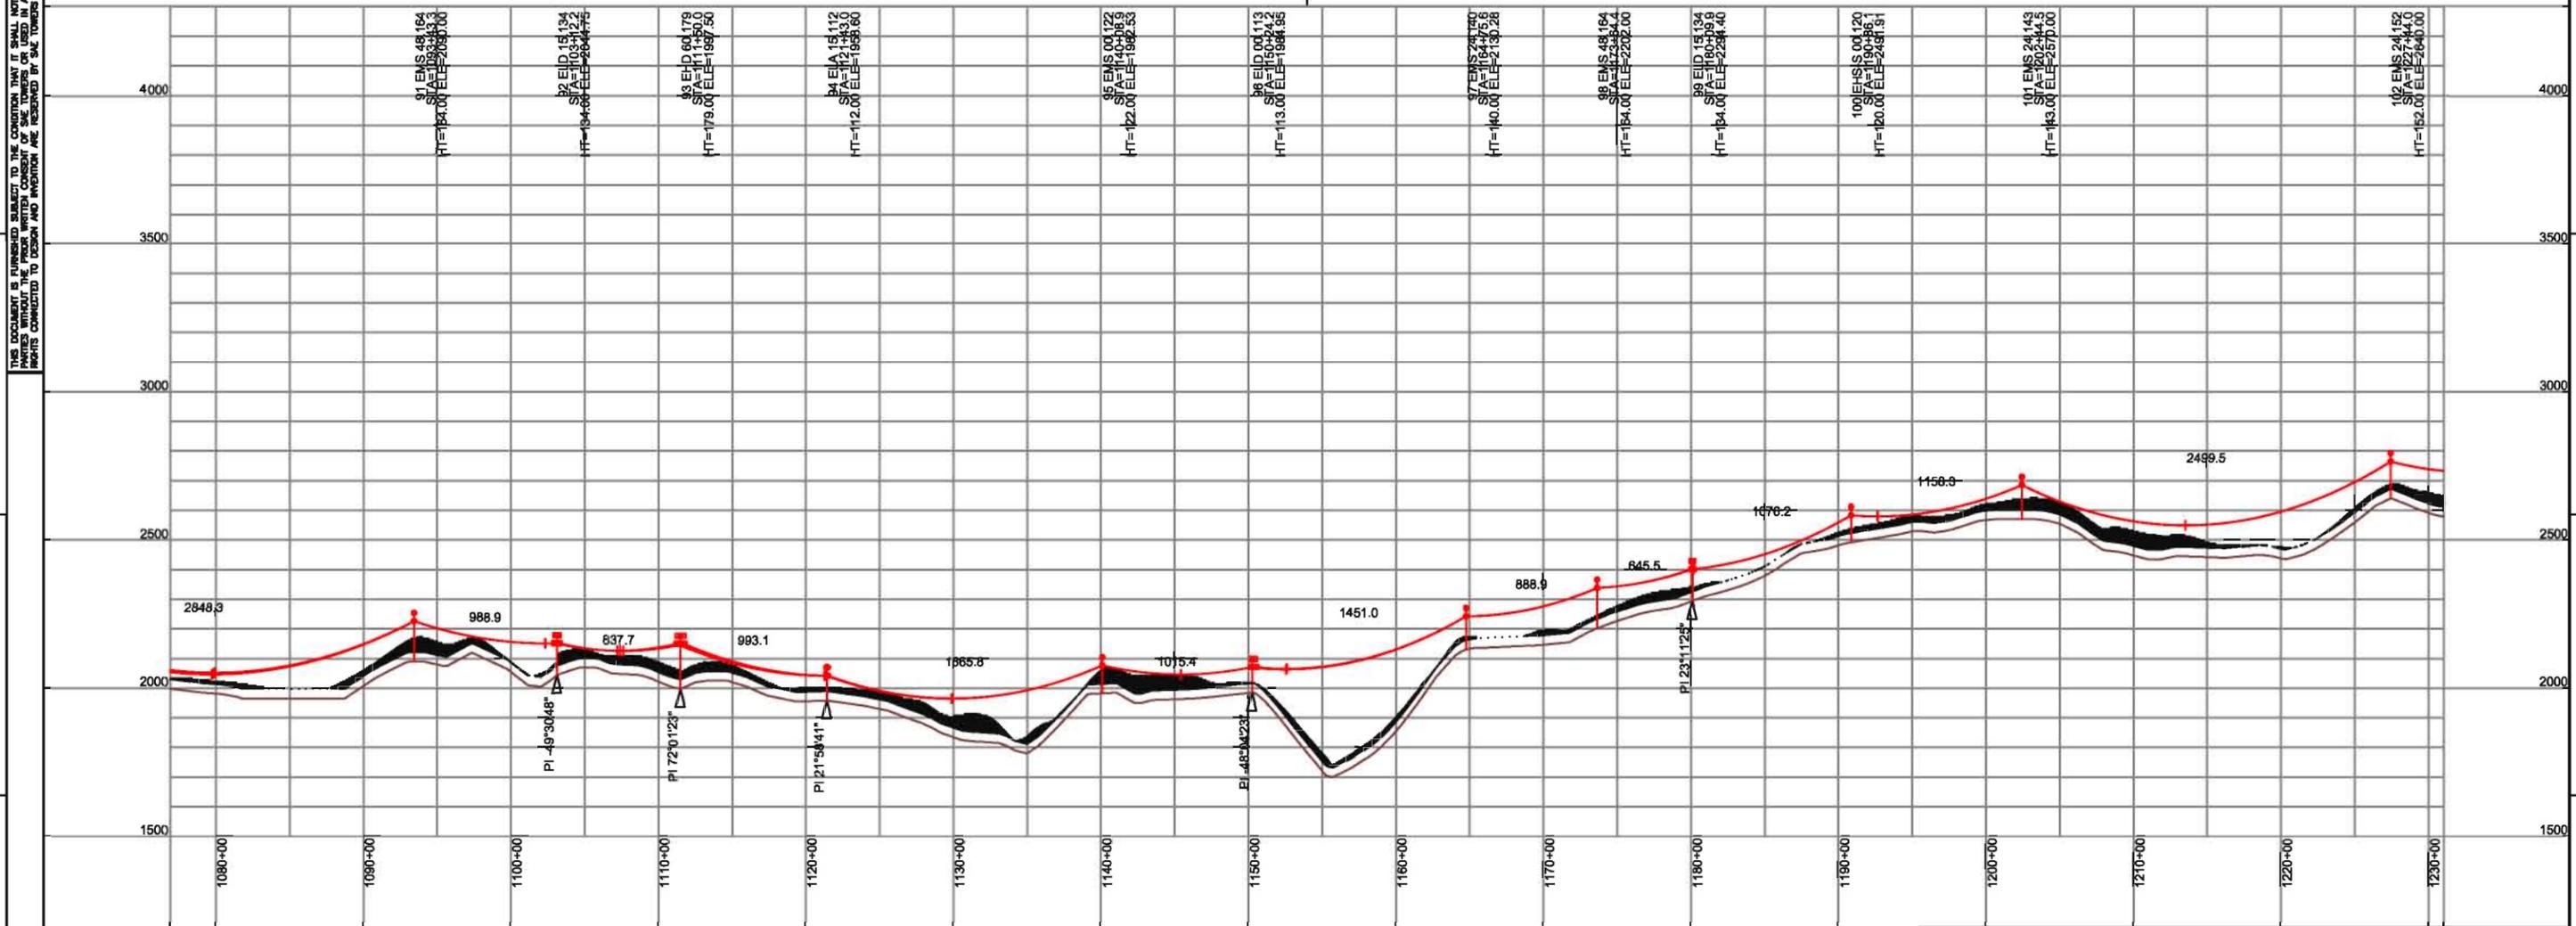
SCALE: AS SHOWN DRAWING No. NHC-TLD-001 SHEET 8 CONTD 9 REV D



90-92, BLUEBIRD_ACSR.WIR, RULING SPAN 2596 (FT), TENSION 15646 (LBS) AT 60 (DEG F) INITIAL
 93-95, BLUEBIRD_ACSR.WIR, RULING SPAN 834 (FT), TENSION 21082 (LBS) AT 60 (DEG F) INITIAL
 96-98, BLUEBIRD_ACSR.WIR, RULING SPAN 1481 (FT), TENSION 17957 (LBS) AT 60 (DEG F) INITIAL
 99-101, BLUEBIRD_ACSR.WIR, RULING SPAN 1152 (FT), TENSION 19359 (LBS) AT 60 (DEG F) INITIAL
 102-107, BLUEBIRD_ACSR.WIR, RULING SPAN 1820 (FT), TENSION 19569 (LBS) AT 60 (DEG F) INITIAL

- LEGEND**
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 - Survey_SECTION LINES

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C	08/04/08	ALTERNATIVE LOCATIONS	MM	MM	CS	CS								
B	05/15/08	SPOTTING BASED ON LEAPS TOPO BASE	MM	MM	CS	CS								
A	04/11/08	FOR INFORMATION ONLY	MM	MM	CS	CS	D	06/10/08	DUE TO KEY MAP AND LEGENDS	MM	MM	CS	CS	

SAE TOWERS

TITLE: NEVADA HYDRO COMPANY
 LAKE ELSINORE ADVANCED PUMPED STORAGE PROJECT
 500 KV TRANSMISSION LINE DESIGN
 PLAN & PROFILE SHEET

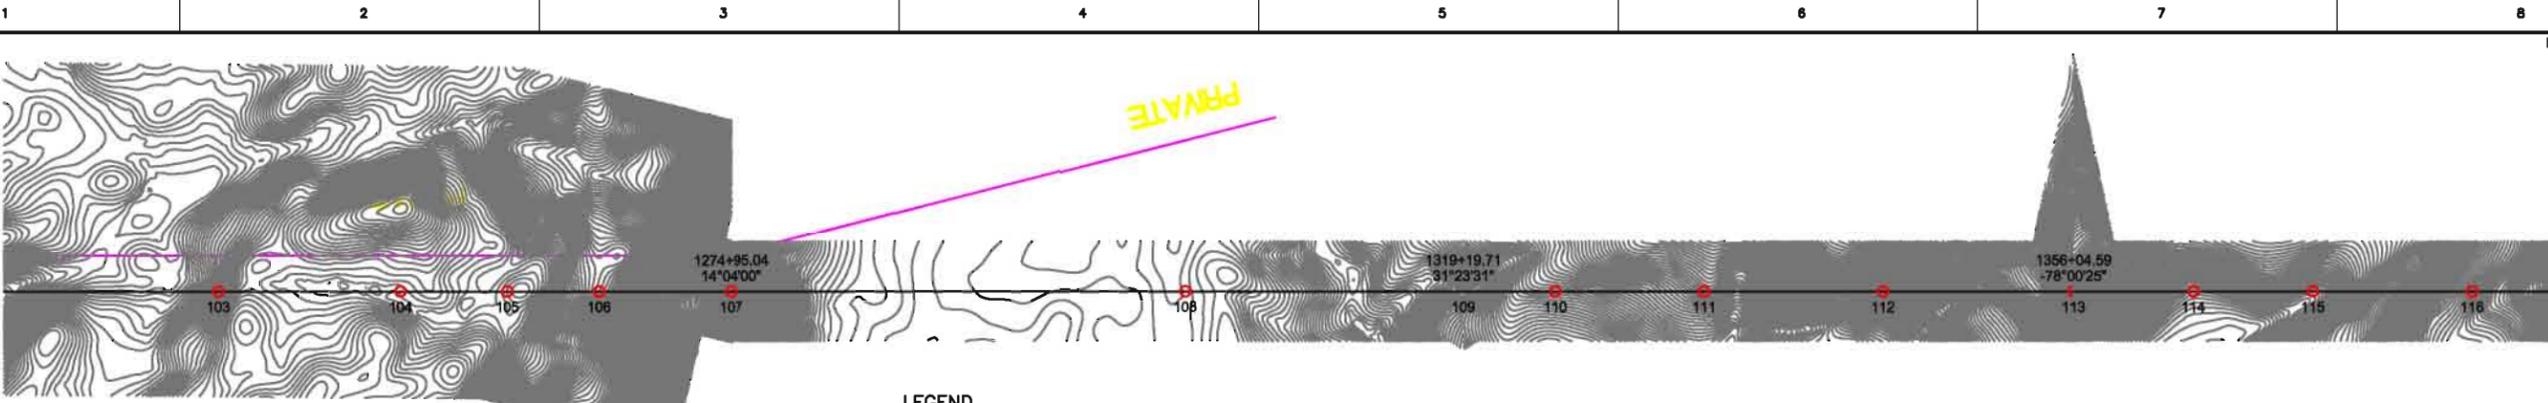
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ELE. REF. FILE: T:1
 PLOT SCALE: 1:1

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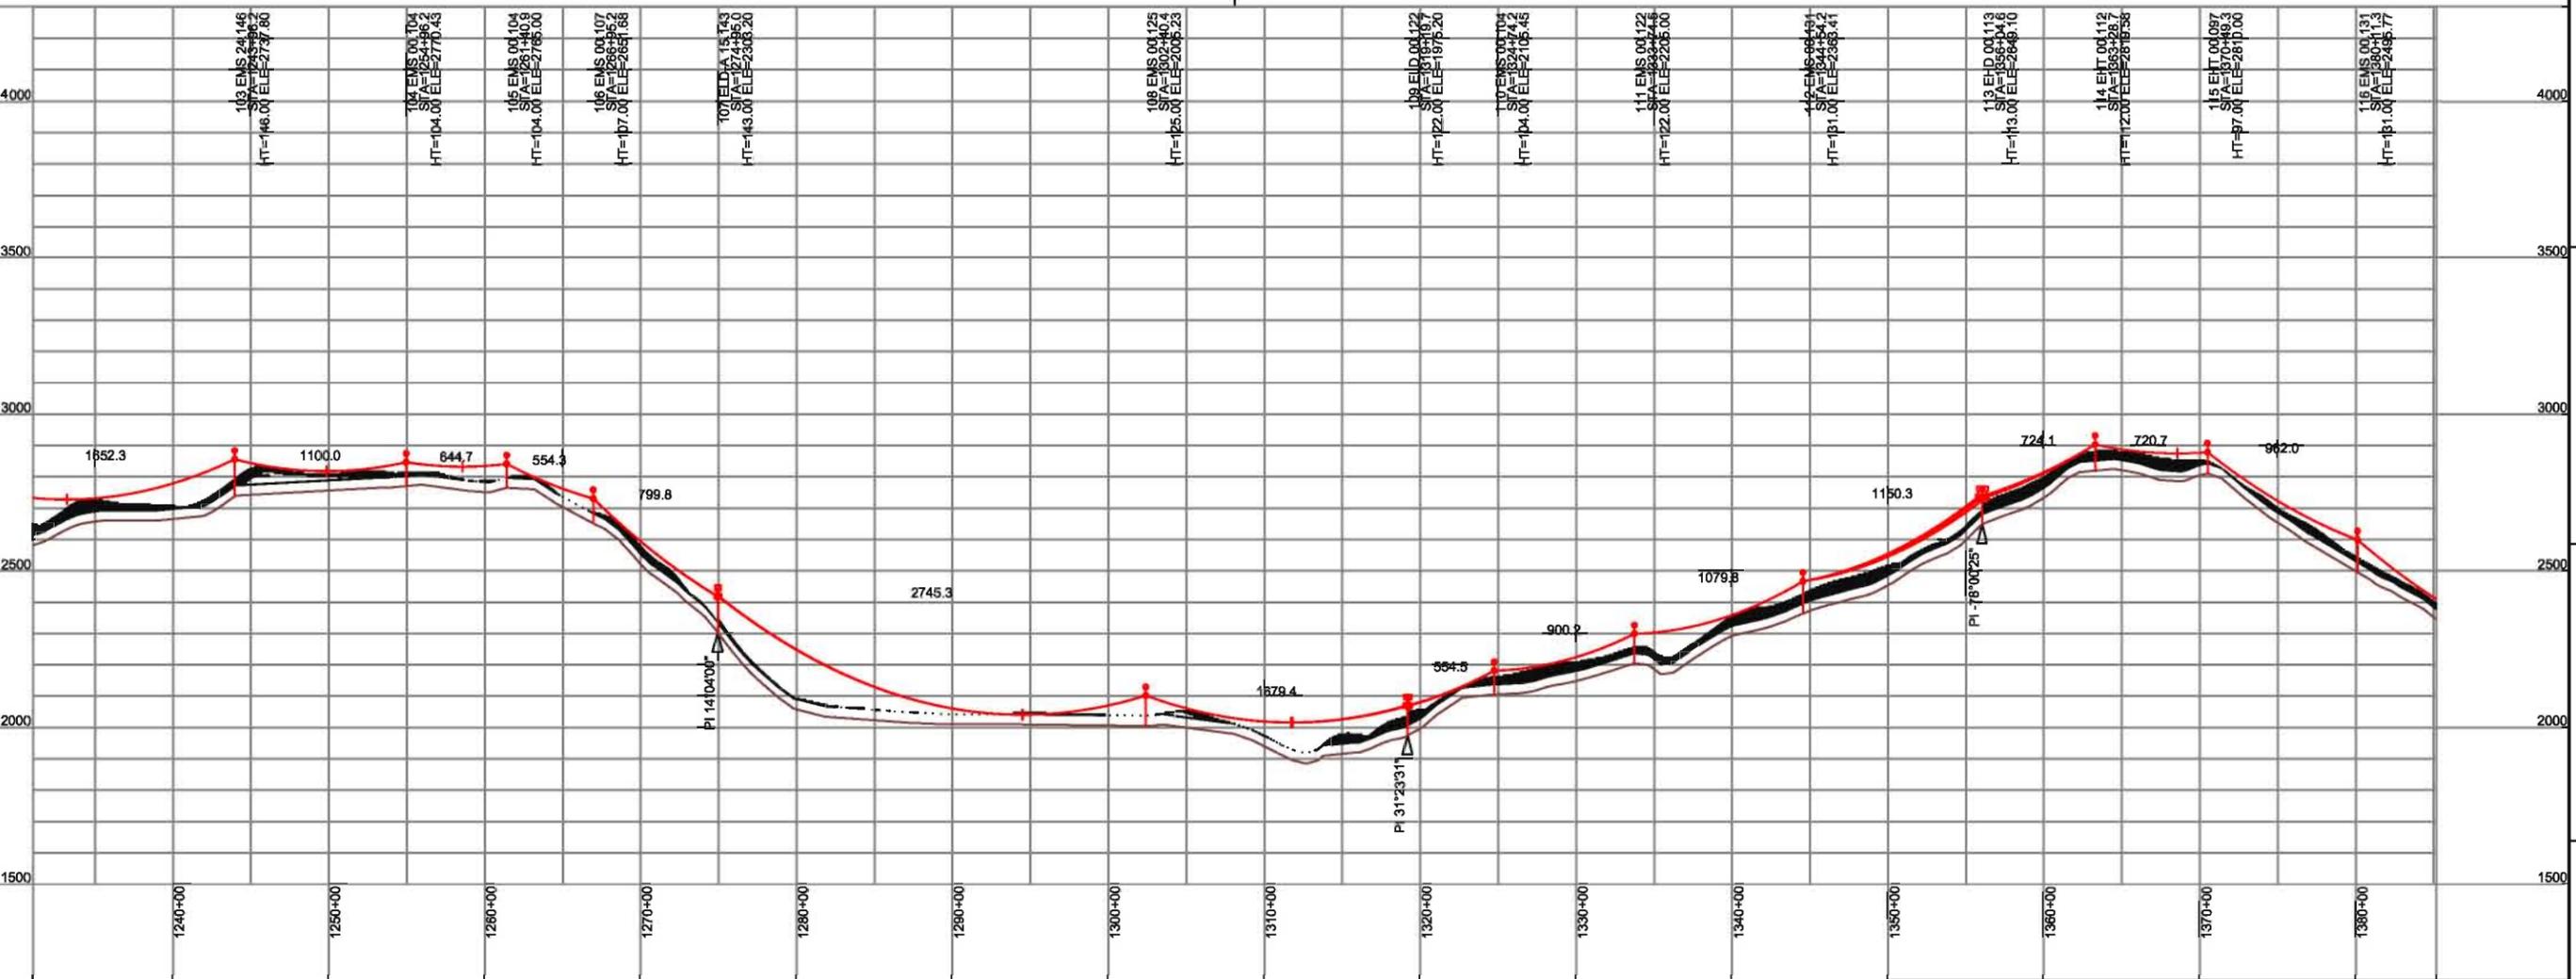


- LEGEND**
- STRUCTURE
 - 5 STRUCTURE NUMBER
 - SPOTTING CONSTRAIN
 - Survey_SECTION LINES

LEAPS SAE R091008
9/10/2008
PAGE 9/11

500.0 FT. HORIZ. SCALE
250.0 FT. VERT. SCALE

99 - 107, BLUEBIRD ACSR WIR, RULING SPAN 1620 (FT), TENSION 15569 (LBS) AT 60 (DEG F) INITIAL
107 - 109, BLUEBIRD ACSR WIR, RULING SPAN 2383 (FT), TENSION 15200 (LBS) AT 60 (DEG F) INITIAL
109 - 113, BLUEBIRD ACSR WIR, RULING SPAN 982 (FT), TENSION 19846 (LBS) AT 60 (DEG F) INITIAL
113 - 118, BLUEBIRD ACSR WIR, RULING SPAN 2016 (FT), TENSION 15443 (LBS) AT 60 (DEG F) INITIAL



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C	06/04/08	ALTERNATIVE LOCATIONS	MM	MM	CS	CS								
B	05/15/08	SPOTTING BASED ON LEAPS TOPO BASE	MM	MM	CS	CS								
A	04/11/08	FOR INFORMATION ONLY	MM	MM	CS	CS	D	06/10/08	DUE TO KEY MAP AND LEGENDS	MM	MM	CS	CS	C. SUTOR

- CONCEPT
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- FOR MANUFACTURE
- FOR CONSTRUCTION
- FOR RECORD

SAE TOWERS

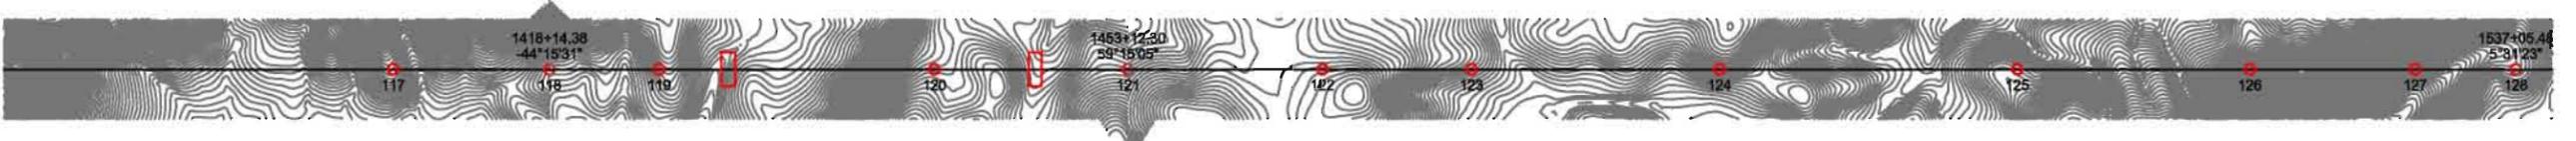
TITLE: NEVADA HYDRO COMPANY
LAKE ELSINORE ADVANCED PUMPED STORAGE PROJECT
500 KV TRANSMISSION LINE DESIGN
PLAN & PROFILE SHEET

SCALE: AS SHOWN DRAWING No. NHC-TLD-001 SHEET 10 OF 11 REV D

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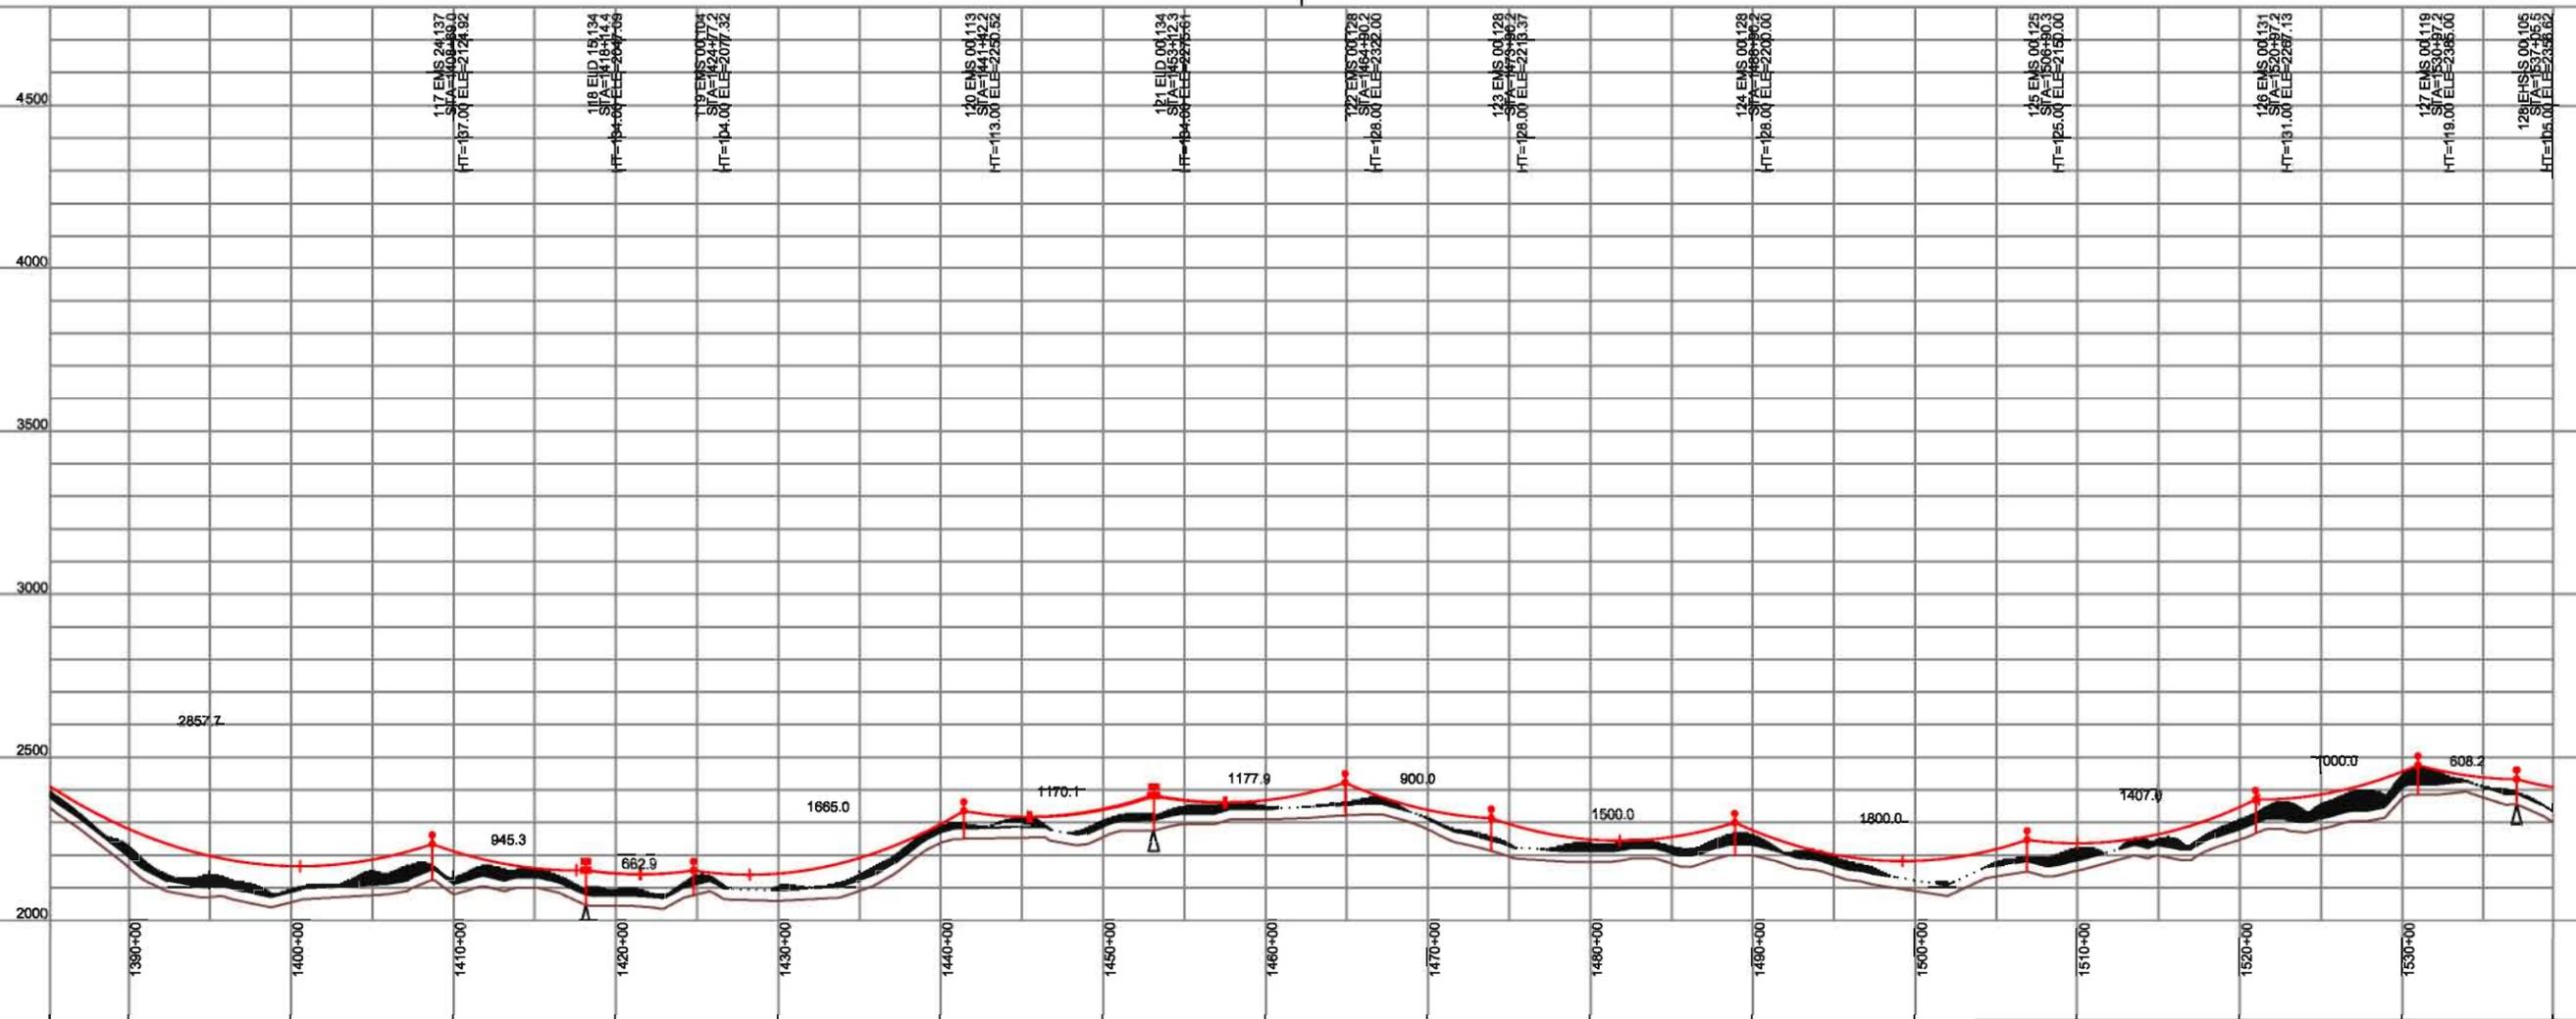
LEAPS SAE R091008
9/10/2008
PAGE 10/11

500.0 FT. HORIZ. SCALE
250.0 FT. VERT. SCALE

113 - 118, BLUEBIRD ACSR WIR, RULING SPAN 2016 (FT), TENSION 15443 (LBS) AT 60 (DEG F) INITIAL
118 - 121, BLUEBIRD ACSR WIR, RULING SPAN 1388 (FT), TENSION 18132 (LBS) AT 60 (DEG F) INITIAL
121 - 130, BLUEBIRD ACSR WIR, RULING SPAN 1386 (FT), TENSION 18094 (LBS) AT 60 (DEG F) INITIAL

← NORTH

← NORTH



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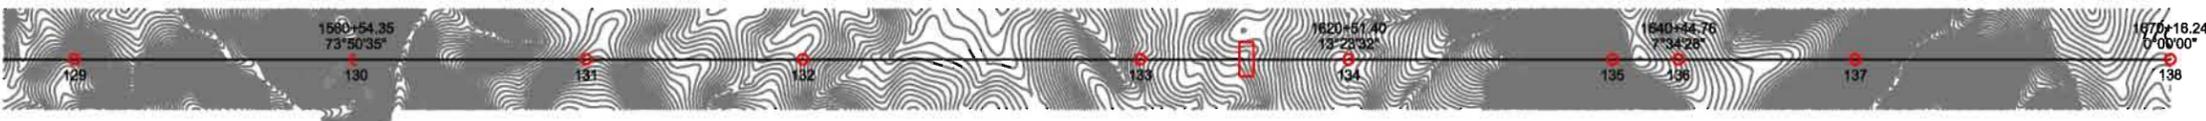
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SCALE	AS SHOWN	DRAWING No.	NHC-TLD-001
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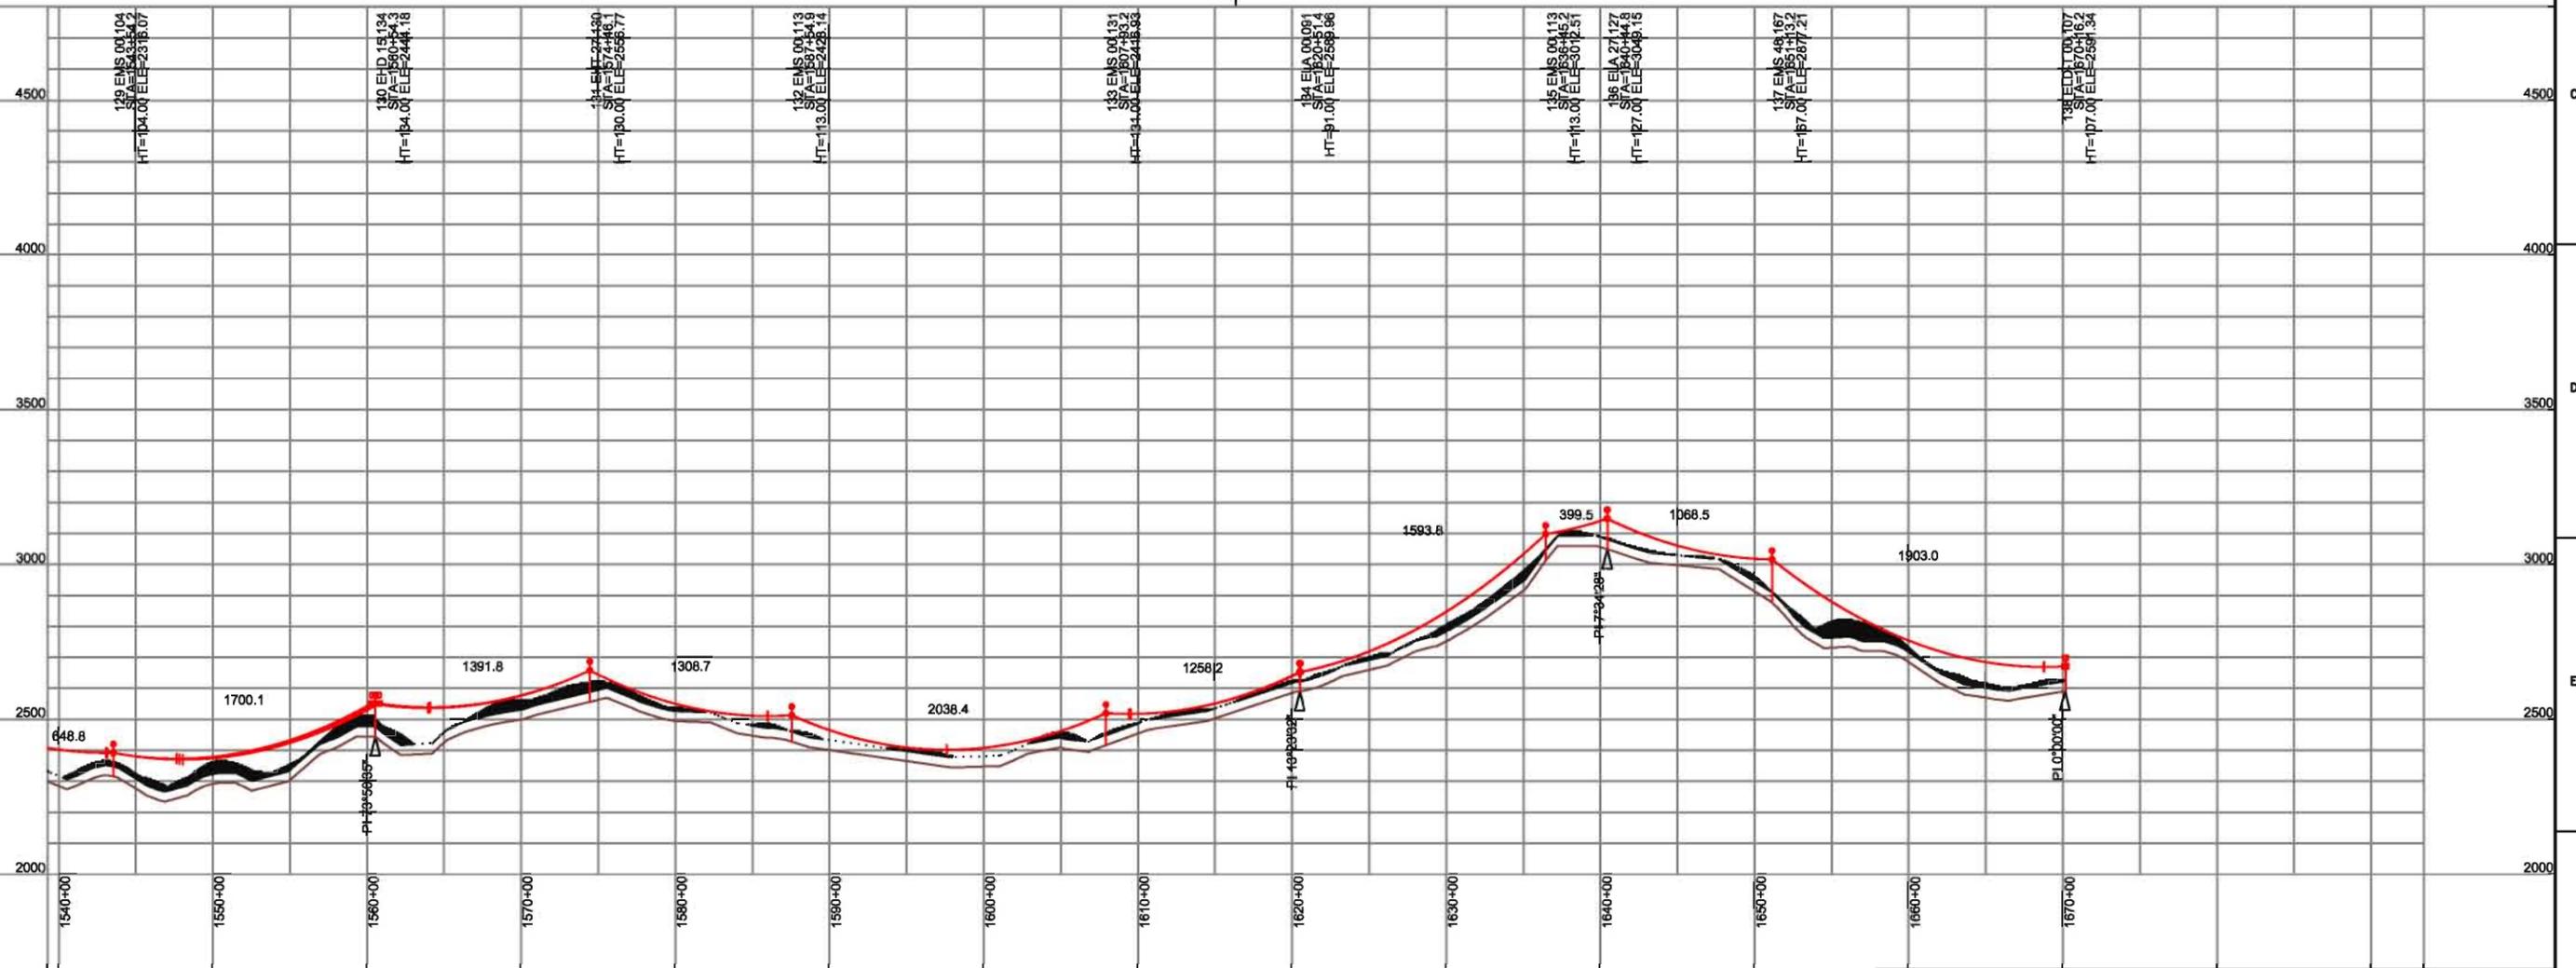


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- STRUCTURE
 - 5 STRUCTURE NUMBER
 - SPOTTING CONSTRAIN

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9/10/2008
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500.0 FT. HORIZ. SCALE
250.0 FT. VERT. SCALE

129 BLUEBIRD_ACSR WIR, RULING SPAN 1386 (FT), TENSION 18094 (LBS) AT 60 (DEG F) INITIAL
130 BLUEBIRD_ACSR WIR, RULING SPAN 1589 (FT), TENSION 16019 (LBS) AT 60 (DEG F) INITIAL



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LAKE ELSINORE ADVANCED PUMPED STORAGE PROJECT
500 KV TRANSMISSION LINE DESIGN
PLAN & PROFILE SHEET

SCALE: AS SHOWN DRAWING No. NHC-TLD-001 SHEET 12 OF 12 CONT'D - REV D